

SUBJECT: PLANS AND PROPOSAL ADDENDUMS

PROJECT: C 2056-1-42

CONTROL: 2056-01-042

COUNTY: COLLIN

LETTING: 04/05/2023

REFERENCE NO: 0322

PROPOSAL ADDENDUMS

PROPOSAL COVER

BID INSERTS (SH. NO.: ALL)
 GENERAL NOTES (SH. NO.: ALL)

- SPEC LIST (SH. NO.:)
- SPECIAL PROVISIONS:
- ADDED:

DELETED:

- SPECIAL SPECIFICATIONS:
- ADDED:

DELETED:

OTHER: PLAN SHEET AND OTHER CHANGES

DESCRIPTION OF ABOVE CHANGES
(INCLUDING PLANS SHEET CHANGES)

***** BID INSERTS *****

ALL BID INSERT PROPOSAL SHEETS AND E&Q PLAN SHEETS ARE REPLACED AS PART OF THIS ADDENDUM.

REVISED QUANTITIES FOR THE FOLLOWING BID ITEMS:

462-6004, 462-6007, 462-6010, 464-6005

ADDED THE FOLLOWING BID ITEMS:

105-6070, 105-6109, 400-6006

DELETED THE FOLLOWING BID ITEMS:

105-6008, 105-6015.

***** GENERAL NOTES*****

ALL GENERAL NOTES PROPOSAL SHEETS AND PLAN SHEET 13B ARE REPLACED AS PART OF THIS ADDENDUM.

SHEET F: ITEM 105 REVISED NOTE

DESCRIPTION OF ABOVE CHANGES
(INCLUDING PLANS SHEET CHANGES)

(CONTINUED)

***** PLAN SHEET*****

SHEET 2 (INDEX OD SHEET): ADDED NEW SHEETS 305G, 305H, 305I.

SHEET 8 (TYPICAL SECTIONS): REVISED TYPICAL SECTION.


SHEET 13B (GENERAL NOTE): REFER TO GENERAL NOTE CHANGE AS NOTED ABOVE.
REVISED SHEET 13B.

SHEET 14, 14A-14F (E&Q SHEETS): REVISED SHEETS AS DESCRIBED IN THE BID
INSERTS OF THE PROPOSAL.

SHEET 17, 18, 20: REVISED SUMMARY SHEETS AS DESCRIBED IN THE BID
INSERTS OF THE PROPOSAL.

SHEET 67, 69, 205, 260, 261, 264, 265, 267, 268, 269, 270, 271, 272,
280, 292, 303, 305A, 305B, 305C, 305D, 305E, 305F:
REVISED SHEETS DUE TO THE ABOVE CHANGES.

SHEET 305G, 305H, 305I: ADDED SHEETS DUE TO THE ABOVE CHANGES.

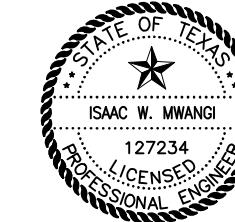

THE STANDARD SHEETS SPECIFICALLY IDENTIFIED ABOVE
HAVE BEEN SELECTED BY ME OR UNDER MY RESPONSIBLE
SUPERVISION AS BEING APPLICABLE TO THIS PROJECT.

Isaac Mwangi 02/02/2023
Signature of Registrant & Date




THE STANDARD SHEETS SPECIFICALLY IDENTIFIED ABOVE
HAVE BEEN SELECTED BY ME OR UNDER MY RESPONSIBLE
SUPERVISION AS BEING APPLICABLE TO THIS PROJECT.

Andrea Klocinski 2/2/2023
Signature of Registrant & Date



THE STANDARD SHEETS SPECIFICALLY IDENTIFIED ABOVE
HAVE BEEN SELECTED BY ME OR UNDER MY RESPONSIBLE
SUPERVISION AS BEING APPLICABLE TO THIS PROJECT.

Kristi R. Guerrero 02/02/2023
Signature of Registrant & Date

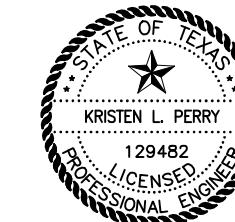

THE STANDARD SHEETS SPECIFICALLY IDENTIFIED ABOVE
HAVE BEEN SELECTED BY ME OR UNDER MY RESPONSIBLE
SUPERVISION AS BEING APPLICABLE TO THIS PROJECT.

Kristen L. Perry 02/02/2023
Signature of Registrant & Date



THE STANDARD SHEETS SPECIFICALLY IDENTIFIED ABOVE
HAVE BEEN SELECTED BY ME OR UNDER MY RESPONSIBLE
SUPERVISION AS BEING APPLICABLE TO THIS PROJECT.

Zach Stone 02/02/23
Signature of Registrant & Date


NO. REVISION BY DATE

REVISION BY DATE

BY DATE

LEGEND

- (1) CONC CURB (MONO)(TY II)
- (2) CONC PVMT (CONT REINF-CRCP) (9.5")
- (3) SP MIXES SP-B PG64-22 (4")
- (4) TACK COAT
- (5) LIME TRT (EXIST MATL)(8")
- (6) DRILL SEEDING AND TOPSOIL (4")
- (7) CONCRETE SIDEWALK (4")
- (8) TY D HANDRAIL
- (9) CURB WALL (SIDEWALK)
- (10) CONC MEDIAN
- (11) RIPRAP (CONC)(4")


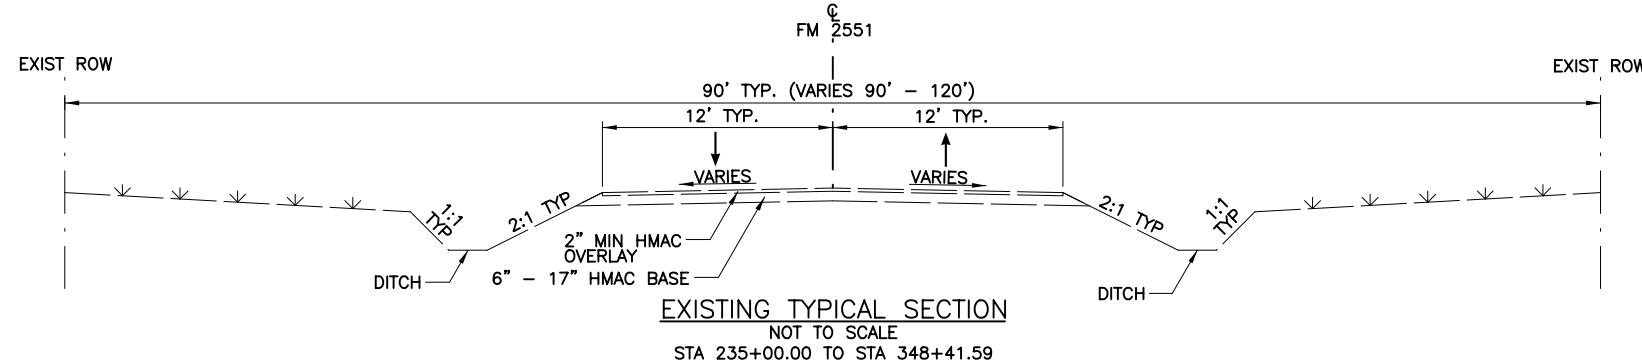


NOTES: (EXISTING SECTIONS)

1. EXISTING PAVEMENT SECTION AND LIMITS ARE APPROXIMATE AND SHOULD BE FIELD VERIFIED.
2. EXISTING INFORMATION IS SHOWN FOR INFORMATIONAL PURPOSES ONLY.
3. REFER TO REMOVAL PLAN FOR ADDITIONAL PAVEMENT INFORMATION.

NOTES: (PROPOSED SECTIONS)

1. TYPICAL SECTIONS ARE APPROXIMATE AND DO NOT REPRESENT ALL SECTIONS AND ALL CONDITIONS.
2. ALL DIMENSIONS ARE FROM FACE OF CURB. SLOPE AND WIDTH INFORMATION ARE TYPICAL AND VARY THROUGHOUT THE PROJECT. SEE PLANS FOR MORE INFORMATION.
3. STATION LIMITS ARE APPROXIMATE. SEE PLANS FOR MORE INFORMATION.
4. EXISTING GROUND SLOPES ARE SHOWN FOR REPRESENTATIONAL PURPOSES ONLY AND ARE BASED ON SURVEY INFORMATION AND MAY DIFFER IN THE FIELD.
5. SEE PLAN SHEETS FOR CONCRETE RIPRAP LOCATIONS.

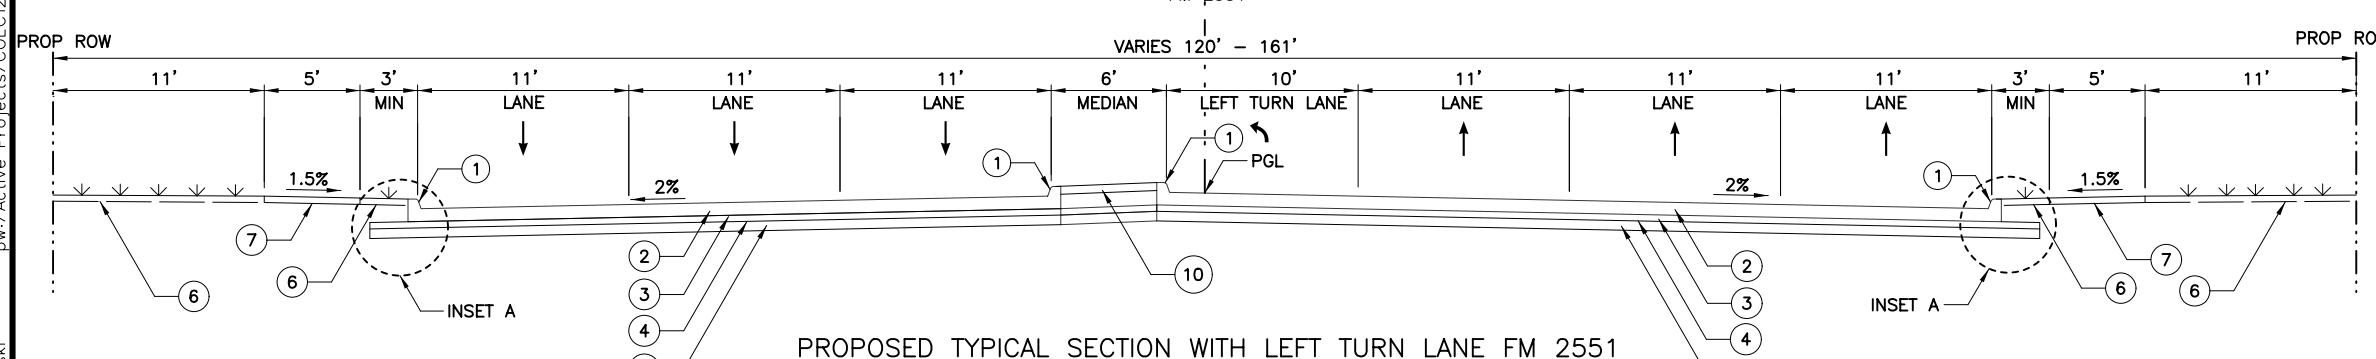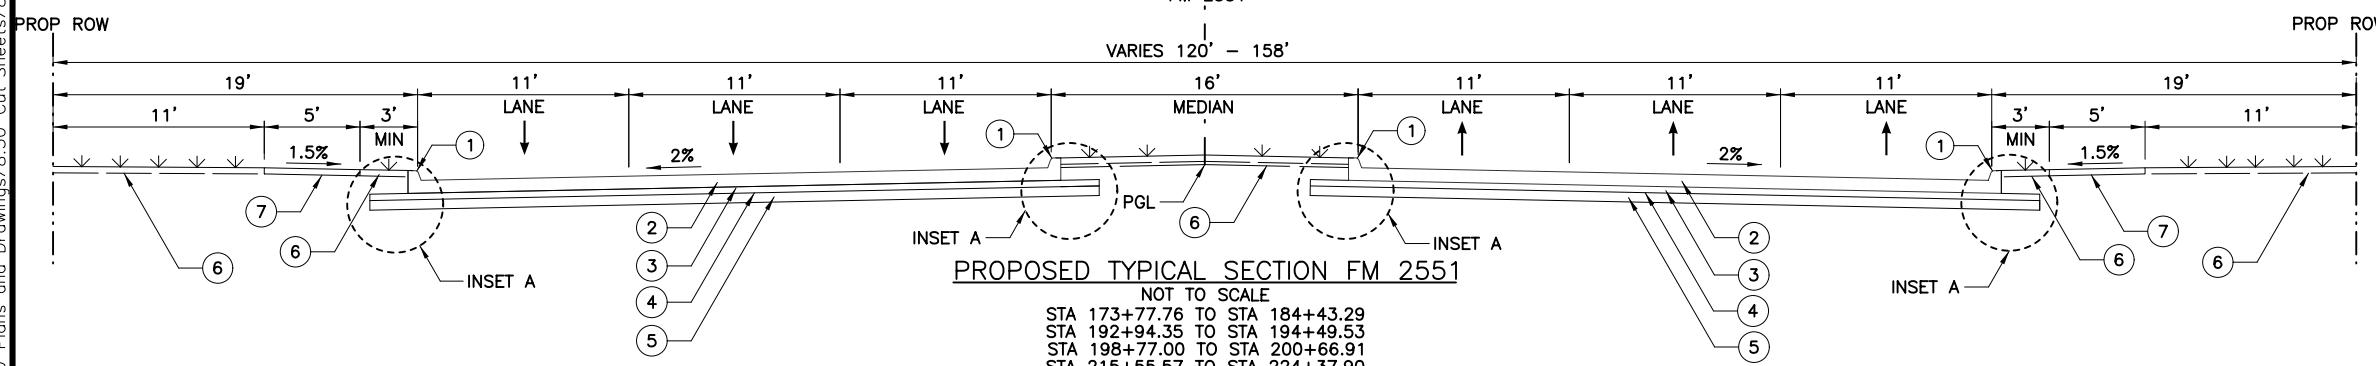

NO.	REVISION	BY	DATE
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TEXAS REGISTERED ENGINEERING FIRM F-1741

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FROM FM 2514 (PARKER ROAD) TO FM 2170 (MAIN STREET)
FM 2551 (MURPHY ROAD)

TYPICAL SECTIONS

⚠ ADDENDUM 1. 3/22/23. REVISED SHEET

Designed:	CPY	FED. RD. DIV. NO.	STATE	PROJECT NO.	HIGHWAY NO.
Checked:	CPY	6	TEXAS	SEE TITLE SHEET	FM 2551
Drawn:		DIST.	COUNTY	CONTROL SECTION NO.	JOB NO.
Checked:	DALLAS	COLLIN	2056	01	042

County: Collin

Highway: FM 2551

Item 6:

Asbestos transite pipe removal required. See SP006-034 for work in the following locations:
 6" water line at STA 232+40 to STA 245+15 (1,370 LF).
 4" water line at STA 245+15 to STA 247+15 (318 LF).

Item 7:

Repair or replace any structures and utilities that might have been damaged by negligence or a failure to have utility locates performed.

Perform all electrical work in accordance with the National Electrical Code and Texas Department of Transportation Specifications.

Consult with appropriate electric company representatives according to their respective area to coordinate electrical services installations.

Contractor will be responsible for all costs associated with locating and/or exposing existing utilities. This includes existing utilities that may have been mismarked by the locator and/or utilities that are in the near vicinity of proposed construction. In addition, this includes all costs associated with pot-holing, mechanical vacuuming, hand-digging, etc. as needed to properly locate and protect all existing utilities.

Holiday restrictions – The Engineer may decide that no lane closures or construction operations shall be allowed during the restricted periods listed in the following holiday schedule. TxDOT has the right to lengthen, shorten, or otherwise modify these restricted periods as actual, or expected, traffic conditions may warrant. Working days will not be charged for these restricted periods. No additional compensation will be allowed for these closures (i.e., overhead, delays, stand-by, barricades or any other associated cost impacts).

- New Year's Eve and Day (5 am on December 31 thru 10:00 pm January 1)
- Easter Holiday weekend (5 am on Friday thru 10:00 pm Sunday)
- Memorial Day weekend (5 am on Friday thru 10:00pm Monday)
- Independence Day (5 am on July 3 thru 10:00 pm on July 5)
- Labor Day weekend (5 am on Friday thru 10:00 pm Monday)
- Thanksgiving Holiday (5 am on Wednesday thru 10:00 pm Sunday)
- Christmas Holiday (5 am on December 23 thru 10:00 pm December 26)

No significant traffic generator events identified.

Item 8:

This Project will be a Five-Day Workweek in accordance with Article 8.3.1.1.

Meet weekly with the engineer to notify him or her of planned work for the upcoming week.

A 120-day construction delay is included in this contract through Special Provision 008-004. This delay is included for material acquisition.

County: Collin

Highway: FM 2551

Item 100:

Remove the existing roadway small signs, delineators and object markers as shown on the plans, or as directed, during construction within the right of way. Small sign, delineator and object marker removals are subsidiary to this Item.
 The limits of preparing right of way will be measured from Sta. 169+21.55 to Sta. 348+82.69 along the centerline of construction.

Item 104:

In those areas where the pavement is not to be overlaid, provide a smooth surface after the curb removal. Planing or grinding is considered an acceptable method at these locations. Measurement and payment is in accordance with this item.

Sawing of concrete is not paid for directly, but is considered subsidiary to this item.

Items 105:

Saw existing asphalt along neat lines where portions are to be left in place temporarily or permanently. Sawing is not paid for directly, but is subsidiary to this item.

Take possession of recycled asphalt pavement from the project and recycle the material.

Properly dispose of unsalvageable material at your own expense.

Item 110:

Excavated shale is not an acceptable material for embankment.

Items 110 and 132:

Scarify and loosen the excavated areas, unpaved surface areas, except rock, to a depth of at least 8 inches and compact in accordance with the specifications.

Excavation and embankment for driveways, sleeper slabs, alleys and intersections will not be paid for directly, but will be considered subsidiary to these items.

Item 132:

Excavated material from the project site has not been determined to be suitable for embankment. The bidder assumes all risk for the use of excavated materials for embankment and is expected to meet all material requirements for embankment regardless of the source.

Perform Tex-106-E (Plasticity Index) by an approved laboratory on excavated soils from sources outside right of way when used in roadway embankment. Provide the test results at no expense to the department. The engineer will sample and test soils produced by the construction project for specification requirements or material sources specified in the plans.



CONTROLLING PROJECT ID 2056-01-042

DISTRICT Dallas
HIGHWAY FM 2551

Estimate & Quantity Sheet

COUNTY Collin

CONTROL SECTION JOB		2056-01-042		2056-01-043		TOTAL EST.	TOTAL FINAL		
PROJECT ID		A00050518		R00002027					
COUNTY		Collin		Collin					
HIGHWAY		FM 2551		FM 2551					
ALT	BID CODE	DESCRIPTION	UNIT	EST.	FINAL	EST.	FINAL		
	100-6002	PREPARING ROW	STA	184.310			184.310		
	104-6001	REMOVING CONC (PAV)	SY	9,070.000			9,070.000		
	104-6009	REMOVING CONC (RIPRAP)	SY	77.000			77.000		
	104-6011	REMOVING CONC (MEDIAN)	SY	62.000			62.000		
	104-6015	REMOVING CONC (SIDEWALKS)	SY	341.000			341.000		
	104-6017	REMOVING CONC (DRIVEWAYS)	SY	1,036.000			1,036.000		
	105-6070	REMOVING STAB BASE & ASPH PAV (6" - 8")	SY	665.000			665.000		
	105-6109	REMOVING STAB BASE & ASPH PAV (8"-19")	SY	43,884.000			43,884.000		
	110-6001	EXCAVATION (ROADWAY)	CY	71,168.000			71,168.000		
	132-6025	EMBANKMENT (FINAL) (DENS CONT) (TY C1)	CY	48,027.000			48,027.000		
	161-6017	COMPOST MANUF TOPSOIL (4")	SY	62,920.000			62,920.000		
	164-6035	DRILL SEEDING (PERM) (RURAL) (CLAY)	SY	62,920.000			62,920.000		
	164-6051	DRILL SEED (TEMP)(WARM OR COOL)	SY	32,240.000			32,240.000		
	168-6001	VEGETATIVE WATERING	MG	14,156.000			14,156.000		
	260-6002	LIME (HYDRATED LIME (SLURRY))	TON	2,940.000			2,940.000		
	260-6027	LIME TRT (EXST MATL)(8")	SY	78,232.000			78,232.000		
	360-6012	CONC PVMT (CONT REINF - CRCP) (9.5")	SY	61,478.000			61,478.000		
	400-6006	CUT & RESTORING PAV	SY	521.000			521.000		
	402-6001	TRENCH EXCAVATION PROTECTION	LF	18,993.000			18,993.000		
	403-6001	TEMPORARY SPL SHORING	SF	17,707.000			17,707.000		
	416-6032	DRILL SHAFT (TRF SIG POLE) (36 IN)	LF	13.000			13.000		
	416-6034	DRILL SHAFT (TRF SIG POLE) (48 IN)	LF	110.000			110.000		
	420-6143	CL S CONC (JUNCTION BOX)	CY	34.600			34.600		
	423-6005	RETAINING WALL (SPREAD FOOTING)	SF	4,844.000			14,844.000		
	432-6001	RIPRAP (CONC)(4 IN)	CY	617.000			617.000		
	432-6002	RIPRAP (CONC)(5 IN)	CY	8.000			8.000		
	450-6050	RAIL (HANDRAIL)(TY D)	LF	2,331.000			2,331.000		
	450-6052	RAIL (HANDRAIL)(TY F)	LF	1,815.000			1,815.000		
	462-6001	CONC BOX CULV (3 FT X 2 FT)	LF	3,409.000			3,409.000		
	462-6002	CONC BOX CULV (3 FT X 3 FT)	LF	1,889.000			1,889.000		
	462-6004	CONC BOX CULV (4 FT X 3 FT)	LF	836.000			836.000		
	462-6006	CONC BOX CULV (5 FT X 2 FT)	LF	586.000			586.000		
	462-6007	CONC BOX CULV (5 FT X 3 FT)	LF	6,502.000			6,502.000		
	462-6010	CONC BOX CULV (6 FT X 3 FT)	LF	1,022.000			1,022.000		
	462-6011	CONC BOX CULV (6 FT X 4 FT)	LF	102.000			102.000		
	462-6014	CONC BOX CULV (7 FT X 3 FT)	LF	1,088.000			1,088.000		
	464-6003	RC PIPE (CL III)(18 IN)	LF	345.000			345.000		



ADDENDUM 1, REVISED 03/22/2023



CONTROLLING PROJECT ID 2056-01-042

DISTRICT Dallas
HIGHWAY FM 2551

Estimate & Quantity Sheet

COUNTY Collin

CONTROL SECTION JOB			2056-01-042		2056-01-043		TOTAL EST.	TOTAL FINAL		
PROJECT ID			A00050518		R00002027					
COUNTY			Collin		Collin					
HIGHWAY			FM 2551		FM 2551					
ALT	BID CODE	DESCRIPTION	UNIT	EST.	FINAL	EST.	FINAL			
	464-6005	RC PIPE (CL III)(24 IN)	LF	16,969.000			16,969.000			
	464-6007	RC PIPE (CL III)(30 IN)	LF	975.000			975.000			
	464-6008	RC PIPE (CL III)(36 IN)	LF	2,611.000			2,611.000			
	465-6005	JCTBOX(COMPL)(PJB)(3FTX3FT)	EA	2.000			2.000			
	465-6006	JCTBOX(COMPL)(PJB)(4FTX4FT)	EA	3.000			3.000			
	465-6012	JCTBOX(COMPL)(PJB)(8FTX8FT)	EA	1.000			1.000			
	465-6029	INLET (COMPL)(PCU)(3FT)(NONE)	EA	2.000			2.000			
	465-6030	INLET (COMPL)(PCU)(3FT)(LEFT)	EA	73.000			73.000			
	465-6031	INLET (COMPL)(PCU)(3FT)(RIGHT)	EA	73.000			73.000			
	465-6032	INLET (COMPL)(PCU)(3FT)(BOTH)	EA	14.000			14.000			
	465-6071	INLET (COMPL)(PSL)(RC)(4FTX4FT)	EA	45.000			45.000			
	465-6074	INLET (COMPL)(PSL)(RC)(5FTX5FT)	EA	21.000			21.000			
	465-6076	INLET (COMPL)(PSL)(RC)(6FTX6FT)	EA	3.000			3.000			
	465-6077	INLET (COMPL)(PSL)(RC)(8FTX8FT)	EA	19.000			19.000			
	465-6126	INLET (COMPL)(PSL)(FG)(3FTX3FT-3FTX3FT)	EA	12.000			12.000			
	465-6128	INLET (COMPL)(PSL)(FG)(4FTX4FT-4FTX4FT)	EA	11.000			11.000			
	465-6533	INLET (COMPL)(CH)(10 FT)(FTW)	EA	6.000			6.000			
	466-6097	HEADWALL (CH - PW - 0) (DIA= 24 IN)	EA	1.000			1.000			
	466-6181	WINGWALL (PW - 1) (HW=6 FT)	EA	1.000			1.000			
	466-6182	WINGWALL (PW - 1) (HW=7 FT)	EA	2.000			2.000			
	466-6183	WINGWALL (PW - 1) (HW=8 FT)	EA	2.000			2.000			
	466-6205	WINGWALL (SW - 0) (HW=2 FT)	EA	3.000			3.000			
	467-6054	SET (TY I)(S=10 FT)(HW=5FT)(6:1)(P)	EA	1.000			1.000			
	467-6395	SET (TY II) (24 IN) (RCP) (6: 1) (P)	EA	21.000			21.000			
	496-6002	REMOV STR (INLET)	EA	5.000			5.000			
	496-6004	REMOV STR (SET)	EA	47.000			47.000			
	496-6006	REMOV STR (HEADWALL)	EA	8.000			8.000			
	496-6007	REMOV STR (PIPE)	LF	2,856.000			2,856.000			
	496-6008	REMOV STR (BOX CULVERT)	LF	83.000			83.000			
	500-6001	MOBILIZATION	LS	1.000			1.000			
	502-6001	BARRICADES, SIGNS AND TRAFFIC HANDLING	MO	31.000			31.000			
	506-6002	ROCK FILTER DAMS (INSTALL) (TY 2)	LF	726.000			726.000			
	506-6011	ROCK FILTER DAMS (REMOVE)	LF	726.000			726.000			
	506-6020	CONSTRUCTION EXITS (INSTALL) (TY 1)	SY	493.000			493.000			
	506-6024	CONSTRUCTION EXITS (REMOVE)	SY	493.000			493.000			
	506-6038	TEMP SEDMT CONT FENCE (INSTALL)	LF	3,476.000			3,476.000			
	506-6039	TEMP SEDMT CONT FENCE (REMOVE)	LF	3,476.000			3,476.000			

1

ADDENDUM 1, REVISED 03/22/2023



CONTROLLING PROJECT ID 2056-01-042

DISTRICT Dallas
HIGHWAY FM 2551

COUNTY Collin

Estimate & Quantity Sheet

CONTROL SECTION JOB			2056-01-042		2056-01-043		TOTAL EST.	TOTAL FINAL		
PROJECT ID			A00050518		R00002027					
COUNTY			Collin		Collin					
HIGHWAY			FM 2551		FM 2551					
ALT	BID CODE	DESCRIPTION	UNIT	EST.	FINAL	EST.	FINAL			
506-6042	BIODEG EROSN CONT LOGS (INSTL) (18")	LF	9,548.000				9,548.000			
506-6043	BIODEG EROSN CONT LOGS (REMOVE)	LF	9,548.000				9,548.000			
508-6001	CONSTRUCTING DETOURS	SY	8,062.000				8,062.000			
512-6009	PORT CTB (FUR & INST)(LOW PROF)(TY 1)	LF	2,680.000				2,680.000			
512-6010	PORT CTB (FUR & INST)(LOW PROF)(TY 2)	LF	120.000				120.000			
512-6057	PORT CTB (REMOVE)(LOW PROF)(TY 1)	LF	2,680.000				2,680.000			
512-6058	PORT CTB (REMOVE)(LOW PROF)(TY 2)	LF	120.000				120.000			
529-6005	CONC CURB (MONO) (TY II)	LF	71,126.000				71,126.000			
530-6004	DRIVEWAYS (CONC)	SY	2,013.000				2,013.000			
531-6001	CONC SIDEWALKS (4")	SY	17,779.000				17,779.000			
531-6004	CURB RAMPS (TY 1)	EA	27.000				27.000			
531-6005	CURB RAMPS (TY 2)	EA	3.000				3.000			
531-6010	CURB RAMPS (TY 7)	EA	33.000				33.000			
531-6013	CURB RAMPS (TY 10)	EA	26.000				26.000			
536-6002	CONC MEDIAN	SY	4,102.000				4,102.000			
538-6001	RIGHT OF WAY MARKERS	EA	146.000				146.000			
550-6003	CHAIN LINK FENCE (REMOVE)	LF	1,701.000				1,701.000			
550-6006	GATE (REMOVE)	EA	1.000				1.000			
560-6007	MAILBOX INSTALL-S (WC-POST) TY 3	EA	3.000				3.000			
618-6023	CONDT (PVC) (SCH 40) (2")	LF	330.000				330.000			
618-6029	CONDT (PVC) (SCH 40) (3")	LF	490.000				490.000			
618-6033	CONDT (PVC) (SCH 40) (4")	LF	185.000				185.000			
618-6034	CONDT (PVC) (SCH 40) (4") (BORE)	LF	320.000				320.000			
620-6007	ELEC CONDR (NO.8) BARE	LF	,325.000				,325.000			
620-6009	ELEC CONDR (NO.6) BARE	LF	25.000				25.000			
620-6010	ELEC CONDR (NO.6) INSULATED	LF	30.000				30.000			
621-6005	TRAY CABLE (4 CONDR) (12 AWG)	LF	,245.000				,245.000			
624-6002	GROUND BOX TY A (122311)W/APRON	EA	2.000				2.000			
624-6008	GROUND BOX TY C (162911)W/APRON	EA	4.000				4.000			
644-6001	IN SM RD SN SUP&AM TY10BWG(1)SA(P)	EA	54.000				54.000			
644-6004	IN SM RD SN SUP&AM TY10BWG(1)SA(T)	EA	7.000				7.000			
644-6007	IN SM RD SN SUP&AM TY10BWG(1)SA(U)	EA	12.000				12.000			
644-6068	RELOCATE SM RD SN SUP&AM TY 10BWG	EA	3.000				3.000			
662-6061	WK ZN PAV MRK REMOV (W)4"(DOT)	LF	1,797.000				1,797.000			
662-6063	WK ZN PAV MRK REMOV (W)4"(SLD)	LF	44,608.000				44,608.000			
662-6075	WK ZN PAV MRK REMOV (W)24"(SLD)	LF	1,199.000				1,199.000			
662-6080	WK ZN PAV MRK REMOV (W)(ARROW)	EA	1.000				1.000			



ADDENDUM 1, REVISED 03/22/2023



CONTROLLING PROJECT ID 2056-01-042

DISTRICT Dallas
HIGHWAY FM 2551

COUNTY Collin

Estimate & Quantity Sheet

CONTROL SECTION JOB			2056-01-042		2056-01-043		TOTAL EST.	TOTAL FINAL		
PROJECT ID			A00050518		R00002027					
COUNTY			Collin		Collin					
HIGHWAY			FM 2551		FM 2551					
ALT	BID CODE	DESCRIPTION	UNIT	EST.	FINAL	EST.	FINAL			
	662-6095	WK ZN PAV MRK REMOV (Y)4"(SLD)	LF	75,997.000			75,997.000			
	666-6036	REFL PAV MRK TY I (W)8"(SLD)(100MIL)	LF	8,535.000			8,535.000			
	666-6042	REFL PAV MRK TY I (W)12"(SLD)(100MIL)	LF	267.000			267.000			
	666-6048	REFL PAV MRK TY I (W)24"(SLD)(100MIL)	LF	3,545.000			3,545.000			
	666-6054	REFL PAV MRK TY I (W)(ARROW)(100MIL)	EA	67.000			67.000			
	666-6078	REFL PAV MRK TY I (W)(WORD)(100MIL)	EA	58.000			58.000			
	666-6171	REFL PAV MRK TY II (W) 6" (BRK)	LF	17,926.000			17,926.000			
	666-6178	REFL PAV MRK TY II (W) 8" (SLD)	LF	8,535.000			8,535.000			
	666-6180	REFL PAV MRK TY II (W) 12" (SLD)	LF	267.000			267.000			
	666-6182	REFL PAV MRK TY II (W) 24" (SLD)	LF	3,545.000			3,545.000			
	666-6184	REFL PAV MRK TY II (W) (ARROW)	EA	67.000			67.000			
	666-6192	REFL PAV MRK TY II (W) (WORD)	EA	58.000			58.000			
	666-6210	REFL PAV MRK TY II (Y) 6" (SLD)	LF	861.000			861.000			
	666-6306	RE PM W/RET REQ TY I (W)6"(BRK)(100MIL)	LF	17,926.000			17,926.000			
	666-6309	RE PM W/RET REQ TY I (W)6"(SLD)(100MIL)	LF	563.000			563.000			
	666-6321	RE PM W/RET REQ TY I (Y)6"(SLD)(100MIL)	LF	861.000			861.000			
	672-6007	REFL PAV MRKR TY I-C	EA	427.000			427.000			
	672-6009	REFL PAV MRKR TY II-A-A	EA	11.000			11.000			
	672-6010	REFL PAV MRKR TY II-C-R	EA	897.000			897.000			
	677-6001	ELIM EXT PAV MRK & MRKS (4")	LF	20,875.000			20,875.000			
	677-6007	ELIM EXT PAV MRK & MRKS (24")	LF	50.000			50.000			
	677-6008	ELIM EXT PAV MRK & MRKS (ARROW)	EA	15.000			15.000			
	677-6011	ELIM EXT PAV MRK & MRKS (NUMBER)	EA	15.000			15.000			
	678-6002	PAV SURF PREP FOR MRK (6")	LF	18,787.000			18,787.000			
	678-6004	PAV SURF PREP FOR MRK (8")	LF	8,535.000			8,535.000			
	678-6006	PAV SURF PREP FOR MRK (12")	LF	267.000			267.000			
	678-6008	PAV SURF PREP FOR MRK (24")	LF	3,545.000			3,545.000			
	678-6009	PAV SURF PREP FOR MRK (ARROW)	EA	67.000			67.000			
	678-6016	PAV SURF PREP FOR MRK (WORD)	EA	58.000			58.000			
	680-6004	REMOVING TRAFFIC SIGNALS	EA	2.000			2.000			
	680-6005	INS HY TRF SIG (DPT SUP CNT & CAB)(ISO)	EA	2.000			2.000			
	681-6001	TEMP TRAF SIGNALS	EA	2.000			2.000			
	682-6001	VEH SIG SEC (12")LED(GRN)	EA	22.000			22.000			
	682-6002	VEH SIG SEC (12")LED(GRN ARW)	EA	11.000			11.000			
	682-6003	VEH SIG SEC (12")LED(YEL)	EA	22.000			22.000			
	682-6004	VEH SIG SEC (12")LED(YEL ARW)	EA	18.000			18.000			
	682-6005	VEH SIG SEC (12")LED(RED)	EA	22.000			22.000			

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ADDENDUM 1, REVISED 03/22/2023



CONTROLLING PROJECT ID 2056-01-042

DISTRICT Dallas
HIGHWAY FM 2551

Estimate & Quantity Sheet

COUNTY Collin

CONTROL SECTION JOB			2056-01-042		2056-01-043		TOTAL EST.	TOTAL FINAL		
PROJECT ID			A00050518		R00002027					
COUNTY			Collin		Collin					
HIGHWAY			FM 2551		FM 2551					
ALT	BID CODE	DESCRIPTION	UNIT	EST.	FINAL	EST.	FINAL			
	682-6006	VEH SIG SEC (12")LED(RED ARW)	EA	22.000			22.000			
	682-6018	PED SIG SEC (LED)(COUNTDOWN)	EA	18.000			18.000			
	682-6054	BACKPLATE W/REF BRDR(3 SEC)(VENT)ALUM	EA	20.000			20.000			
	682-6055	BACKPLATE W/REF BRDR(4 SEC)(VENT)ALUM	EA	4.000			4.000			
	682-6056	BACKPLATE W/REF BRDR(5 SEC)(VENT)ALUM	EA	7.000			7.000			
	684-6031	TRF SIG CBL (TY A)(14 AWG)(5 CONDR)	LF	2,030.000			2,030.000			
	684-6033	TRF SIG CBL (TY A)(14 AWG)(7 CONDR)	LF	795.000			795.000			
	684-6047	TRF SIG CBL (TY A)(14 AWG)(21 CONDR)	LF	1,420.000			1,420.000			
	684-6079	TRF SIG CBL (TY C)(12 AWG)(2 CONDR)	LF	3,465.000			3,465.000			
	686-6043	INS TRF SIG PL AM(S)1 ARM(40')LUM	EA	1.000			1.000			
	686-6059	INS TRF SIG PL AM(S)1 ARM(55')LUM	EA	1.000			1.000			
	686-6063	INS TRF SIG PL AM(S)1 ARM(60')LUM	EA	2.000			2.000			
	686-6067	INS TRF SIG PL AM(S)1 ARM(65')LUM	EA	2.000			2.000			
	687-6001	PED POLE ASSEMBLY	EA	17.000			17.000			
	687-6002	PEDESTRIAN PUSH BUTTON POLE	EA	1.000			1.000			
	688-6001	PED DETECT PUSH BUTTON (APS)	EA	20.000			20.000			
	688-6003	PED DETECTOR CONTROLLER UNIT	EA	3.000			3.000			
	730-6107	FULL - WIDTH MOWING	CYC	6.000			6.000			
	3077-6001	SP MIXESSP-BPG64-22	TON	39,212.000			39,212.000			
	3077-6075	TACK COAT	GAL	10,694.000			10,694.000			
	5026-6002	ASBESTOS ABATEMENT (OTHER)	LF		1,688.000		1,688.000			
	6004-6031	ITS COM CBL (ETHERNET)	LF	420.000			420.000			
	6010-6002	CCTV FIELD EQUIPMENT (DIGITAL)	EA	1.000			1.000			
	6027-6003	CONDUIT (PREPARE)	LF	760.000			760.000			
	6027-6008	GROUND BOX (PREPARE)	EA	9.000			9.000			
	6054-6005	ANTENNA (UNI-DIRECTIONAL)	EA	1.000			1.000			
	6062-6018	ITS RADIO (SNGL)(5 GHZ)-I-U	EA	1.000			1.000			
	6185-6002	TMA (STATIONARY)	DAY	25.000			25.000			
	6185-6005	TMA (MOBILE OPERATION)	DAY	40.000			40.000			
	6292-6005	RVDS(ADVANCE DET ONLY)(INSTALL ONLY)	EA	1.000			1.000			
	6306-6006	VIVDS TEMPORARY	EA	2.000			2.000			
	6306-6009	VIVDS PROSR SYS (INSTALL ONLY)	EA	2.000			2.000			
	6306-6010	VIVDS CAM ASSY (INSTALL ONLY)	EA	8.000			8.000			
	6306-6012	VIVDS CABLING (INSTALL ONLY)	LF	,950.000			1,950.000			
	7314-6001	RMV & DISP 4" WL W/ CASING, FIT, VV	LF		318.000		318.000			
	7314-6002	RMV & DISP 8" WL W/ CASING, FIT, VV	LF		319.000		319.000			
	7314-6003	RMV & DISP 12" WL W/ CASING, FIT, VV	LF		276.000		276.000			



ADDENDUM 1, REVISED 03/22/2023



CONTROLLING PROJECT ID 2056-01-042

DISTRICT Dallas
HIGHWAY FM 2551

Estimate & Quantity Sheet

COUNTY Collin

CONTROL SECTION JOB		2056-01-042		2056-01-043		TOTAL EST.	TOTAL FINAL		
PROJECT ID		A00050518		R00002027					
COUNTY		Collin		Collin					
HIGHWAY		FM 2551		FM 2551					
ALT	BID CODE	DESCRIPTION	UNIT	EST.	FINAL	EST.	FINAL		
	7314-6004	REMOVE & DISPOSE FIRE HYDRANT	EA			1.000	1.000		
	7314-6005	RMV & SALV STND FIRE HYDRANT & 6" RSVG	EA			1.000	1.000		
	7314-6006	FULL DEPTH SAW CUT FOR REMOVAL	LF			33.000	33.000		
	7314-6007	REMOVE CONCRETE DRIVEWAY	LS			1.000	1.000		
	7314-6008	REMOVE & REPLACE ASPHALT STREET	LS			1.000	1.000		
	7314-6009	REMOVE TREE INCLUDING ROOT BALL	EA			7.000	7.000		
	7314-6010	FURN, INSTL, MAINT & RMV INLET PROTECT	EA			2.000	2.000		
	7314-6011	FURN, INSTL 4" HDPE TEMP WL INCLUD FIT	LF			154.000	154.000		
	7314-6012	FURN & INSTL 6" WL (OPEN CUT)	LF			50.000	50.000		
	7314-6013	FUR&INSTL 6" WL W/12" STL CAS OPEN CUT	LF			170.000	170.000		
	7314-6014	FUR&INSTL 6" WL W/12" STL CAS (OTHER)	LF			120.000	120.000		
	7314-6015	FURN & INSTL 8" WL (OPEN CUT)	LF			521.000	521.000		
	7314-6016	FUR&INSTL 8" WL W/14" STL CAS OPEN CUT	LF			240.000	240.000		
	7314-6017	FURN & INSTL 12" WL (OPEN CUT)	LF			45.000	45.000		
	7314-6018	FUR&INSTL 12" WL W/18" STL CAS OPEN CUT	LF			212.000	212.000		
	7314-6019	FUR&INSTL 12" WL W/18" STL CAS (OTHER)	LF			45.000	45.000		
	7314-6020	FUR & INSTL 4" RESIL SEAT GATE VALVE	EA			1.000	1.000		
	7314-6021	FUR & INSTL 6" RESIL SEAT GATE VALVE	EA			3.000	3.000		
	7314-6022	FUR & INSTL 8" RESIL SEAT GATE VALVE	EA			4.000	4.000		
	7314-6023	FUR & INSTL 12" RESIL SEAT GATE VALVE	EA			1.000	1.000		
	7314-6024	FUR & INSTL 12" X 2" TAP SLV & VALVE	EA			3.000	3.000		
	7314-6025	FUR & INSTL 12" X 6" TAP SLV & VALVE	EA			3.000	3.000		
	7314-6026	FUR & INSTL 12" X 12" TAP SLV & VALVE	EA			1.000	1.000		
	7314-6027	FURN & INSTL STANDARD FIRE HYDRANT	EA			3.000	3.000		
	7314-6028	FUR & INSTL 1" HDPE SERV LINE OPEN CUT	LF			175.000	175.000		
	7314-6029	FUR & INSTL 2" HDPE 3" STL CAS OPEN CUT	LF			162.000	162.000		
	7314-6030	FUR & INSTL 2" HDPE BY OPEN CUT	LF			50.000	50.000		
	7314-6031	FUR & INSTL 2" HDPE 3" STL CAS (OTHER)	LF			120.000	120.000		
	7314-6032	FUR & INSTL 2" BULL HEAD W/ REDUCER	EA			2.000	2.000		
	7314-6033	FUR & INSTL METER BOX W/ METER SET	EA			3.000	3.000		
	7314-6034	CONNECT TO EXIST 4" WL	EA			2.000	2.000		
	7314-6035	CONNECT TO EXIST 8" WL	EA			4.000	4.000		
	7314-6036	CONNECT TO EXIST 12" WL	EA			4.000	4.000		
	7314-6037	CONNECT TO EXIST WATER SERVICE	EA			3.000	3.000		
	7314-6038	FUR, INSTL & RMV TRENCH SAFE NW LNE	LF			1,450.000	1,450.000		
	7314-6039	FUR, INSTL & RMV TRENCH SAFE WL RMV	LF			2,283.000	2,283.000		
	7314-6040	FUR, INSTL & RMV TRENCH SAFE BORE PIT	LS			1.000	1.000		



ADDENDUM 1, REVISED 03/22/2023



CONTROLLING PROJECT ID 2056-01-042

DISTRICT Dallas
HIGHWAY FM 2551

COUNTY Collin

Estimate & Quantity Sheet

CONTROL SECTION JOB		2056-01-042		2056-01-043		TOTAL EST.	TOTAL FINAL		
PROJECT ID		A00050518		R00002027					
COUNTY		Collin		Collin					
HIGHWAY		FM 2551		FM 2551					
ALT	BID CODE	DESCRIPTION	UNIT	EST.	FINAL	EST.	FINAL		
	7314-6041	FUR, INSTL, MAINT & RMV BARRICADES	LS			1.000			
08	CONTRACTOR FORCE ACCOUNT EROSION CONTROL MAINTENANCE (NON-PARTICIPATING)		LS	1.000			1.000		
	CONTRACTOR FORCE ACCOUNT LAW ENFORCEMENT (NON-PARTICIPATING)		LS	1.000			1.000		
	CONTRACTOR FORCE ACCOUNT SAFETY CONTINGENCY (NON-PARTICIPATING)		LS	1.000			1.000		



ADDENDUM 1, REVISED 03/22/2023

3/27/2023 4:18:42 PM Klochinan

Down: /Active Projects/COLC1201.00/8.00 Plans and Drawings/8.30 Cut Sheets/8.3.02 Summaries/1201TCs01.dgn

NO.	REVISION				BY	DATE
 TEXAS REGISTERED ENGINEERING FIRM. F-1741						
 Texas Department of Transportation						
©2023 FROM FM 2514 (PARKER ROAD) TO FM 2170 (MAIN STREET) FM 2551 (MURPHY ROAD)						
SUMMARY						
WORK ZONE TRAFFIC CONTROL						
Designed:	CPY	FED RD. DIV. NO.	STATE	PROJECT NO.		HIGHWAY NO.
Checked:	CPY	6	TEXAS	SEE TITLE SHEET		FM 2551
Drawn:	CPY	DIST.	COUNTY	CONTROL NO.	SECTION NO.	JOB NO.
Checked	CPY	DALLAS	COLLIN	2056	01	042
						17

SUMMARY OF REMOVAL ITEMS																		
SHEET NO.	LOCATION	0104	0104	0104	0104	0105	0105	0104		0550	0550	0496	0496	0496	0496	0496	0496	
		6001	6009	6015	6017	6070	6109	6011		6003	6006	6002	6004	6006	6007	6008		
		REMOVING CONC (PAV)	REMOVING CONC (RIPRAP)	REMOVING CONC (SIDEWALKS)	REMOVING CONC (DRIVeways)	REMOVING STAB & ASPH PAV (6" - 8")	REMOVING STAB & ASPH PAV (8"-19")	REMOVING CONC (MEDIANs)	*REMOVE GRAVEL DRIVEWAY	*REMOVE WALL	CHAIN LINK FENCE (REMOVE)	GATE (REMOVE)	REMOS STR (INLET)	REMOS STR (SET)	REMOS STR (HEADWALL)	REMOS STR (PIPE)	REMOS STR (BOX CULVERT)	
		SY	SY	SY	SY	SY	SY	SY	SY	LF	EA	EA	EA	EA	LF	LF		
SHEET 1 OF 11	BEGIN TO STA 186+00	76							375			2						
SHEET 2 OF 11	STA 186+00 TO STA 202+00								460	1216	1						22	
SHEET 3 OF 11	STA 202+00 TO STA 218+00	1558															38	
SHEET 4 OF 11	STA 218+00 TO STA 233+00	432				2266			33	90			1	2			83	
SHEET 5 OF 11	STA 233+00 TO STA 251+00	1043				501	5775	50		395			6	6			934	
SHEET 6 OF 11	STA 251+00 TO STA 268+00	2144		56	36	4712											490	
SHEET 7 OF 11	STA 268+00 TO STA 286+00	1678		63		5368						1	10				432	
SHEET 8 OF 11	STA 286+00 TO STA 303+00	519		149	380	164	9485	12				1	6				219	
SHEET 9 OF 11	STA 303+00 TO STA 321+00	410		73	620		7482						8				398	
SHEET 10 OF 11	STA 321+00 TO STA 338+00	664				4707							8				315	
SHEET 11 OF 11	STA 338+00 TO END	546				4089						1					8	
	PROJECT TOTAL	9070	0	341	1036	665	43884	62	835	33	1701	1	5	47	8	2856	83	

*FOR CONTRACTORS INFO ONLY

SUMMARY OF MISC WATERLINE ITEMS		
	5026	
	6002	
^ASBESTOS ABATEMENT (OTHER)		
LF		
PROJECT TOTAL	1688	

^REFER TO CITY OF PARKER UTILITY RELOCATION PLAN FOR ASBESTOS REMOVAL LOCATION AND STATION.

SUMMARY OF PAVEMENT MARKING AND SIGNING																			
SHEET NUMBER	0644	0644	0644	0644	0666	0666	0666	0666	0666	0666	0666	0666	0666	0666	0666	0666	0666	0666	0666
	6001	6004	6007	6068	6036	6042	6048	6054	6078	6171	6178	6180	6182	6184	6192	6210	6306	6309	6321
	IN SM RD SN SUP&AM TY10BWG (1) SA(P)	IN SM RD SN SUP&AM TY10BWG (1)SA(T)	IN SM RD SN SUP&AM TY10BWG (1)SA(U)	RELOCATE SM RD SN SUP&AM TY10BWG	REFL PAV MRK TY I (W) 8" (SLD) (100MIL)	REFL PAV MRK TY I (W) 12" (SLD) (100MIL)	REFL PAV MRK TY I (W) 24" (SLD) (100MIL)	REFL PAV MARK TY I (WORD) (100MIL)	REFL PAV MRK TY II (W) 6" (BRK)	REFL PAV MRK TY II (W) 8" (SLD)	REFL PAV MRK TY II (W) 12" (SLD)	REFL PAV MRK TY II (W) 24" (SLD)	REFL PAV MRK TY II (W) (WORD)	REFL PAV MRK TY II (W) (WORD)	REFL PAV MRK TY II (W) 6" SLD	RE PM W/RET REQ. TY I (W) 6" (BRK) (100MIL)	RE PM W/RET REQ. TY I (W) 6" (SLD) (100MIL)	RE PM W/RET REQ. TY I (Y) 6" (SLD) (100MIL)	
	EA	EA	EA	EA	LF	LF	LF	EA	EA	LF	LF	LF	LF	EA	LF	LF	LF	LF	
SHEET 1 OF 11	5	1	6		327		408	6	3	1595	327		408	6	3		1595		
SHEET 2 OF 11	4				802		115	5	6	1600	802		115	5	6		1600		
SHEET 3 OF 11	5				950		286	8	7	1600	950		286	8	7		1600		
SHEET 4 OF 11	5		1		273		230	2	2	1500	273		230	2	2	562	1500	563	
SHEET 5 OF 11	8			2	634		359	6	4	1800	634		359	6	4		1800		
SHEET 6 OF 11	5	2			800		363	6	6	1730	800		363	6	6		1730		
SHEET 7 OF 11	4				589		377	5	5	1800	589		377	5	5	70	1800	70	
SHEET 8 OF 11	1			1	1286		602	9	9	1796	1286		602	9	9	68	1796	68	
SHEET 9 OF 11	4				697		153	9	5	1800	697		153	9	5	161	1800	161	
SHEET 10 OF 11	5		1		483		208	3	3	1700	483		208	3	3		1700		
SHEET 11 OF 11	8	4	4		1694	267	444	8	8	1005	1694	267	444	8	8		1005		
	PROJECT TOTAL	54	7	12	3	8535	267	3545	67	58	17926	8535	267	3545	67	58	861	17926	563
																		861	

SUMMARY OF PAVEMENT MARKING AND SIGNING (CON'T)									
SHEET NUMBER	0672	0672	0672	0678	0678	0678	0678	0678	0678
	6007	6009	6010	6002	6004	6006	6008	6009	6016
	REFL PAV MRKR TY I-C	REFL PAV MRKR TY II-A-A	REFL PAV MRKR TY II-C-R	PAV SURF PREP FOR MRK (6")	PAV SURF PREP FOR MRK (8")	PAV SURF PREP FOR MRK (12")	PAV SURF PREP FOR MRK (24")	PAV SURF PREP FOR MRK (ARROW)	PAV SURF

SUMMARY OF DRAINAGE ITEMS


SHEET NO.	LOCATION	0402	420	0462	0462	0462	0462	0462	0462	0464	0464	0464	0464	0465	0465	0465	0465	0465	0465	
		6001	6143	6001	6002	6004	6006	6007	6010	6014	6003	6005	6007	6008	6005	6006	6012	6029	6030	6031
		LF	CY	LF	LF	EA	EA	EA	EA	EA	EA									
SHEET 1 OF 25	CL FM 2514 STA 31+00 TO STA 39+00	734							726											
SHEET 2 OF 25	CL FM 2514 STA 23+00 TO STA 31+00	800							784											
SHEET 3 OF 25	CL FM 2514 STA 15+00 TO STA 23+00	802							786											
SHEET 4 OF 25	BEGIN TO STA 177+00	1747				382	836		54				342						2	3
SHEET 5 OF 25	STA 177+00 TO STA 186+00	1916				888							974						4	12
SHEET 6 OF 25	STA 186+00 TO STA 194+00	1322		15	295								1294						4	6
SHEET 7 OF 25	STA 194+00 TO STA 202+00	266											1097						2	2
SHEET 8 OF 25	STA 202+00 TO STA 210+00	30											675						2	2
SHEET 9 OF 25	STA 210+00 TO STA 218+00	35											1167	414					3	3
SHEET 10 OF 25	STA 218+00 TO STA 226+00	1011											942	178	590				4	4
SHEET 11 OF 25	STA 226+00 TO STA 233+00	70		144			229	608			92	793							2	2
SHEET 12 OF 25	STA 233+00 TO STA 242+00	120	14.2	891				216		772	57	114							5	3
SHEET 13 OF 25	STA 242+00 TO STA 251+00	378	20.4	884				560		316	15	74		29					4	3
SHEET 14 OF 25	STA 251+00 TO STA 259+00	1511		790				784			15	25							3	3
SHEET 15 OF 25	STA 259+00 TO STA 268+00	1772		188				186				762		694					4	3
SHEET 16 OF 25	STA 268+00 TO STA 277+00	1639										1221		594					5	3
SHEET 17 OF 25	STA 277+00 TO STA 286+00	1870										1825							6	4
SHEET 18 OF 25	STA 286+00 TO STA 294+00	806										1357							3	3
SHEET 19 OF 25	STA 294+00 TO STA 303+00	649										1883							4	3
SHEET 20 OF 25	STA 303+00 TO STA 312+00	115		261								723							1	1
SHEET 21 OF 25	STA 312+00 TO STA 321+00	55		236			357				103	1087						2	3	3
SHEET 22 OF 25	STA 321+00 TO STA 329+00	85										205	240	604		2			2	2
SHEET 23 OF 25	STA 329+00 TO STA 338+00	80				324			785	510		128	143	100	2	1	1		5	4
SHEET 24 OF 25	STA 338+00 TO STA 345+00	519						689	512		20	20							3	2
SHEET 25 OF 25	STA 345+00 TO END	661						324			43	261							2	2
PROJECT TOTAL		18993	34.6	3409	1889	836	586	6502	1022	1088	345	16969	975	2611	2	3	1	2	73	73

NOTE: DRAINAGE QUANTITIES INCLUDE LATERAL QUANTITIES ON THE SHEETS IN WHICH THEY APPEAR.


NO.	REVISION	BY	DATE																
 TEXAS REGISTERED ENGINEERING FIRM, F-1741  ©2023 Texas Department of Transportation FROM FM 2514 (PARKER ROAD) TO FM 2170 (MAIN STREET) FM 2551 (MURPHY ROAD) SUMMARY DRAINAGE																			
Designed:	CPY	FED. RD. NO.	STATE	PROJECT NO.	HIGHWAY NO.														
Checked:	CPY	6	TEXAS	SEE TITLE SHEET	FM 2551														
Drawn:	CPY	DIST.	COUNTY	CONTROL SECTION NO.	JOB NO.	SECTION NO.													
Checked:	CPY	DALLAS	COLLIN	2056	01	042													
SHEET 1 OF 2																			





ADDENDUM 1. 3/22/23. REVISED SHEET

PHASE 2 - STEP 1

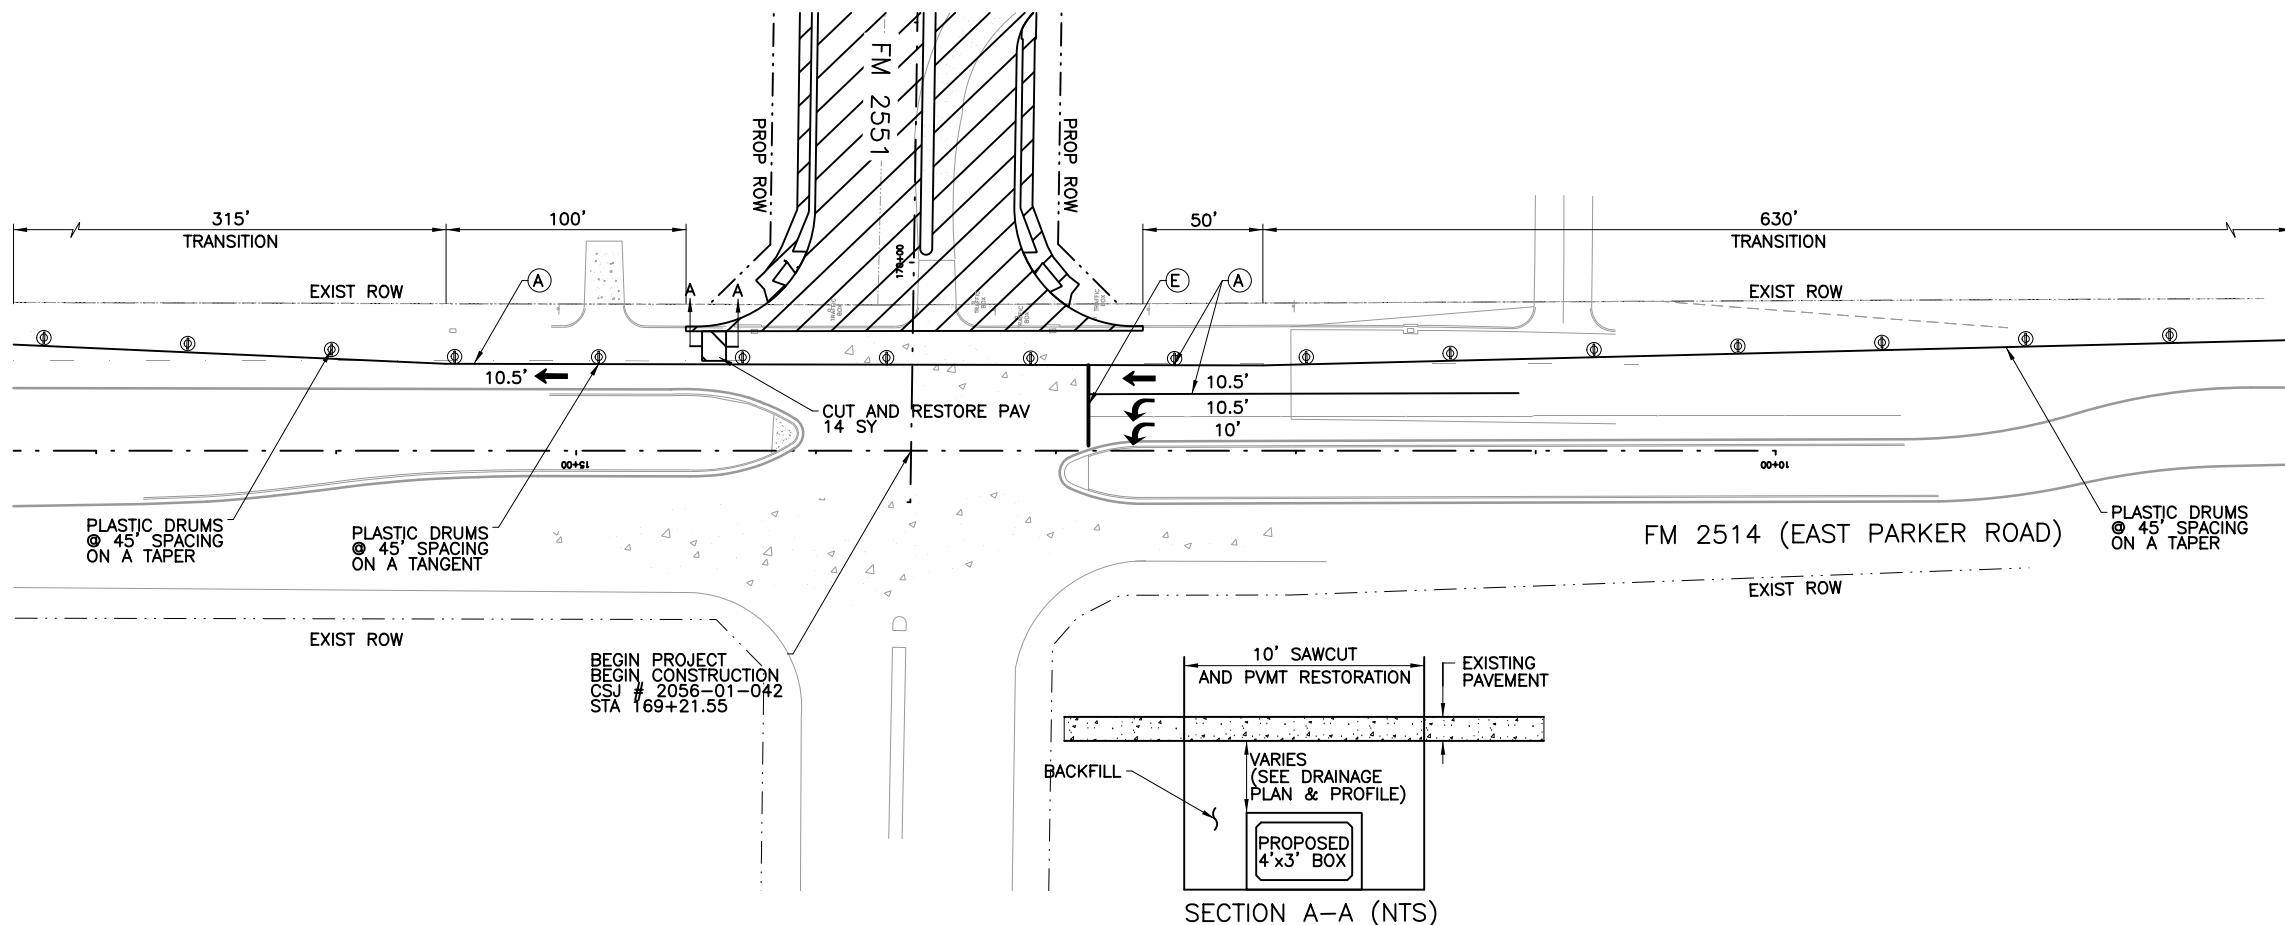

PHASE 2 - STEP 2

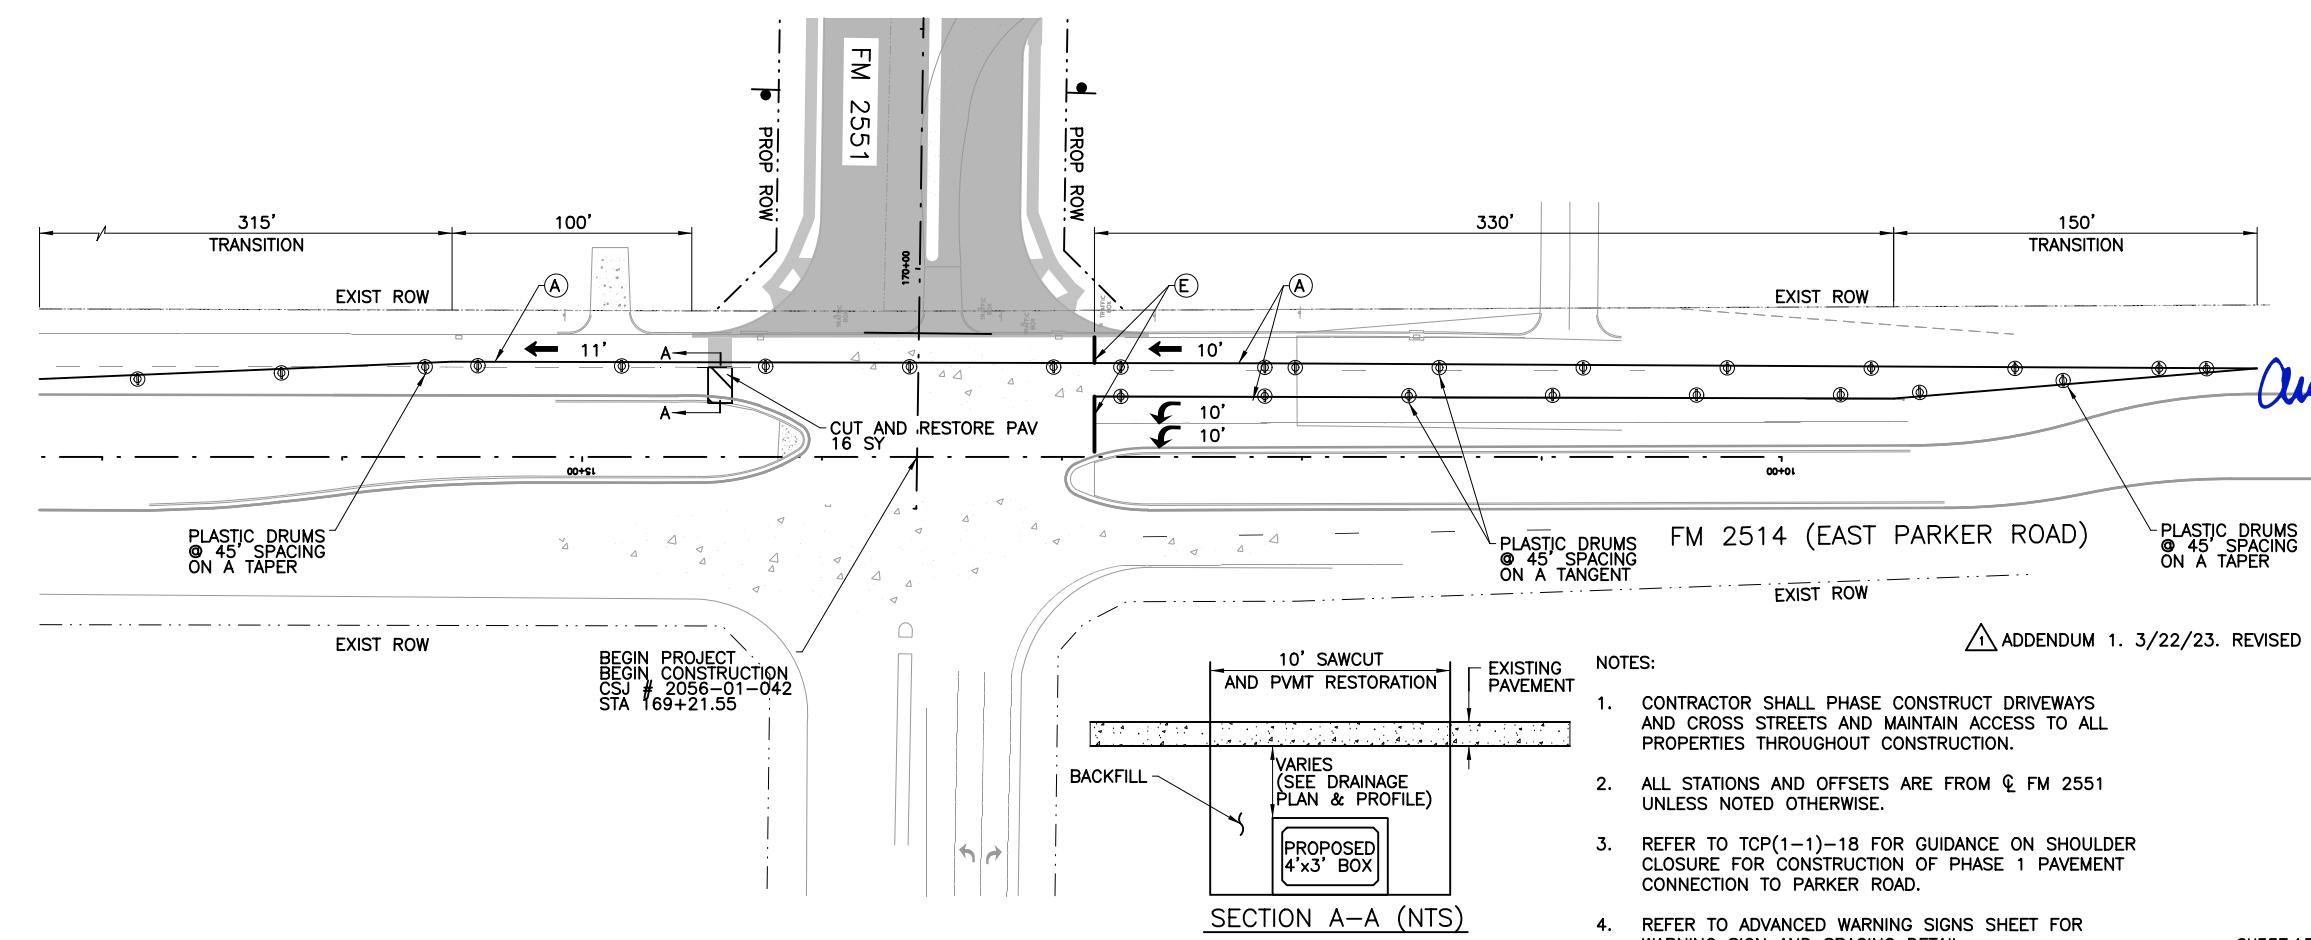

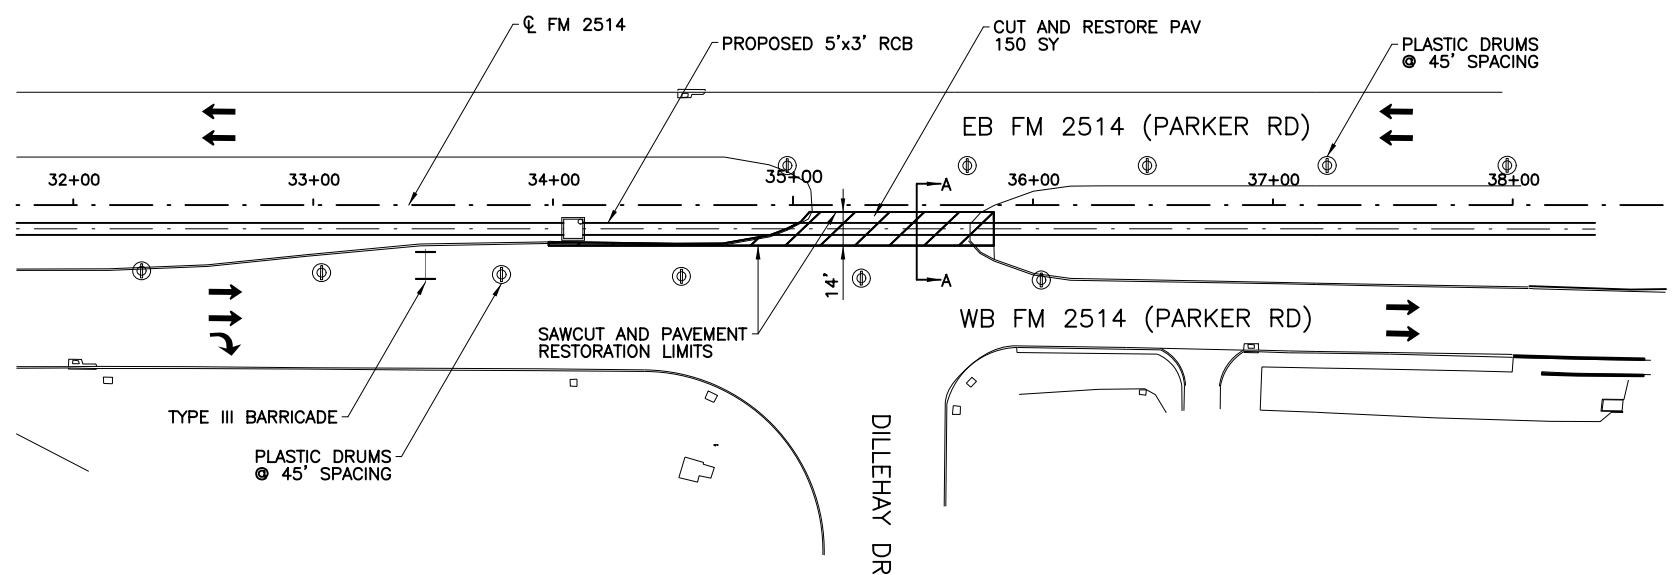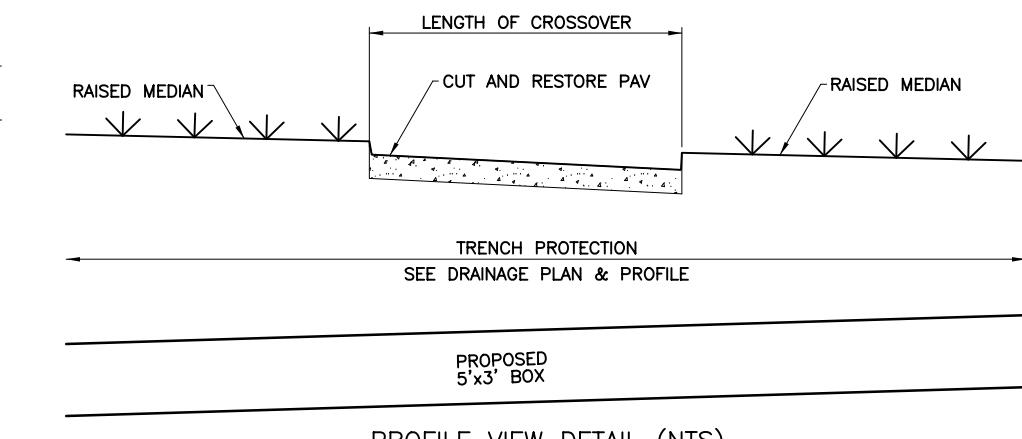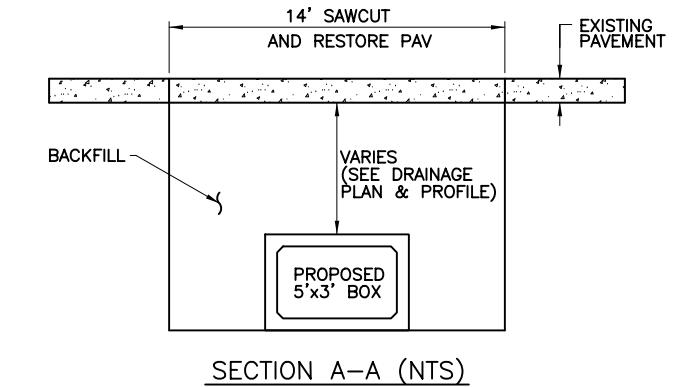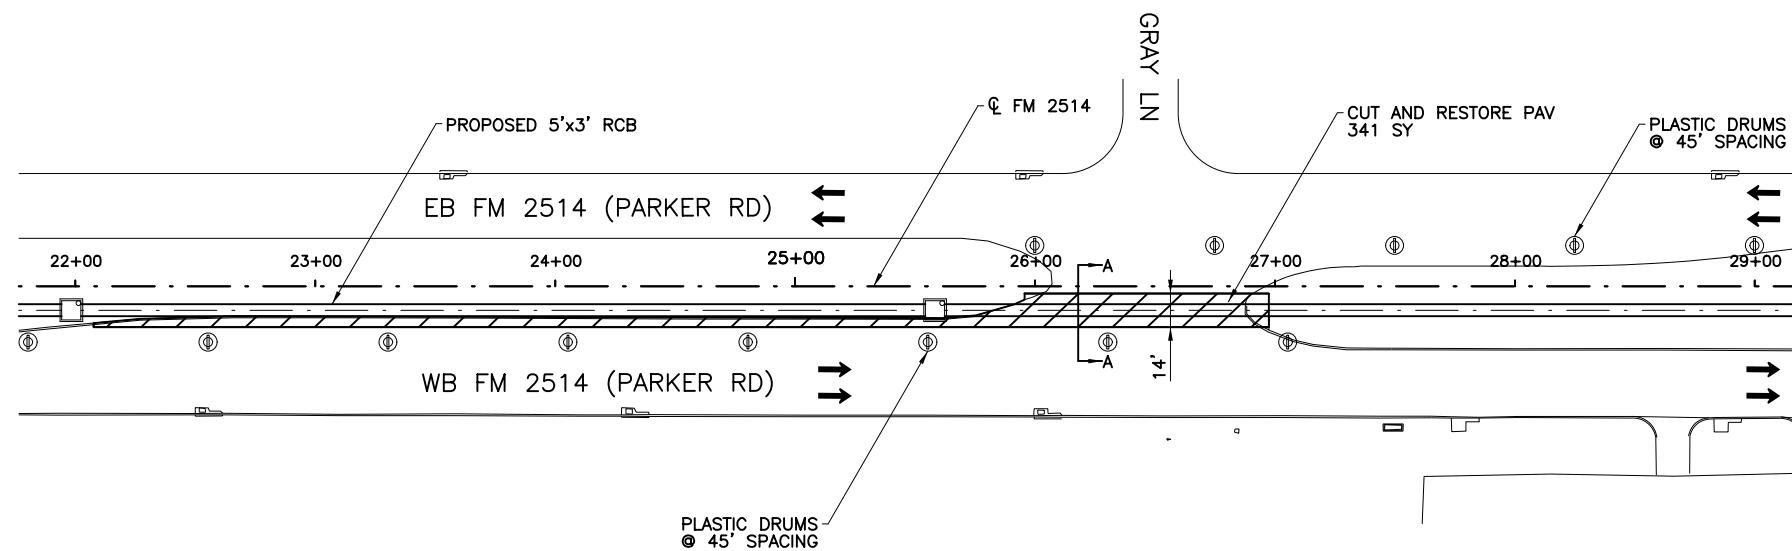


△ ADDENDUM 1. 3/22/23. REVISED SHEET



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03/27/2023


NO.	REVISION	BY	DATE		
CP&Y					
TEXAS REGISTERED ENGINEERING FIRM. F-1741					
©2023 Texas Department of Transportation					
FROM FM 2514 (PARKER ROAD) TO FM 2170 (MAIN STREET) FM 2514 (PARKER ROAD)					
TRAFFIC CONTROL PLAN MEDIAN CROSS OVER					
Designed:	CPY	FED. RD. NO.	STATE	PROJECT NO.	HIGHWAY NO.
Checked:	CPY	6	TEXAS	SEE TITLE SHEET	FM 2551
Drawn:	CPY	DIST.	COUNTY	CONTROL SECTION NO.	JOB NO.
				SHEET NO.	
				2056	01
				042	69

SHEET 1 OF 1

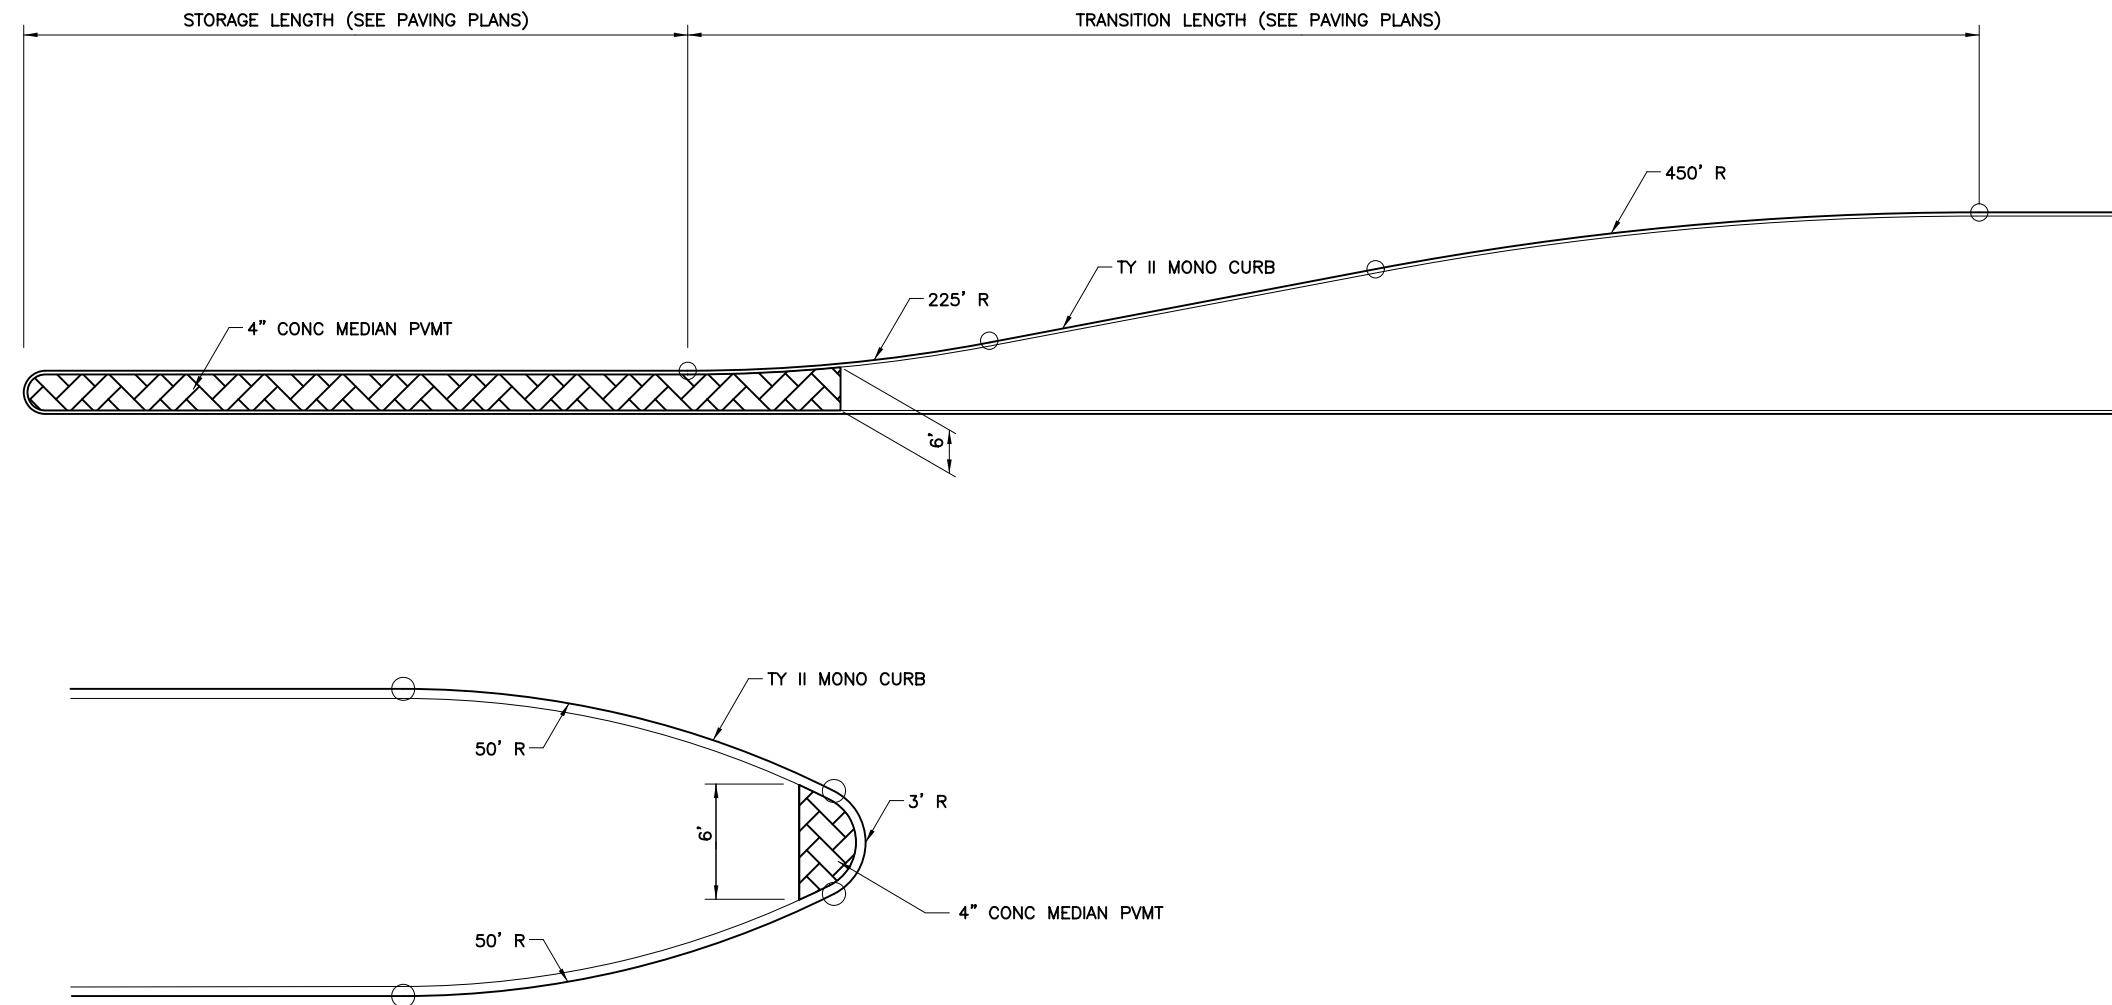

TYPICAL MEDIAN DETAILS

SCALE: NTS

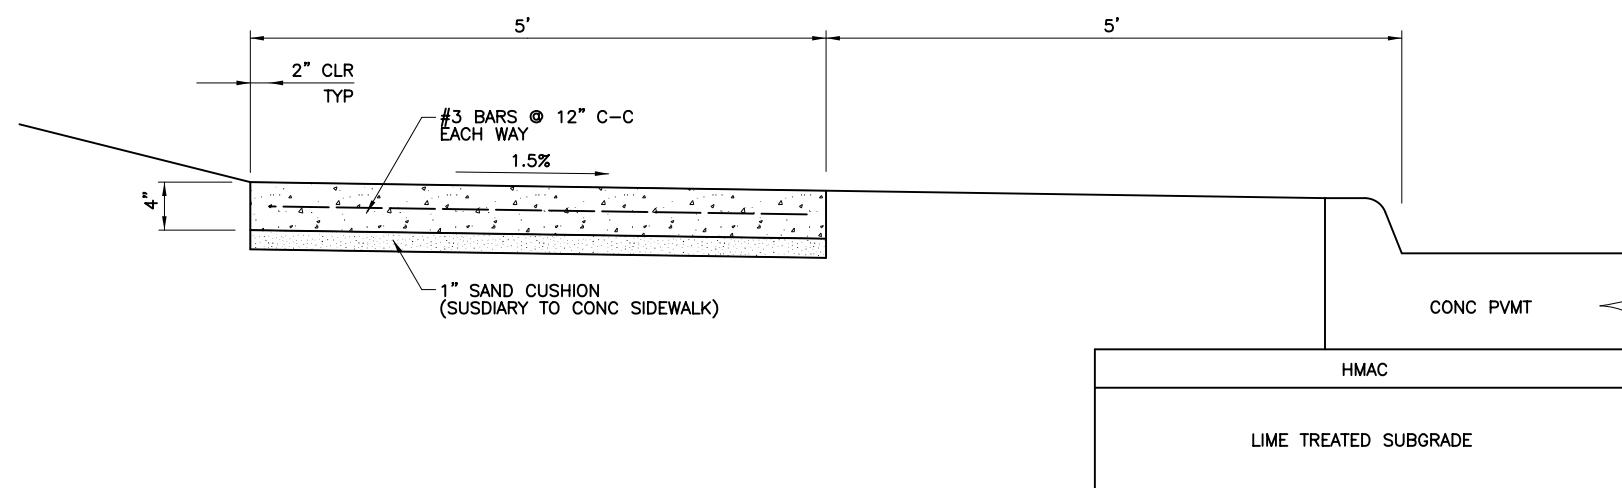

TYPICAL SIDEWALK SECTION

SCALE: NTS

⚠ ADDENDUM 1. 3/22/23. REVISED SHEET



Andrea Klocinski
03/22/2023

NO.	REVISION	BY	DATE



TEXAS REGISTERED ENGINEERING FIRM, F-1741



©2023 FROM FM 2514 (PARKER ROAD) TO FM 2170 (MAIN STREET)
FM 2551 (MURPHY ROAD)

MISCELLANEOUS ROADWAY DETAILS

Designed:	CPY	FED. RD. DIV. NO.	STATE	PROJECT NO.	HIGHWAY NO.
Checked:	CPY	6	TEXAS	SEE TITLE SHEET	FM 2551
Drawn:		DIST.	COUNTY	CONTROL SECTION NO.	JOB NO.
Checked:	DALLAS	COLLIN	2056	01	042

STORM SEWER GEOPAK DRAINAGE COMPUTATIONS																		
LINE	UPSTREAM NODE	DOWNTSTREAM NODE	RISE	SPAN	N VALUE	DISCHARGE	CAPACITY	LENGTH	SLOPE	UNIFORM VELOCITY	UNIFORM DEPTH	ACTUAL VELOCITY	ACTUAL DEPTH DOWN-STREAM	INVERT UPSTREAM	INVERT DOWN-STREAM	HGL UPSTREAM	HGL DOWN-STREAM	
ID	ID	ID	FT	FT		CFS	CFS	FT	%	FT/S	FT	FT/S	FT	FT	FT	FT		
LINE A1	A1-12	PB-A1-14	2	n/a	0.012	2.38	14.57	4.91	0.31	3.21	0.57	1.55	1.01	0.98	636.65	636.63	637.66	637.62
LINE A1	PB-A1-14	PB-A1-15	2	n/a	0.012	2.38	14.46	101.43	0.30	3.21	0.57	1.23	0.98	1.18	636.63	636.33	637.62	637.51
LINE A1	PB-A1-15	PB-A1-16	2	n/a	0.012	3.75	14.45	51.57	0.30	3.69	0.72	1.83	1.18	1.24	636.33	636.17	637.51	637.41
LINE A1	PB-A1-16	OUTLET A1	2	n/a	0.012	5.88	14.44	74.33	0.30	4.14	0.92	4.57	1.24	0.86	636.17	635.95	637.41	636.81
LAT A1-13	A1-13	PB-A1-15	2	n/a	0.012	1.46	14.58	4.91	0.31	2.84	0.44	0.75	1.18	1.18	636.34	636.33	637.52	637.51
LAT A1-14	A1-14	PB-A1-16	2	n/a	0.012	2.23	26.34	4.91	1.00	4.84	0.41	1.09	1.21	1.24	636.22	636.17	637.43	637.41
LINE A2	A3-01	PB-A3-01	3	n/a	0.012	17.08	43.45	6.08	0.31	5.46	1.36	4.07	1.97	1.72	643.03	643.02	645.00	644.74
LINE A2	PB-A3-01	PB-A3-02	3	n/a	0.012	17.08	42.57	149.32	0.30	5.35	1.39	3.47	1.72	1.97	643.02	642.57	644.74	644.54
LINE A2	PB-A3-02	PB-A2-01	3	n/a	0.012	17.08	42.58	65.31	0.30	5.35	1.39	4.80	1.97	1.51	642.57	642.37	644.54	643.88
LINE A2	PB-A2-01	MH-A2-01	3	n/a	0.012	17.93	42.66	115.55	0.30	5.50	1.41	5.48	1.51	1.41	642.37	642.02	643.88	643.44
LINE A2	MH-A2-01	PB-A2-01A	3	n/a	0.012	17.93	42.61	130.45	0.30	5.50	1.41	4.90	1.42	1.54	642.01	641.62	643.44	643.16
LINE A2	PB-A2-01A	MH-A2-02	3	n/a	0.012	18.67	42.58	236.88	0.30	5.51	1.45	5.86	1.54	1.38	641.62	640.91	643.16	642.29
LINE A2	MH-A2-02	PB-A2-02	3	5	0.012	18.67	124.33	15.12	0.30	4.80	0.78	4.26	0.87	0.88	640.78	640.73	641.64	641.61
LINE A2	PB-A2-02	PB-A2-03	3	5	0.012	19.48	123.48	240.00	0.30	4.87	0.80	4.47	0.88	0.87	640.73	640.01	641.61	640.88
LINE A2	PB-A2-03	MH-A2-03	3	5	0.012	20.01	123.52	203.55	0.30	4.93	0.81	4.97	0.87	0.81	640.01	639.40	640.88	640.21
LINE A2	MH-A2-03	PB-A2-04	3	5	0.012	20.01	123.82	38.45	0.30	4.93	0.81	4.53	0.83	0.88	639.38	639.26	640.21	640.14
LINE A2	PB-A2-04	PB-A2-05	3	5	0.012	20.53	123.48	250.00	0.30	4.92	0.84	4.60	0.88	0.89	639.26	638.51	640.14	639.40
LINE A2	PB-A2-05	MH-A2-04	3	5	0.012	21.03	123.52	173.55	0.30	5.03	0.84	5.05	0.89	0.83	638.51	637.99	639.40	638.82
LINE A2	MH-A2-04	PB-A2-06	3	5	0.012	21.03	123.51	68.97	0.30	5.03	0.84	4.52	0.86	0.93	637.97	637.76	638.82	638.69
LINE A2	PB-A2-06	PB-A2-07	3	5	0.012	21.52	123.54	149.51	0.30	5.01	0.86	4.60	0.93	0.93	637.76	637.31	638.69	638.24
LINE A2	PB-A2-07	PB-A2-09	3	5	0.012	22.16	123.59	87.51	0.30	5.03	0.88	4.60	0.93	0.96	637.31	637.05	638.24	638.01
LINE A2	PB-A2-09	MH-A2-05	3	5	0.012	22.88	123.55	113.55	0.30	5.12	0.89	4.10	0.96	1.12	637.05	636.71	638.01	637.82
LINE A2	MH-A2-05	PB-A2-10	3	5	0.012	22.88	123.73	109.23	0.30	5.19	0.88	3.16	1.14	1.45	636.68	636.35	637.82	637.80
LINE A2	PB-A2-10	PB-A2-11	3	5	0.012	22.88	116.20	39.15	0.27	4.93	0.93	2.99	1.45	1.53	636.35	636.25	637.80	637.78
LINE A2	PB-A2-11	PB-A2-12	3	5	0.012	23.49	116.11	137.22	0.27	4.94	0.95	2.53	1.53	1.85	636.25	635.88	637.78	637.74
LINE A2	PB-A2-12	PB-A2-13	3	5	0.012	24.47	116.00	61.57	0.26	5.02	0.97	3.42	1.85	1.43	635.88	635.72	637.74	637.15
LINE A2	PB-A2-13	PB-A2-14	3	5	0.012	25.44	116.25	54.91	0.27	5.10	1.00	3.32	1.43	1.53	635.72	635.58	637.15	637.11
LINE A2	PB-A2-14	OUTLET A2	3	5	0.012	25.44	100.84	58.48	0.20	4.57	1.11	5.47	1.53	0.93	635.58	635.46	637.11	636.39
LAT A2-01	A2-01	PB-A2-01	2	n/a	0.012	1.49	26.34	4.91	1.00	4.30	0.34	0.94	0.97	1.01	642.92	642.87	643.89	643.88
LAT A2-02	A2-02	PB-A2-01A	2	n/a	0.012	1.44	26.34	4.91	1.00	4.27	0.33	0.87	1.01	1.04	642.17	642.12	643.18	643.16
LAT A2-03	A2-03	PB-A2-02	2	n/a	0.012	1.61	26.61	4.91	1.02	4.43	0.35	3.98	0.59	0.37	641.28	641.23	641.88	641.60
LAT A2-04	A2-04	PB-A2-03	2	n/a	0.012	1.30	26.61	4.91	1.02	4.17	0.31	3.78	0.53	0.33	640.56	640.51	641.09	640.84
LAT A2-05	A2-05	PB-A2-04	2	n/a	0.012	1.33	26.61	4.91	1.02	4.19	0.32	3.80	0.54	0.34	639.81	639.76	640.35	640.10
LAT A2-06	A2-06	PB-A2-05	2	n/a	0.012	1.33	26.61	4.91	1.02	4.19	0.32	3.80	0.54	0.34	639.06	639.01	639.60	639.35
LAT A2-07	A2-07	PB-A2-06	2	n/a	0.012	1.33	26.60	4.91	1.02	4.19	0.32	3.80	0.54	0.34	638.31	638.26	638.85	638.60
LAT A2-08	A2-08	PB-A2-08	1.5	n/a	0.012	1.31	9.50	10.45	0.60	3.59	0.39	1.83	0.64	0.64	637.69	637.63	638.33	638.26
LAT A2-08	PB-A2-08	PB-A2-07	1.5	n/a	0.012	1.31	9.48	10.00	0.6									

STORM SEWER GEOPAK DRAINAGE COMPUTATIONS																		
LINE	UPSTREAM NODE	DOWNTSTREAM NODE	RISE	SPAN	N VALUE	DISCHARGE	CAPACITY	LENGTH	SLOPE	UNIFORM VELOCITY	UNIFORM DEPTH	ACTUAL VELOCITY	ACTUAL DEPTH DOWN-STREAM	INVERT UPSTREAM	INVERT DOWN-STREAM	HGL UPSTREAM	HGL DOWN-STREAM	
ID	ID	ID	FT	FT		CFS	CFS	FT	%	FT/S	FT	FT/S	FT	FT	FT	FT	FT	
LAT A1-01	A1-01	PB-A1-01	2	n/a	0.012	1.20	34.08	4.91	1.67	4.84	0.27	0.45	1.52	1.60	640.48	640.40	642.00	641.99
LAT A1-02	A1-02	PB-A1-02	2	n/a	0.012	1.19	26.34	4.91	1.00	4.03	0.30	0.38	2.00	2.00	639.48	639.43	641.66	641.66
LAT A1-03	A1-03	MH-A1-01	3	6	0.012	51.40	157.97	10.32	0.30	6.37	1.35	3.11	2.88	2.76	638.91	638.88	641.79	641.63
LAT A1-04	A1-04	PB-A1-03	2	n/a	0.012	1.32	24.96	4.91	0.90	3.99	0.32	0.46	1.70	1.74	638.74	638.70	640.44	640.44
LAT A1-05	A1-05	PB-A1-04	2	n/a	0.012	7.90	37.37	6.47	2.01	8.94	0.65	2.94	1.60	1.60	638.89	638.76	640.49	640.35
LAT A1-05	PB-A1-05	PB-A1-05	2	n/a	0.012	7.90	37.28	15.00	2.00	8.94	0.65	2.59	1.60	1.86	638.76	638.46	640.35	640.32
LAT A1-06	A1-06	PB-A1-06	2	n/a	0.012	2.63	36.34	7.89	1.90	6.39	0.38	0.96	1.49	1.63	638.70	638.55	640.19	640.18
LAT A1-06	PB-A1-06	PB-A1-07	2	n/a	0.012	2.63	26.36	15.00	1.00	5.08	0.44	0.89	1.63	1.77	638.55	638.40	640.18	640.17
LAT A1-07	A1-07	PB-A1-08	2	n/a	0.012	1.29	26.34	4.91	1.00	4.13	0.31	0.44	1.70	1.75	638.11	638.06	639.81	639.81
LAT A1-08	A1-08	PB-A1-09	2	n/a	0.012	1.41	37.25	8.61	2.00	5.40	0.28	0.57	1.30	1.46	638.47	638.29	639.76	639.76
LAT A1-08	PB-A1-09	PB-A1-10	2	n/a	0.012	1.41	37.28	15.00	2.00	5.41	0.28	0.48	1.46	1.76	638.29	637.99	639.76	639.76
LAT A1-09	A1-09	PB-A1-11	2	n/a	0.012	1.35	24.10	4.91	0.84	3.93	0.33	0.45	1.80	1.84	637.62	637.58	639.43	639.42
LAT A1-10	A1-10	PB-A1-12	2	n/a	0.012	1.37	26.35	4.90	1.00	4.21	0.32	0.44	1.98	2.00	637.14	637.09	639.12	639.12
LAT A1-11	A1-11	PB-A1-13	2	n/a	0.012	1.31	26.35	4.91	1.00	4.16	0.31	0.42	2.00	2.00	636.65	636.60	638.70	638.69
LINE B1	B1-01A	PB-B1-01A	2	n/a	0.012	13.10	18.64	10.00	0.50	6.11	1.29	4.43	2.00	1.78	643.09	643.04	645.15	644.82
LINE B1	PB-B1-01A	PB-B1-01B	2	n/a	0.012	13.10	20.42	23.33	0.60	6.54	1.22	4.47	1.78	1.76	643.04	642.90	644.82	644.66
LINE B1	PB-B1-01B	PB-B1-01	2	n/a	0.012	13.10	17.56	7.67	0.44	5.81	1.35	4.77	1.76	1.64	642.90	642.87	644.66	644.50
LINE B1	PB-B1-01	MH-B1-01	2	n/a	0.012	14.26	17.69	150.33	0.45	5.90	1.44	5.10	1.64	1.67	642.87	642.19	644.50	643.85
LINE B1	MH-B1-01	PB-B1-02	2	3	0.012	19.37	29.55	49.67	0.20	4.54	1.42	3.85	1.70	1.68	642.15	642.05	643.85	643.73
LINE B1	PB-B1-02	PB-B1-03	2	3	0.012	20.32	29.60	103.01	0.20	4.56	1.48	4.00	1.68	1.69	642.05	641.85	643.73	643.54
LINE B1	PB-B1-03	PB-B1-04	2	3	0.012	22.46	29.57	42.58	0.20	4.65	1.61	4.74	1.69	1.58	641.85	641.76	643.54	643.34
LINE B1	PB-B1-04	MH-B1-02	2	3	0.012	23.92	29.44	23.24	0.20	4.77	1.67	6.35	1.58	1.25	641.76	641.71	643.34	642.97
LINE B1	MH-B1-02	PB-B1-05	2	5	0.012	23.92	58.77	58.17	0.20	4.55	1.05	4.10	1.16	1.17	641.70	641.58	642.86	642.75
LINE B1	PB-B1-05	PB-B1-06	2	5	0.012	25.09	58.59	268.51	0.20	4.63	1.08	4.26	1.17	1.18	641.58	641.04	642.75	642.22
LINE B1	PB-B1-06	OUTLET B1	2	5	0.012	25.09	58.60	30.00	0.20	4.63	1.08	5.45	1.18	0.92	641.04	640.98	642.22	641.91
LAT B1-01	B1-01	PB-B1-01	2	n/a	0.012	1.45	26.27	4.33	0.99	4.26	0.33	0.53	1.60	1.64	642.91	642.87	644.51	644.50
LAT B1-02A	B1-02A	PB-B1-02A	2	n/a	0.012	5.98	52.73	15.00	4.00	10.57	0.47	8.12	1.24	0.57	644.98	644.38	646.23	644.95
LAT B1-02A	PB-B1-02A	MH-B1-01	2	n/a	0.012	5.98	52.73	9.50	4.00	10.57	0.47	7.80	1.29	0.59	644.38	644.00	645.67	644.59
LAT B1-02	B1-02	PB-B1-02	1.5	n/a	0.012	1.31	12.20	4.33	0.99	4.29	0.34	0.76	1.39	1.43	642.34	642.30	643.74	643.73
LAT B5-01	B5-01	B6-01	1.5	n/a	0.012	1.41	7.12	32.55	0.34	2.96	0.47	0.82	1.32	1.42	642.36	642.25	643.68	643.66
LAT B5-01	B6-01	PB-B1-04A	1.5	n/a	0.012	2.92	6.92	5.00	0.32	3.58	0.70	1.73	1.42	1.36	642.24	642.22	643.66	643.58
LAT B5-01	PB-B1-04A	PB-B1-03	1.5	n/a	0.012	2.92	6.94	52.33	0.32	3.58	0.70	1.65	1.36	1.49	642.22	642.05	643.58	643.54
LAT B1-03	B1-03	PB-B1-04	1.5	n/a	0.012	1.95	8.72	4.33	0.51	3.78	0.50	1.18	1.33	1.33	642.03	642.01	643.36	643.34
LAT B1-04	B1-04	PB-B1-05	1.5	n/a	0.012	1.77	12.20	4.33	0.99	4.66	0.40	1.56	0.91	0.92	641.87	641.83	642.79	642.75
LINE B2	B2-02	PB-B2-01	2	n/a	0.012	4.37	26.36	8.00	1.00	5.89	0.57	1.78	1.43	1.46	641.86	641.78	643.29	643.24
LINE B2	PB-B2-01	PB-B2-02	2	n/a	0.012	4.37	26.33	13.44	1.00	5.89	0.57	1.65	1.46	1.57	641.78	641.65	643.24	643.22
LINE B2	PB-B2-02	PB-B2-03	2	n/a	0.012	4.37	10.19											

STORM SEWER GEOPAK DRAINAGE COMPUTATIONS																		
LINE	UPSTREAM NODE	DOWNSTREAM NODE	RISE	SPAN	N VALUE	DISCHARGE	CAPACITY	LENGTH	SLOPE	UNIFORM VELOCITY	UNIFORM DEPTH	ACTUAL VELOCITY	ACTUAL DEPTH UPSTREAM	INVERT UPSTREAM	INVERT DOWN-STREAM	HGL UPSTREAM	HGL DOWN-STREAM	
ID	ID	ID	FT	FT		CFS	CFS	FT	FT/S	FT	FT/S	FT	FT	FT	FT	FT		
LINE E	MH-E1-11	MH-E2-01	3	5	0.012	44.33	133.38	326.82	0.35	6.70	1.32	2.96	2.45	3.00	623.75	622.61	626.21	626.04
LINE E	MH-E2-01	PB-E2-01	3	5	0.012	71.30	159.68	43.45	0.50	8.66	1.65	8.52	3.00	1.67	622.58	622.36	626.04	624.04
LINE E	PB-E2-01	MH-E2-02	3	5	0.012	72.82	159.44	178.55	0.50	8.72	1.67	8.72	1.98	1.67	622.36	621.47	624.34	623.14
LINE E	MH-E2-02	PB-E2-02	3	5	0.012	81.53	159.91	23.45	0.50	9.01	1.81	8.74	2.51	1.87	621.43	621.31	623.94	623.18
LINE E	PB-E2-02	PB-E2-03	3	5	0.012	82.71	159.41	180.00	0.50	9.02	1.83	9.02	2.10	1.83	621.31	620.41	623.42	622.25
LINE E	PB-E2-03	PB-E2-04	3	5	0.012	83.19	159.42	225.19	0.50	9.08	1.83	5.55	3.00	3.00	620.41	619.29	623.43	622.90
LINE E	PB-E2-04	MH-E2-04	3	5	0.012	83.20	159.64	18.55	0.50	9.08	1.83	5.55	3.00	3.00	619.29	619.19	622.90	622.85
LINE E	MH-E2-04	PB-E2-05B	3	5	0.012	99.73	123.57	112.50	0.30	7.96	2.51	6.65	3.00	3.00	619.01	618.67	622.85	622.01
LINE E	PB-E2-05B	PB-E2-06	3	5	0.012	101.21	123.59	25.95	0.30	7.93	2.55	6.75	3.00	3.00	618.67	618.59	622.01	621.89
LINE E	PB-E2-06	PB-E2-07	3	5	0.012	101.90	123.48	250.00	0.30	7.84	2.60	6.79	3.00	3.00	618.59	617.84	621.89	621.05
LINE E	PB-E2-07	MH-E2-05	3	5	0.012	102.96	123.53	145.55	0.30	7.92	2.60	6.86	3.00	3.00	617.84	617.40	621.05	620.51
LINE E	MH-E2-05	PB-E2-08	3	7	0.012	132.99	193.65	96.45	0.30	8.35	2.27	8.04	3.00	2.36	617.38	617.09	620.51	619.45
LINE E	PB-E2-08	MH-E2-06	3	7	0.012	133.32	193.50	174.55	0.30	8.38	2.27	6.81	2.36	2.80	617.09	616.57	619.45	619.36
LINE E	MH-E2-06	PB-E2-09	3	7	0.012	144.43	193.63	62.87	0.30	8.55	2.41	8.49	2.82	2.43	616.54	616.35	619.36	618.78
LINE E	PB-E2-09	PB-E2-10	3	7	0.012	144.89	193.43	175.00	0.30	8.58	2.41	8.47	2.43	2.44	616.35	615.83	618.78	618.27
LINE E	PB-E2-10	PB-E2-11	3	7	0.012	145.58	193.65	189.58	0.30	8.62	2.41	8.49	2.44	2.45	615.83	615.26	618.27	617.71
LINE E	PB-E2-11	PB-E2-12	3	7	0.012	146.31	193.74	38.55	0.30	8.66	2.41	8.54	2.45	2.45	615.26	615.14	617.71	617.59
LINE E	PB-E2-12	PB-E2-14	3	7	0.012	147.02	193.55	181.45	0.30	8.70	2.41	8.04	2.45	2.61	615.14	614.60	617.59	617.21
LINE E	PB-E2-14	PB-E2-15	3	7	0.012	147.87	193.59	72.55	0.30	8.59	2.46	7.66	2.61	2.76	614.60	614.38	617.21	617.14
LINE E	PB-E2-15	PB-E2-17	3	7	0.012	152.56	193.44	58.66	0.30	8.70	2.51	7.82	2.76	2.79	614.38	614.20	617.14	616.99
LINE E	PB-E2-17	MH-E2-08	3	7	0.012	158.74	193.95	46.75	0.30	8.88	2.55	9.00	2.79	2.52	614.20	614.06	616.99	616.58
LINE E	MH-E2-08	PB-E2-19	3	10	0.012	175.30	247.74	57.64	0.30	7.71	2.27	7.45	2.33	2.35	614.04	613.86	616.36	616.22
LINE E	PB-E2-19	PB-E2-20	3	10	0.012	175.60	246.95	13.33	0.30	7.57	2.32	7.45	2.35	2.36	613.86	613.82	616.22	616.18
LINE E	PB-E2-20	PB-E2-22	3	10	0.012	177.72	246.97	232.99	0.30	7.66	2.32	7.72	2.36	2.30	613.82	613.12	616.18	615.43
LINE E	PB-E2-22	OUTLET E	3	10	0.012	177.72	247.30	107.71	0.30	7.66	2.32	8.30	2.30	2.14	613.12	612.80	615.43	614.94
LAT E1-02	E1-02	MH-E1-01	2	n/a	0.012	1.89	15.68	13.00	0.35	3.22	0.48	1.09	1.06	1.08	638.50	638.45	639.55	639.53
LAT E1-03	E1-03	PB-E1-01A	2	n/a	0.012	1.42	26.34	4.91	1.00	4.25	0.33	0.82	1.04	1.08	638.35	638.30	639.39	639.38
LAT E1-04	E1-04	PB-E1-02	2	n/a	0.012	1.52	26.34	4.91	1.00	4.33	0.34	0.82	1.10	1.14	637.49	637.44	638.59	638.58
LAT E1-05	E1-05	PB-E1-02A	2	n/a	0.012	1.49	26.34	4.91	1.00	4.30	0.33	0.76	1.16	1.20	636.77	636.72	637.93	637.92
LAT E1-06	E1-06	PB-E1-03	2	n/a	0.012	1.72	26.34	4.91	1.00	4.49	0.36	0.78	1.28	1.32	636.15	636.10	637.43	637.42
LAT E1-07	E1-07	PB-E1-04	2	n/a	0.012	1.56	18.82	4.91	0.51	3.45	0.40	0.69	1.34	1.36	635.46	635.44	636.81	636.80
LAT E1-08	E1-08	PB-E1-05	2	n/a	0.012	1.51	26.34	4.91	1.00	4.31	0.34	0.63	1.38	1.42	634.85	634.80	636.22	636.22
LAT E1-09	E1-09	PB-E1-06	2	n/a	0.012	1.50	26.34	4.91	1.00	4.32	0.34	0.60	1.44	1.48	634.21	634.16	635.65	635.64
LAT E1-10	E1-10	PB-E1-07	2	n/a	0.012	1.53	26.61	4.91	1.02	4.37	0.34	0.59	1.51	1.55	633.57	633.52	635.08	635.07
LAT E1-11	E1-11	PB-E1-08	2	n/a	0.012	1.54	26.34	4.91	1.00	4.35	0.34	0.59	1.50	1.54	632.82	632.77	634.32	634.31
LAT E1-12	E1-12	PB-E1-09	2	n/a	0.012	1.38	26.34	4.91	1.00	4.21	0.32	0.52	1.54	1.59	632.07	632.02	633.61	633.61
LAT E1-13	E1-13	PB-E1-10	2	n/a	0.012	1.36	26.34	4.91	1.00									

STORM SEWER GEOPAK DRAINAGE COMPUTATIONS																		
LINE	UPSTREAM NODE	DOWNSTREAM NODE	RISE	SPAN	N VALUE	DISCHARGE	CAPACITY	LENGTH	SLOPE	UNIFORM VELOCITY	UNIFORM DEPTH	ACTUAL VELOCITY	ACTUAL DEPTH DOWN-STREAM	INVERT UPSTREAM	INVERT DOWN-STREAM	HGL UPSTREAM	HGL DOWN-STREAM	
ID	ID	ID	FT	FT		CFS	CFS	FT	%	FT/S	FT	FT/S	FT	FT	FT	FT	FT	
LAT E2-12	E2-12	MH-E2-05	2	n/a	0.012	34.77	26.36	4.00	1.00	11.36	2.00	11.07	2.00	2.00	617.93	617.89	624.15	620.51
LAT E2-13	E2-13	PB-E2-08	2	n/a	0.012	1.47	18.82	4.91	0.51	3.37	0.39	0.48	1.84	1.86	617.61	617.59	619.46	619.45
LAT E2-14	E2-14	MH-E2-06	2	n/a	0.012	15.05	14.44	4.00	0.30	4.92	2.00	4.79	2.00	2.00	617.13	617.12	619.76	619.36
LAT E2-15	E2-15	PB-E2-09	1.5	n/a	0.012	1.37	14.93	4.91	1.49	4.99	0.32	0.78	1.50	1.50	616.92	616.85	618.79	618.78
LAT E2-16	E2-16	PB-E2-10	1.5	n/a	0.012	1.06	21.19	4.91	3.00	5.93	0.24	0.60	1.50	1.50	616.47	616.33	618.28	618.27
LAT E2-17	E2-17	PB-E2-11	1.5	n/a	0.012	1.12	21.19	4.91	3.00	6.03	0.24	0.63	1.50	1.50	615.90	615.76	617.71	617.71
LAT E2-19	E2-19	PB-E2-14	1.5	n/a	0.012	1.32	21.19	4.91	3.00	6.34	0.26	0.75	1.50	1.50	615.19	615.05	617.22	617.21
LAT E2-20	E2-20	PB-E2-16	2	n/a	0.012	8.05	58.95	10.00	5.00	12.47	0.52	8.43	1.49	0.69	616.06	615.56	617.55	616.25
LAT E2-20	PB-E2-16	PB-E2-15	2	n/a	0.012	8.05	47.24	21.21	3.21	10.64	0.58	2.56	1.61	2.00	615.56	614.88	617.17	617.14
LAT E2-21	E2-21	PB-E2-18	2	n/a	0.012	8.36	55.30	5.00	4.40	12.04	0.55	3.11	1.53	1.60	615.68	615.46	617.21	617.06
LAT E2-21	PB-E2-18	PB-E2-17	2	n/a	0.012	8.36	55.11	17.32	4.37	12.01	0.55	2.66	1.60	2.00	615.46	614.70	617.06	616.99
LAT E2-22	E2-22	MH-E2-08	2	n/a	0.012	19.24	26.03	2.15	0.97	8.53	1.35	6.42	2.00	1.82	614.57	614.55	617.40	616.36
LAT E2-23	E2-23	PB-E2-19A	1.5	n/a	0.012	1.32	12.24	8.00	1.00	4.29	0.35	0.75	1.50	1.50	614.48	614.40	616.23	616.22
LAT E2-23	PB-E2-19A	PB-E2-19	1.5	n/a	0.012	1.32	12.24	14.89	1.00	4.29	0.35	0.75	1.50	1.50	614.40	614.25	616.22	616.22
LAT E2-24	E2-24	PB-E2-21	2	n/a	0.012	2.87	68.24	5.00	6.70	10.21	0.29	6.63	0.80	0.39	616.38	616.05	617.19	616.44
LAT E2-24	PB-E2-21	PB-E2-20	2	n/a	0.012	2.87	68.54	25.55	6.76	10.24	0.29	9.35	0.69	0.31	616.05	614.32	616.74	614.63
LINE E3	E3-01	PB-E3-01	2	5	0.012	65.02	585.97	30.00	5.00	14.53	0.45	11.65	1.85	0.56	614.34	612.84	616.20	613.40
LINE E3	PB-E3-01	PB-E3-02	2	5	0.012	65.02	128.62	41.93	0.24	5.25	1.24	4.49	1.71	1.45	612.84	612.74	614.55	614.19
LINE E3	PB-E3-02	OUTLET E3	2	5	0.012	71.26	128.47	157.26	0.24	5.48	1.30	6.12	1.45	1.16	612.74	612.36	614.19	613.53
LAT E3-02	E3-02	E3-03	1.5	n/a	0.012	6.94	14.64	11.75	0.36	3.87	0.76	2.19	1.30	1.26	613.26	613.22	614.57	614.48
LAT E3-02	E3-03	PB-E3-02	1.5	n/a	0.012	8.39	14.71	61.53	0.36	4.08	0.85	2.78	1.27	1.20	613.21	612.99	614.48	614.19
LINE F1	F1-01	PB-F1-01	2	n/a	0.012	1.94	26.57	4.33	1.02	4.68	0.38	4.13	0.66	0.41	611.66	611.62	612.32	612.03
LINE F1	PB-F1-01	MH-F1-01	2	n/a	0.012	1.94	18.65	161.52	0.50	3.65	0.45	3.65	0.60	0.45	611.62	610.81	612.21	611.26
LINE F1	MH-F1-01	PB-F1-02	2	n/a	0.012	1.94	18.61	52.79	0.50	3.65	0.45	0.82	1.14	1.40	610.79	610.53	611.93	611.93
LINE F1	PB-F1-02	PB-F1-03	2	n/a	0.012	4.51	18.65	100.54	0.50	4.63	0.70	4.63	1.40	0.70	610.53	610.02	611.93	610.72
LINE F1	PB-F1-03	OUTLET F1	2	n/a	0.012	4.51	18.19	15.54	0.48	4.57	0.70	4.53	1.11	0.71	610.02	609.95	611.14	610.66
LAT F1-02	F1-02	PB-F1-02	2	n/a	0.012	2.76	26.25	4.34	0.99	5.14	0.45	1.17	1.38	1.40	610.57	610.53	611.95	611.93
LINE F2	F2-01	PB-F2-01	2	n/a	0.012	1.95	23.70	4.33	0.81	4.32	0.40	2.46	0.66	0.60	619.49	619.45	620.15	620.05
LINE F2	PB-F2-01	MH-F2-01	2	n/a	0.012	1.95	23.58	255.83	0.80	4.32	0.40	4.32	0.60	0.40	619.45	617.40	620.05	617.81
LINE F2	MH-F2-01	PB-F2-02	2	n/a	0.012	1.95	25.02	60.17	0.90	4.49	0.39	1.02	0.56	1.17	617.37	616.83	617.92	618.00
LINE F2	PB-F2-02	MH-F2-02	2	n/a	0.012	3.80	25.01	185.83	0.90	5.47	0.55	5.47	1.17	0.55	616.83	615.15	618.00	615.70
LINE F2	MH-F2-02	PB-F2-03	2	n/a	0.012	3.80	18.65	40.17	0.50	4.41	0.64	2.16	0.88	1.09	615.13	614.93	616.01	616.02
LINE F2	PB-F2-03	MH-F2-03	2	n/a	0.012	5.05	18.65	195.83	0.50	4.77	0.74	4.77	1.09	0.74	614.93	613.95	616.02	614.69
LINE F2	MH-F2-03	PB-F2-04	2	n/a	0.012	5.05	18.66	20.17	0.50	4.77	0.74	2.59	1.09	1.19	613.93	613.83	615.01	615.02
LINE F2	PB-F2-04	PB-F2-05	2	n/a	0.012	6.11	18.64	220.56	0.50	5.03	0.82	1.95	1.19	2.00	613.83	612.72	615.02	614.82
LINE F2	PB-F2-05	MH-F2-04	2	n/a	0.012	10.87	18.66	6.19	0.50	5.85	1.14	5.79	2.00	1.15	612.72	612.69	614.82	613.85
LINE F2	MH-F2-04	PB-F2-06	2	n/a	0.012	10.87	18											

STORM SEWER GEOPAK DRAINAGE COMPUTATIONS

LINE	UPSTREAM NODE	DOWNSTREAM NODE	RISE	SPAN	N VALUE	DISCHARGE	CAPACITY	LENGTH	SLOPE	UNIFORM VELOCITY	UNIFORM DEPTH	ACTUAL VELOCITY	ACTUAL DEPTH UPSTREAM	INVERT UPSTREAM	INVERT DOWN-STREAM	HGL UPSTREAM	HGL DOWN-STREAM	
ID	ID	ID	FT	FT		CFS	CFS	FT	%	FT/S	FT	FT/S	FT	FT	FT	FT		
LINE H	G3-01	PB-G3-01	2	n/a	0.012	2.70	37.28	74.75	2.00	6.56	0.38	6.51	0.78	0.38	618.30	616.80	619.08	617.18
LINE H	PB-G3-01	MH-G3-01	2	n/a	0.012	5.35	18.64	203.00	0.50	4.86	0.76	4.86	1.55	0.76	616.80	615.79	618.36	616.55
LINE H	MH-G3-01	PB-H1-01	2	n/a	0.012	5.35	18.66	20.17	0.50	4.86	0.76	2.87	1.04	1.15	615.77	615.67	616.81	616.81
LINE H	PB-H1-01	PB-H1-02	2	n/a	0.012	6.47	18.64	220.00	0.50	5.08	0.85	5.08	1.15	0.85	615.67	614.57	616.81	615.42
LINE H	PB-H1-02	MH-H1-01	2	n/a	0.012	7.57	18.67	55.83	0.50	5.33	0.92	5.33	1.21	0.92	614.57	614.29	615.78	615.21
LINE H	MH-H1-01	PB-H1-03	2	n/a	0.012	7.57	18.64	160.17	0.50	5.33	0.92	2.51	1.01	1.83	614.27	613.47	615.27	615.29
LINE H	PB-H1-03	MH-H1-02	2	n/a	0.012	11.03	16.69	105.83	0.40	5.36	1.25	5.35	1.83	1.25	613.47	613.04	615.29	614.29
LINE H	MH-H1-02	PB-H1-04	2	n/a	0.012	11.03	16.68	140.17	0.40	5.36	1.25	4.30	1.26	1.52	613.03	612.47	614.29	613.99
LINE H	PB-H1-04	MH-H1-03	2	n/a	0.012	12.15	16.50	115.83	0.39	5.39	1.35	5.50	1.52	1.33	612.47	612.01	613.99	613.34
LINE H	MH-H1-03	PB-H1-05	2	n/a	0.012	12.52	18.64	130.17	0.50	6.00	1.26	6.00	1.35	1.26	611.99	611.34	613.34	612.60
LINE H	PB-H1-05	MH-H1-04	2	n/a	0.012	13.73	18.65	155.83	0.50	6.09	1.35	6.14	1.56	1.34	611.34	610.56	612.90	611.90
LINE H	MH-H1-04	PB-H1-06	2	n/a	0.012	13.73	18.65	80.17	0.50	6.09	1.35	5.12	1.36	1.59	610.54	610.14	611.90	611.73
LINE H	PB-H1-06	MH-H1-05	2	n/a	0.012	14.75	18.64	195.83	0.50	6.24	1.41	5.58	1.59	1.57	610.14	609.16	611.73	610.73
LINE H	MH-H1-05	PB-H1-07	2	n/a	0.012	14.75	18.65	30.17	0.50	6.24	1.41	5.28	1.59	1.66	609.14	608.99	610.73	610.65
LINE H	PB-H1-07	PB-H1-08	2	n/a	0.012	15.78	18.64	230.00	0.50	6.26	1.50	5.46	1.66	1.73	608.99	607.84	610.65	609.57
LINE H	PB-H1-08	MH-H1-06	2	n/a	0.012	16.73	18.70	25.83	0.50	6.27	1.58	6.29	1.58	1.58	607.84	607.71	609.57	609.29
LINE H	MH-H1-06	PB-H1-09	2	n/a	0.012	16.73	18.64	200.17	0.50	6.27	1.58	5.69	1.60	1.77	607.69	606.69	609.29	608.46
LINE H	PB-H1-09	MH-H1-08	2	n/a	0.012	17.51	18.66	74.83	0.50	6.34	1.64	6.89	1.77	1.51	606.69	606.31	608.46	607.82
LINE H	MH-H1-08	PB-H1-10	3	4	0.012	17.70	98.01	149.17	0.35	5.15	0.86	1.81	2.59	2.44	605.18	604.66	607.78	607.10
LINE H	PB-H1-10	PB-H1-11	3	4	0.012	18.65	98.05	225.00	0.35	5.29	0.88	1.55	2.44	3.00	604.66	603.88	607.10	607.07
LINE H	PB-H1-11	MH-H1-09	3	4	0.012	19.54	98.84	9.83	0.36	5.40	0.90	1.63	3.00	3.00	603.88	603.84	607.07	607.06
LINE H	MH-H1-09	PB-J1-24	3	4	0.012	19.54	98.02	68.00	0.35	5.40	0.90	1.63	3.00	3.00	603.79	603.55	607.06	606.99
LINE J	J1-01	PB-J1-01	2	n/a	0.012	1.41	26.57	4.33	1.02	4.24	0.32	0.56	1.44	1.48	616.11	616.07	617.56	617.55
LINE J	PB-J1-01	PB-J1-02	2	n/a	0.012	1.41	16.67	220.00	0.40	3.06	0.41	0.45	1.48	2.00	616.07	615.19	617.55	617.54
LINE J	PB-J1-02	MH-J1-01	2	n/a	0.012	2.69	16.76	15.33	0.40	3.69	0.56	0.86	2.00	2.00	615.19	615.13	617.54	617.52
LINE J	MH-J1-01	PB-J1-03	2	n/a	0.012	2.69	16.68	199.67	0.40	3.69	0.56	0.86	2.00	2.00	615.11	614.31	617.52	617.49
LINE J	PB-J1-03	MH-J1-02	2	n/a	0.012	3.88	16.76	15.33	0.40	4.11	0.68	1.24	2.00	2.00	614.31	614.25	617.49	617.46
LINE J	MH-J1-02	PB-J1-04	3	3	0.012	24.33	69.65	119.67	0.40	6.13	1.32	5.38	3.00	1.51	613.23	612.75	617.46	614.25
LINE J	PB-J1-04	PB-J1-05	3	3	0.012	25.57	69.63	80.00	0.40	6.23	1.37	5.42	1.51	1.57	612.75	612.43	614.25	614.00
LINE J	PB-J1-05	PB-J1-06	3	3	0.012	26.96	69.63	80.00	0.40	6.35	1.42	5.55	1.57	1.62	612.43	612.11	614.00	613.73
LINE J	PB-J1-06	MH-J1-03	3	3	0.012	28.29	70.00	15.33	0.40	6.45	1.46	6.22	1.62	1.52	612.11	612.04	613.73	613.56
LINE J	MH-J1-03	PB-J1-07	3	3	0.012	28.29	69.68	59.67	0.40	6.45	1.46	5.63	1.54	1.68	612.02	611.79	613.56	613.46
LINE J	PB-J1-07	PB-J1-08	3	3	0.012	29.62	69.63	75.00	0.40	6.45	1.53	5.75	1.68	1.72	611.79	611.49	613.46	613.20
LINE J	PB-J1-08	PB-J1-09	3	3	0.012	30.89	69.63	75.00	0.40	6.53	1.58	5.86	1.72	1.76	611.49	611.19	613.20	612.94
LINE J	PB-J1-09	PB-J1-10	3	3	0.012	32.19	69.63	70.00	0.40	6.61	1.62	6.11	1.76	1.76	611.19	610.91	612.94	612.66
LINE J	PB-J1-10	MH-J1-04	3	3	0.012	33.42	70.00	15.33	0.40	6.67	1.67	7.10	1.76	1.57	610.91	610.84	612.66	612.41
LINE J	MH-J1-04	PB-J1-11	3	3	0.012	33.42	77.95	49.67	0.50	7.27	1.53	7.27	1.58	1.53	610.82	610.57	612.40	612.10
LINE J	PB-J1-11	PB-J1-12	3	3	0.012	34.67	77.84	70.00										

STORM SEWER GEOPAK DRAINAGE COMPUTATIONS																		
LINE	UPSTREAM NODE	DOWNTSTREAM NODE	RISE	SPAN	N VALUE	DISCHARGE	CAPACITY	LENGTH	SLOPE	UNIFORM VELOCITY	UNIFORM DEPTH	ACTUAL VELOCITY	ACTUAL DEPTH DOWN-STREAM	INVERT UPSTREAM	INVERT DOWN-STREAM	HGL UPSTREAM	HGL DOWN-STREAM	
ID	ID	ID	FT	FT		CFS	CFS	FT	%	FT/S	FT	FT/S	FT	FT	FT	FT	FT	
LAT H1-11	H1-11	PB-H1-09	2	n/a	0.012	1.37	26.57	4.33	1.02	4.24	0.32	0.47	1.73	1.77	606.73	606.69	608.46	608.46
LAT H1-12	H1-12	MH-H1-08	2	n/a	0.012	0.38	37.28	15.00	2.00	3.64	0.15	0.13	1.54	1.83	606.25	605.95	607.78	607.78
LAT H1-13	H1-13	PB-H1-10	2	n/a	0.012	1.55	18.79	4.33	0.51	3.42	0.40	0.50	1.92	1.94	605.18	605.16	607.11	607.10
LAT H1-14	H1-14	PB-H1-11	2	n/a	0.012	1.66	34.93	4.33	1.76	5.41	0.31	0.53	2.00	2.00	604.35	604.27	607.08	607.07
LAT J1-02	J1-02	PB-J1-02	2	n/a	0.012	1.42	18.79	4.33	0.51	3.34	0.39	0.45	2.00	2.00	615.21	615.19	617.55	617.54
LAT J1-03	J1-03	PB-J1-03	2	n/a	0.012	1.41	26.57	4.33	1.02	4.25	0.32	0.45	2.00	2.00	614.35	614.31	617.50	617.49
LAT J1-04	J1-04	MH-J1-02	2	3	0.012	20.82	93.60	15.00	2.00	10.43	0.67	3.47	2.00	2.00	614.54	614.24	617.67	617.46
LAT J1-05	J1-05	PB-J1-04	2	n/a	0.012	1.69	26.57	4.33	1.02	4.49	0.35	1.06	0.98	1.01	613.29	613.25	614.27	614.25
LAT J1-06	J1-06	PB-J1-05	2	n/a	0.012	1.77	26.57	4.33	1.02	4.57	0.36	1.03	1.05	1.07	612.97	612.93	614.02	614.00
LAT J1-07	J1-07	PB-J1-06	2	n/a	0.012	1.70	27.17	4.33	1.06	4.57	0.35	0.94	1.09	1.12	612.65	612.61	613.74	613.73
LAT J1-08	J1-08	PB-J1-07	2	n/a	0.012	1.73	26.57	4.33	1.02	4.53	0.36	0.90	1.15	1.18	612.33	612.29	613.48	613.46
LAT J1-09	J1-09	PB-J1-08	2	n/a	0.012	1.67	26.57	4.33	1.02	4.48	0.35	0.83	1.18	1.22	612.03	611.99	613.21	613.20
LAT J1-10	J1-10	PB-J1-09	2	n/a	0.012	1.71	26.57	4.33	1.02	4.53	0.36	0.82	1.22	1.26	611.73	611.69	612.95	612.94
LAT J1-11	J1-11	PB-J1-10	2	n/a	0.012	1.63	26.57	4.33	1.02	4.44	0.35	0.78	1.22	1.26	611.45	611.41	612.67	612.66
LAT J1-12	J1-12	PB-J1-11	2	n/a	0.012	1.66	26.57	4.33	1.02	4.48	0.35	0.82	1.19	1.23	611.11	611.07	612.31	612.30
LAT J1-13	J1-13	PB-J1-12	2	n/a	0.012	1.69	26.57	4.33	1.02	4.50	0.35	0.80	1.23	1.27	610.76	610.72	612.00	611.99
LAT J1-14	J1-14	PB-J1-13	2	n/a	0.012	1.72	26.57	4.33	1.02	4.51	0.36	0.79	1.27	1.31	610.41	610.37	611.69	611.68
LAT J1-15	J1-15	PB-J1-14	2	n/a	0.012	1.62	26.57	4.33	1.02	4.45	0.35	0.72	1.31	1.34	610.09	610.04	611.40	611.39
LAT J1-16	J1-16	PB-J1-15	2	n/a	0.012	1.64	26.57	4.33	1.02	4.45	0.35	0.72	1.33	1.37	609.76	609.72	611.10	611.09
LAT J1-17	J1-17	PB-J1-16	2	n/a	0.012	1.67	26.57	4.33	1.02	4.48	0.35	0.71	1.37	1.41	609.44	609.39	610.81	610.80
LAT J1-18	J1-18	PB-J1-17	2	n/a	0.012	1.75	26.57	4.33	1.02	4.54	0.36	0.72	1.41	1.44	608.96	608.92	610.37	610.36
LAT J1-19	J1-19	PB-J1-18	2	n/a	0.012	1.72	26.57	4.33	1.02	4.51	0.36	0.69	1.44	1.48	608.46	608.42	609.90	609.90
LAT J1-20	J1-20	PB-J1-19	2	n/a	0.012	1.65	26.27	4.33	0.99	4.43	0.35	0.66	1.45	1.48	607.38	607.33	608.83	608.82
LAT J1-21	J1-21	PB-J1-20	2	n/a	0.012	2.01	26.27	4.33	0.99	4.69	0.39	0.77	1.52	1.56	606.75	606.70	608.27	608.26
LAT J1-22	J1-22	MH-J1-07	2	n/a	0.012	3.26	26.27	14.00	0.99	5.42	0.49	1.04	2.00	2.00	605.21	605.07	607.31	607.29
LAT J1-23	J1-23	PB-J1-21	2	n/a	0.012	2.52	26.57	4.33	1.02	5.07	0.43	0.80	2.00	2.00	604.75	604.71	607.25	607.24
LAT J1-24	J1-24	PB-J1-22	2	n/a	0.012	1.67	26.27	4.33	0.99	4.44	0.35	0.53	2.00	2.00	604.14	604.10	606.98	606.97

△ ADDENDUM 1.
3/22/23.
REVISED SHEET
SHEET 9 OF 9

CP&Y

TEXAS REGISTERED ENGINEERING FIRM, F-1741


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FROM FM 2514 (PARKER ROAD) TO FM 2170 (MAIN STREET)
FM 2551 (MURPHY ROAD)

STORM SEWER COMPUTATIONS


Designed:	CPY	FED. RD. NO.	STATE	PROJECT NO.	HIGHWAY NO.
Checked:	CPY	6	TEXAS	SEE TITLE SHEET	FM 2551
Drawn:	CPY	DIST.	COUNTY	CONTROL SECTION NO.	JOB NO.
Checked:	CPY	DALLAS	COLLIN	02056	SET NO. 042

Kristen L. Perry

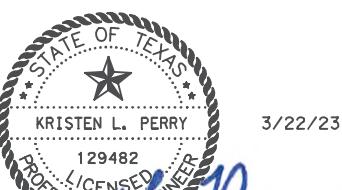

3/22/23

MATCH LINE STA 31+00.00

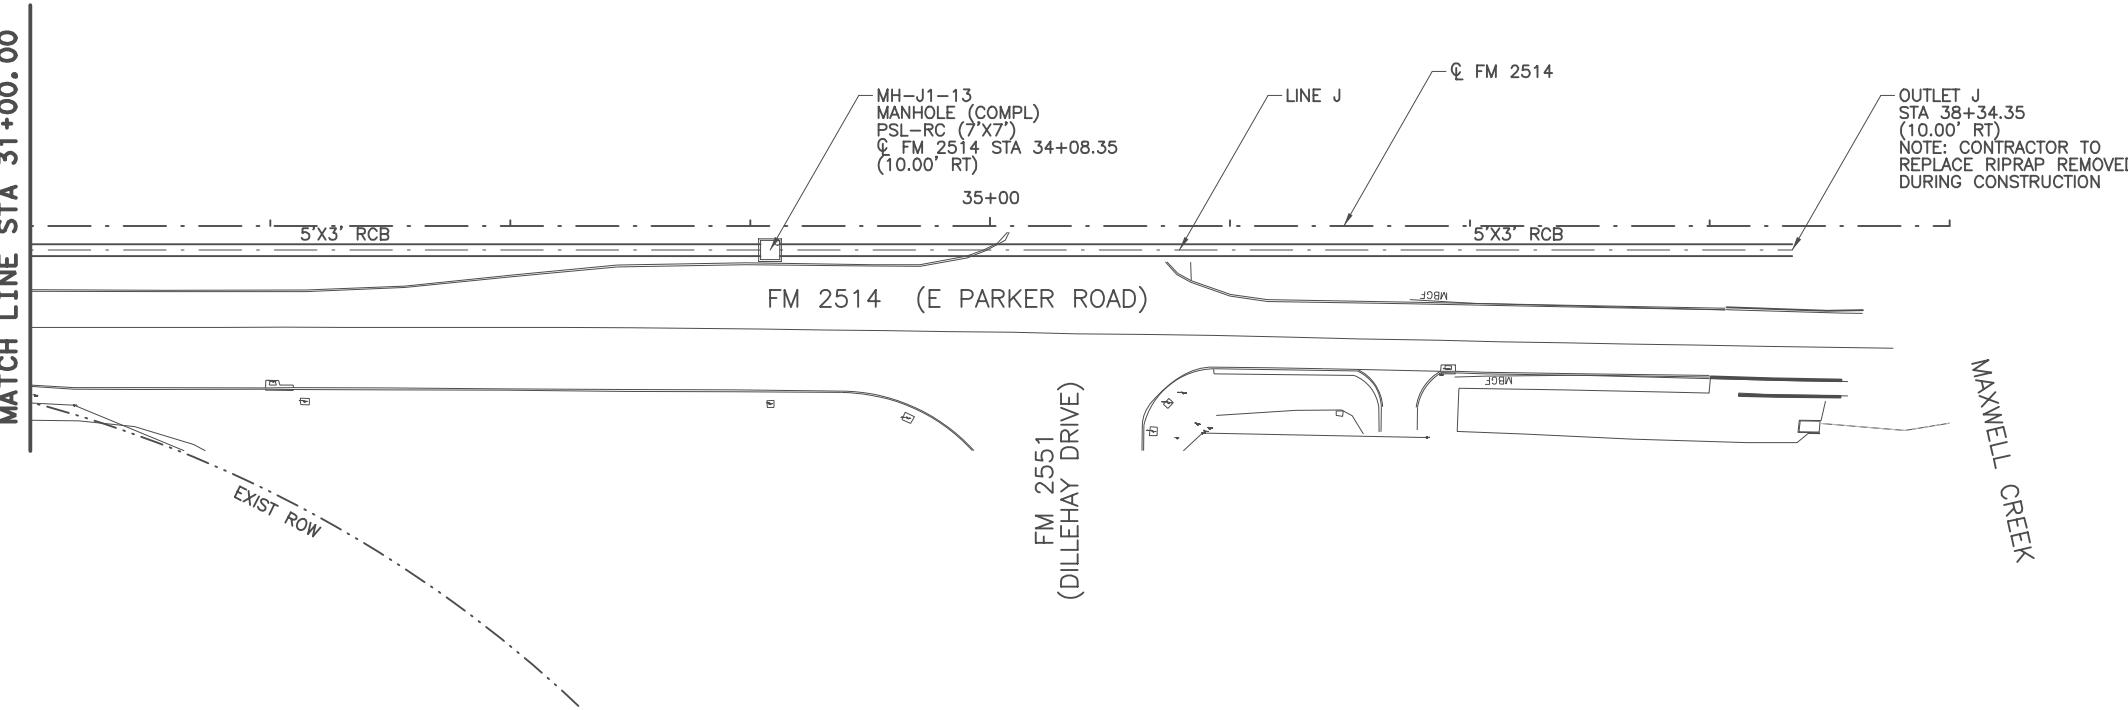

40 20 0 40 80
SCALE FEET
HORIZONTAL: 1" = 80'
4 2 0 4 8
SCALE FEET
VERTICAL: 1" = 8'

LEGEND


- EXISTING DITCH
- PROPOSED DITCH

NOTES:

- ALL STATIONS AND OFFSETS ARE FROM **FM 2551** UNLESS OTHERWISE SPECIFIED.
- ALL LOCATIONS FOR CURB INLETS ARE SHOWN TO THE FACE OF CURB.
- ALL LOCATIONS FOR DITCH INLETS AND MANHOLES ARE SHOWN TO CENTER POINT OF INLET BOX OR MANHOLE STACK, UNLESS NOTED OTHERWISE.
- REFERENCE ROADWAY PLAN AND PROFILE SHEETS FOR ADDITIONAL INFORMATION.
- REFERENCE CULVERT SHEETS FOR ADDITIONAL INFORMATION.
- REFERENCE LATERAL PROFILE SHEETS FOR ADDITIONAL LINE AND LATENT INFORMATION.
- GEOPAK DRAINAGE WAS USED FOR STORM SEWER COMPUTATIONS.
- ALL PIPE SHALL BE CLASS III UNLESS NOTED OTHERWISE.

Kristen L. Perry 3/22/23
Kristen L. Perry
STATE OF TEXAS
PROFESSIONAL ENGINEER
LICENSE NO. 129482
3/22/23

MATCH LINE STA 31+00.00

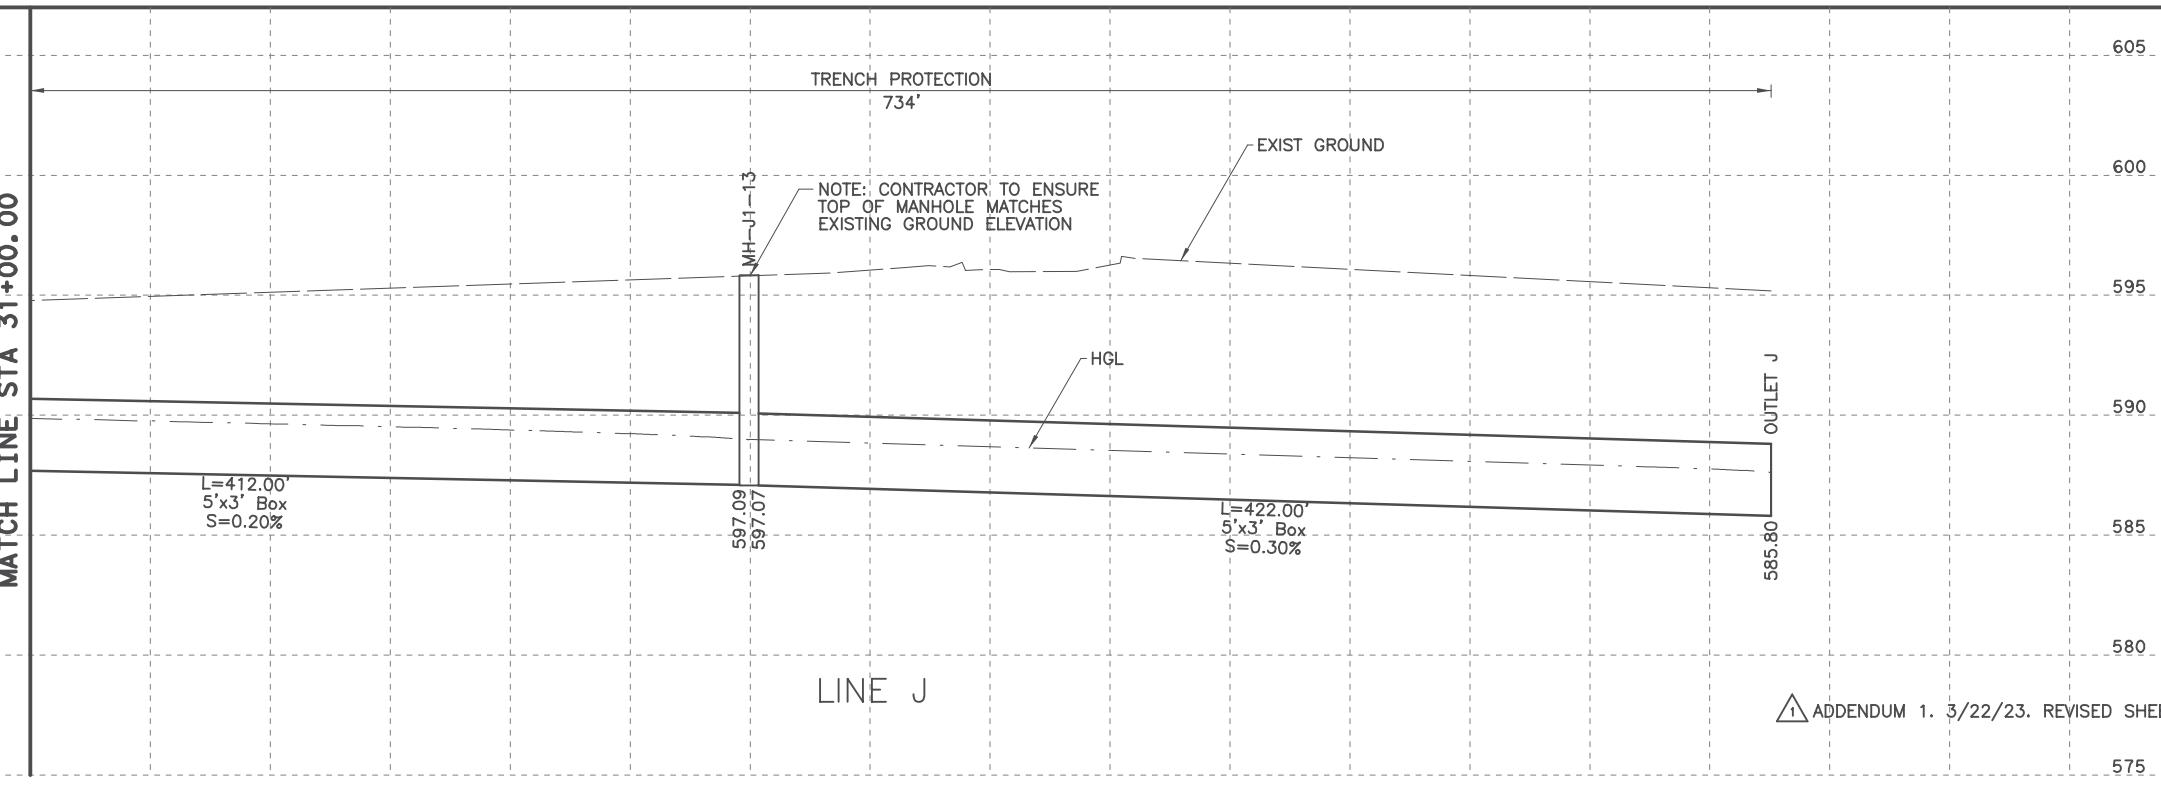

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FROM FM 2514 (PARKER ROAD) TO FM 2170 (MAIN STREET)
FM 2514 (PARKER ROAD)

DRAINAGE PLAN AND PROFILE
STA 31+00.00 TO END PROJECT



TEXAS REGISTERED ENGINEERING FIRM. F-1741

Highway No. FM 2551

Design: CPY FED. DIV. RD. NO. STATE PROJECT NO. HIGHWAY NO.

Checked: CPY 6 TEXAS SEE TITLE SHEET

Drawn: CPY DIST. COUNTY CONTROL SECTION NO. JOB NO.

Checked: CPY DALLAS COLLIN 2056 01 042 269

MATCH LINE STA 23+00.00

25+00


MH-J1-11
MANHOLE (COMPL)
PSL-RC (7'X7')
Q FM 2514 STA 25+58.35
(10.00' RT)

LINE J

Q FM 2514

MH-J1-12
MANHOLE (COMPL)
PSL-RC (7'X7')
Q FM 2514 STA 29+88.35
(10.00' RT)

FM 2514 (E PARKER ROAD)

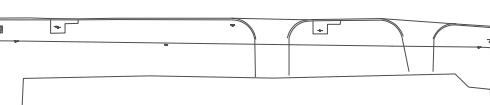

MATCH LINE STA 31+00.00

30+00

40 20 0 40 80
SCALE FEET
HORIZONTAL: 1" = 80'
4 2 0 4 8
SCALE FEET
VERTICAL: 1" = 8'

LEGEND

- Existing Ditch
- Proposed Ditch

NOTES:

1. ALL STATIONS AND OFFSETS ARE FROM Q FM2551 UNLESS OTHERWISE SPECIFIED.
2. ALL LOCATIONS FOR CURB INLETS ARE SHOWN TO THE FACE OF CURB.
3. ALL LOCATIONS FOR DITCH INLETS AND MANHOLES ARE SHOWN TO CENTER POINT OF INLET BOX OR MANHOLE STACK, UNLESS NOTED OTHERWISE.
4. REFERENCE ROADWAY PLAN AND PROFILE SHEETS FOR ADDITIONAL INFORMATION.
5. REFERENCE CULVERT SHEETS FOR ADDITIONAL INFORMATION.
6. REFERENCE LATERAL PROFILE SHEETS FOR ADDITIONAL LINE AND LATENT INFORMATION.
7. GEOPAK DRAINAGE WAS USED FOR STORM SEWER COMPUTATIONS.
8. ALL PIPE SHALL BE CLASS III UNLESS NOTED OTHERWISE.

MATCH LINE STA 23+00.00

TRENCH PROTECTION
800'

EXIST GROUND

NOTE: CONTRACTOR TO ENSURE
TOP OF MANHOLE MATCHES
EXISTING GROUND ELEVATION

NOTE: CONTRACTOR TO ENSURE
TOP OF MANHOLE MATCHES
EXISTING GROUND ELEVATION

L=352.00'
5'x3' Box
S=0.30%

598.79
598.77

L=422.00'
5'x3' Box
S=0.20%

597.93
597.91

LINE J

KRISTEN L. PERRY
129482
LICENSED PROFESSIONAL ENGINEER
3/22/23

CP&Y

TEXAS REGISTERED ENGINEERING FIRM, F-1741




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FROM FM 2514 (PARKER ROAD) TO FM 2170 (MAIN STREET)
FM 2514 (PARKER ROAD)

DRAINAGE PLAN AND PROFILE
STA 23+00.00 TO STA 31+00.00

ADDENDUM 1. 3/22/23. REVISED SHEET
SHEET 2 OF 25

Designed	CPY	FED. DIV.	RD. NO.	STATE	PROJECT NO.	HIGHWAY NO.
Checked	CPY	6	TEXAS	SEE TITLE SHEET		FM 2551
Drawn	CPY	DIST.	COUNTY	CONTROL SECTION NO.	JOB NO.	SHEET NO.
Checked	CPY	DALLAS	COLLIN	2056	01	042

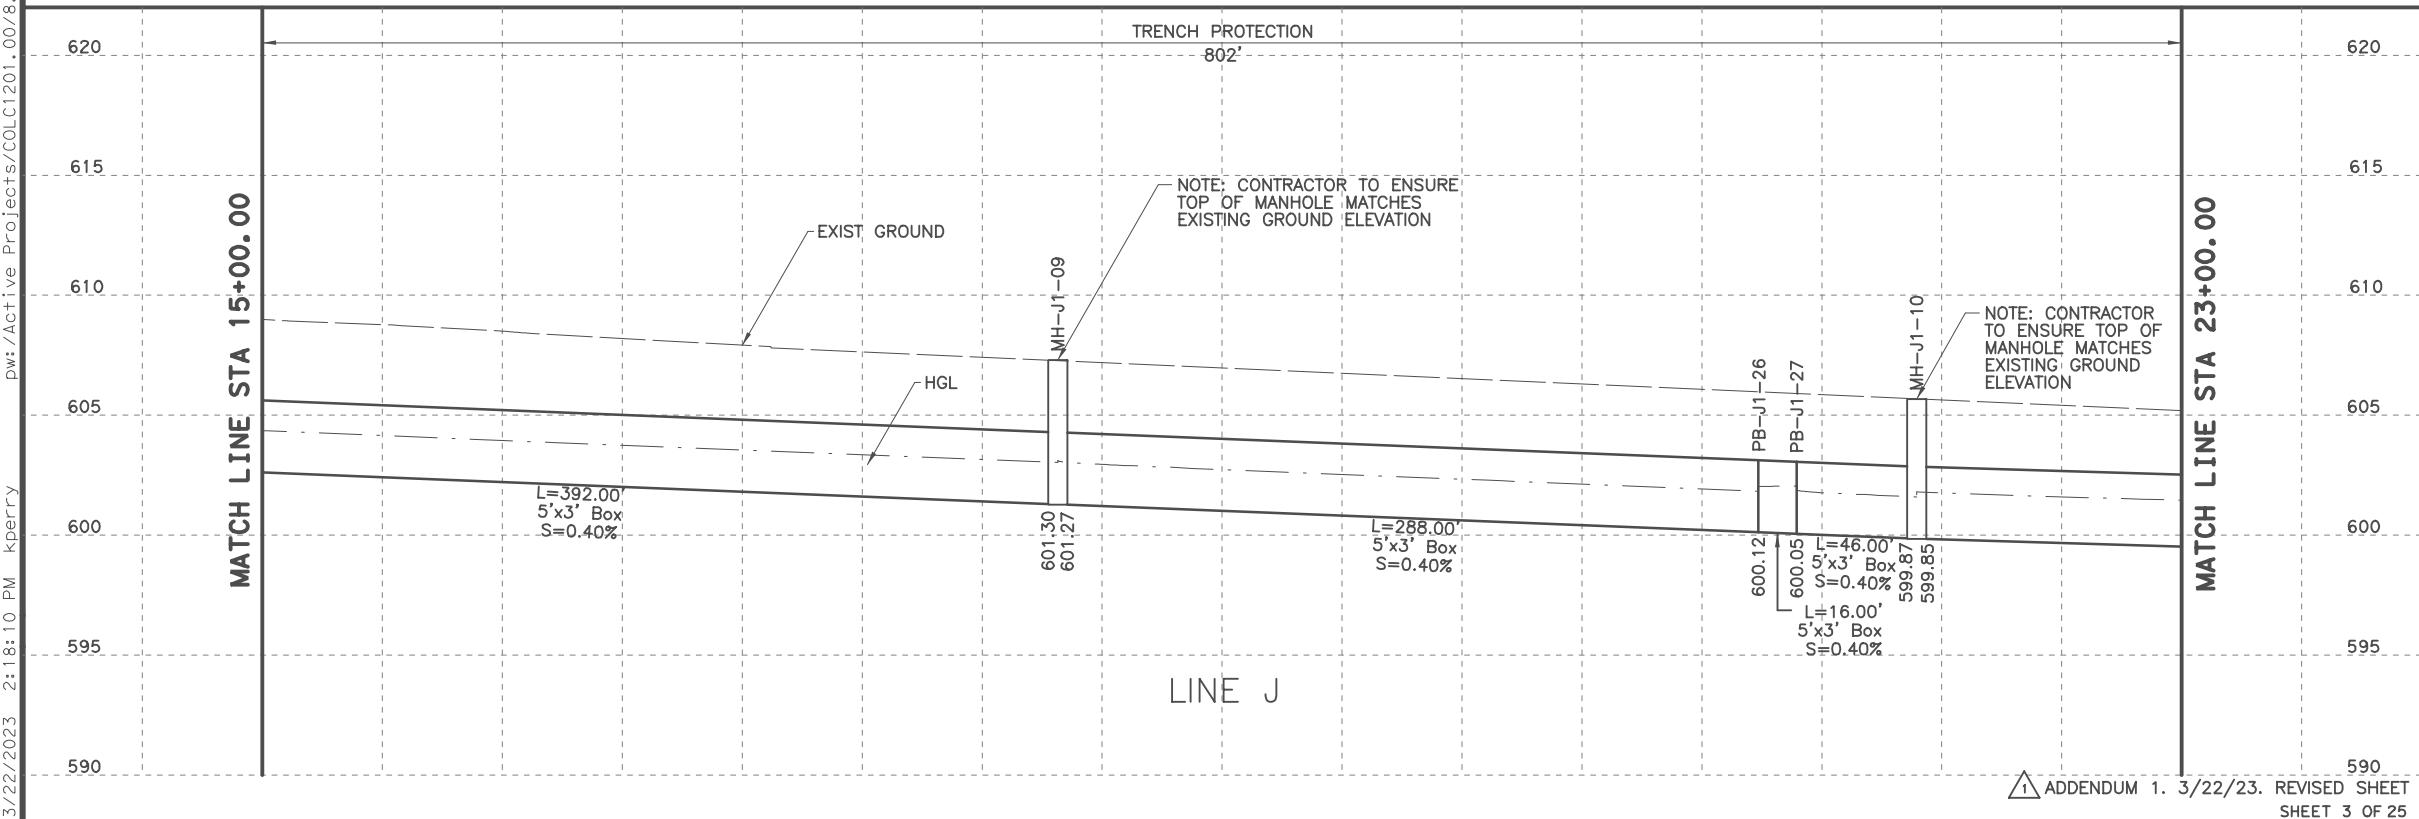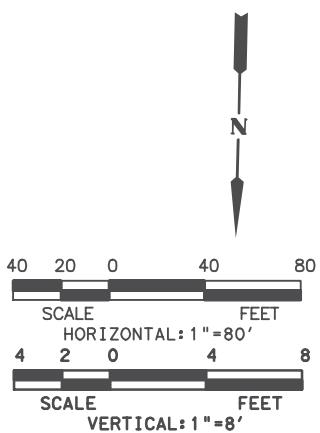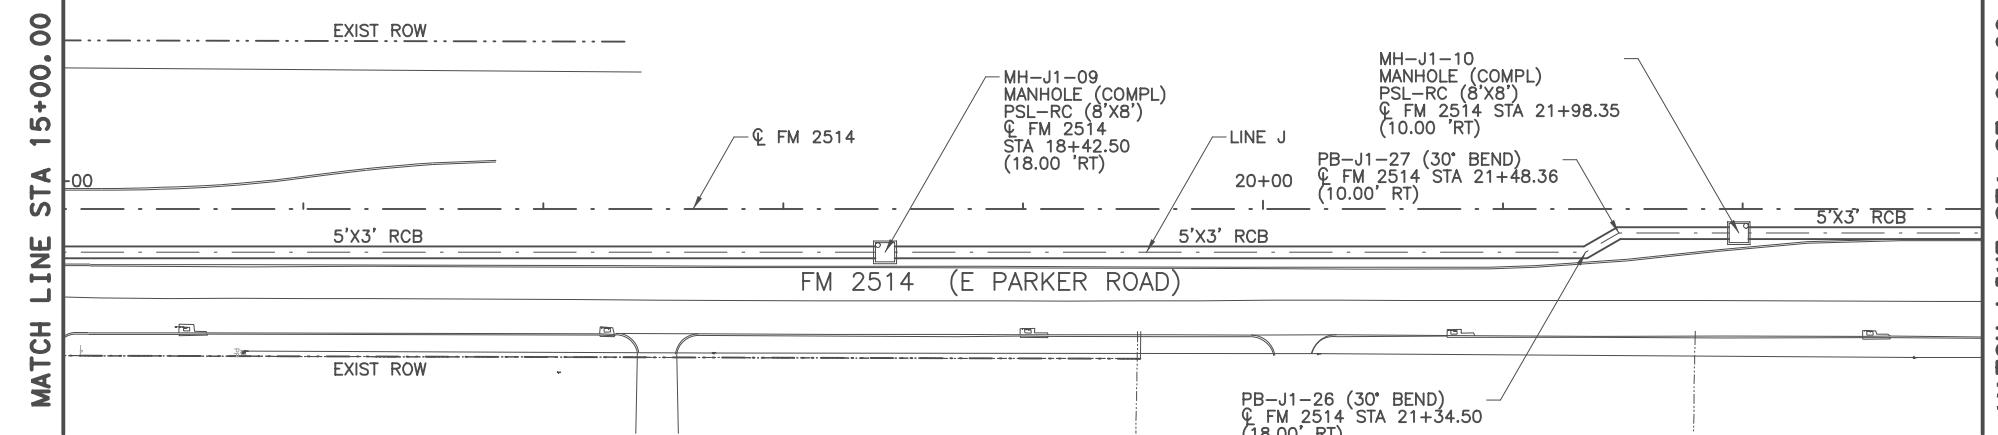

Kristen L. Perry
3/22/23





CP&Y

TEXAS REGISTERED ENGINEERING FIRM, F-1741

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FROM FM 2514 (PARKER ROAD) TO FM 2170 (MAIN STREET)
FM 2514 (PARKER ROAD)

DRAINAGE PLAN AND PROFILE
STA 15+00.00 TO STA 23+00.00

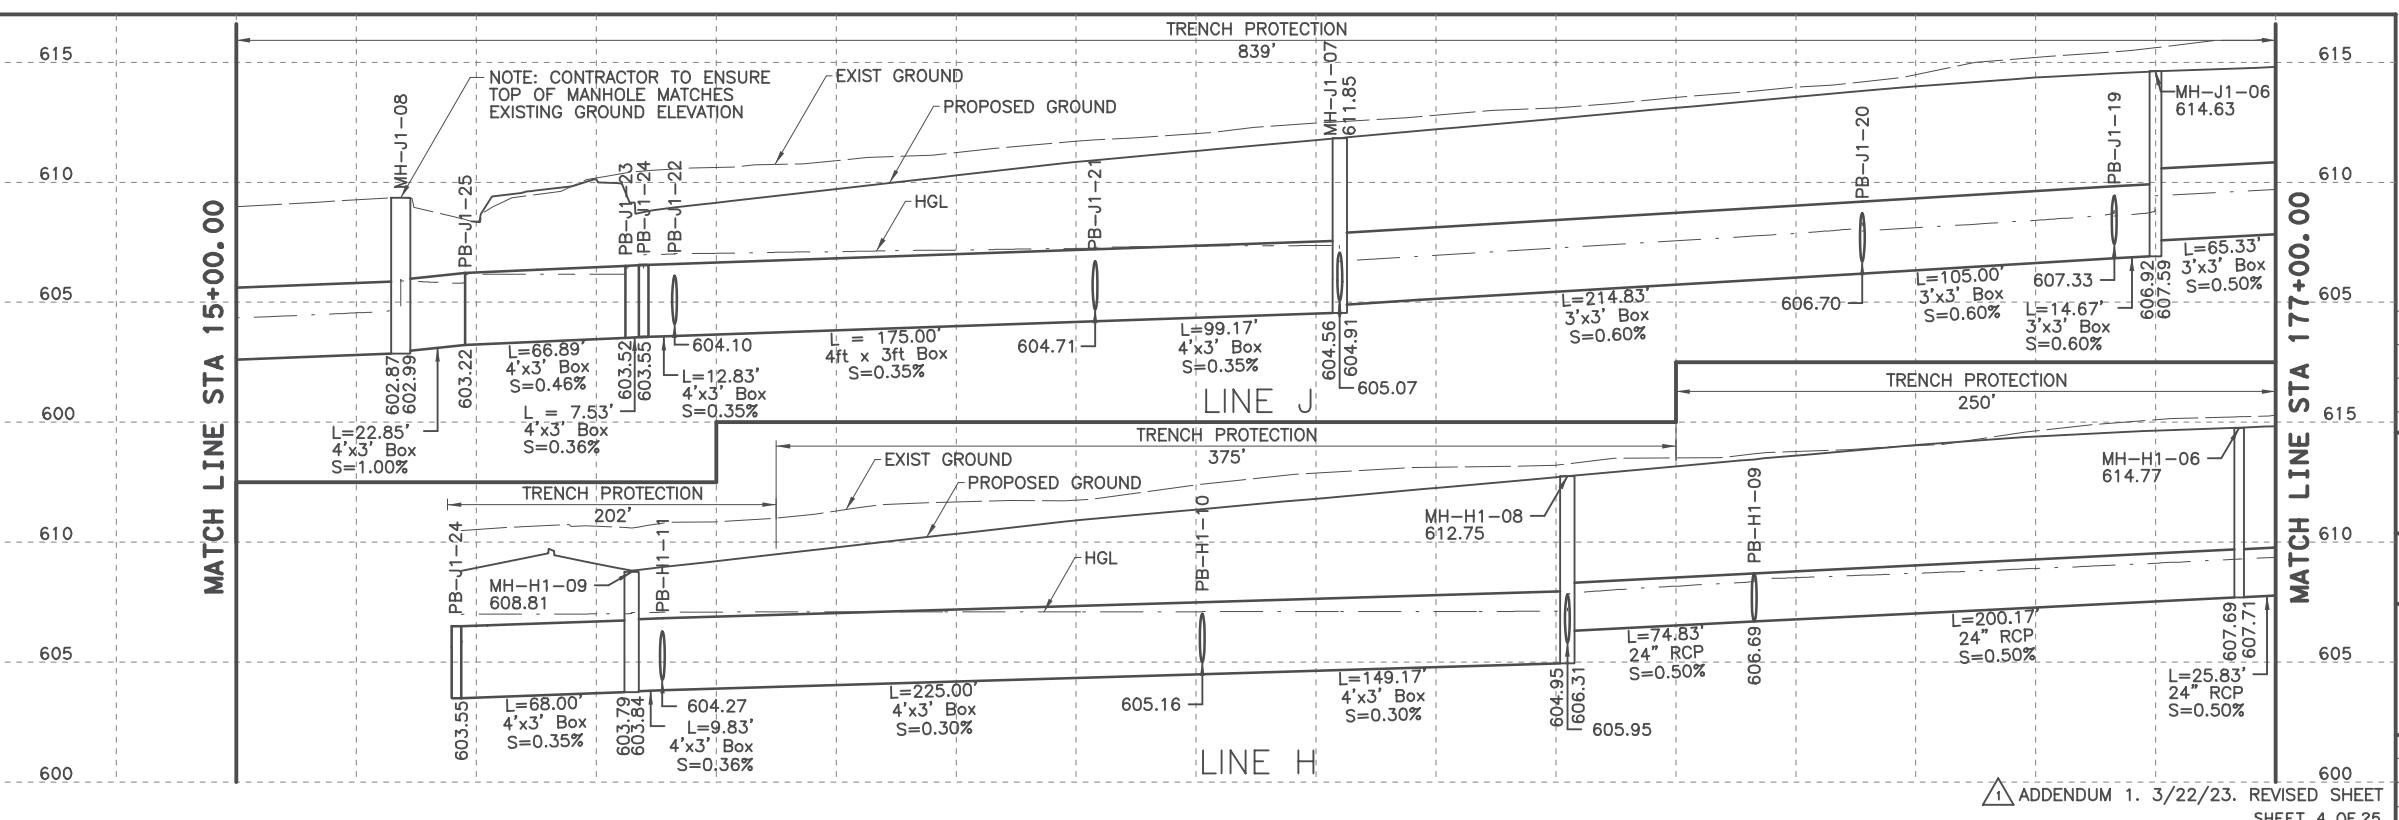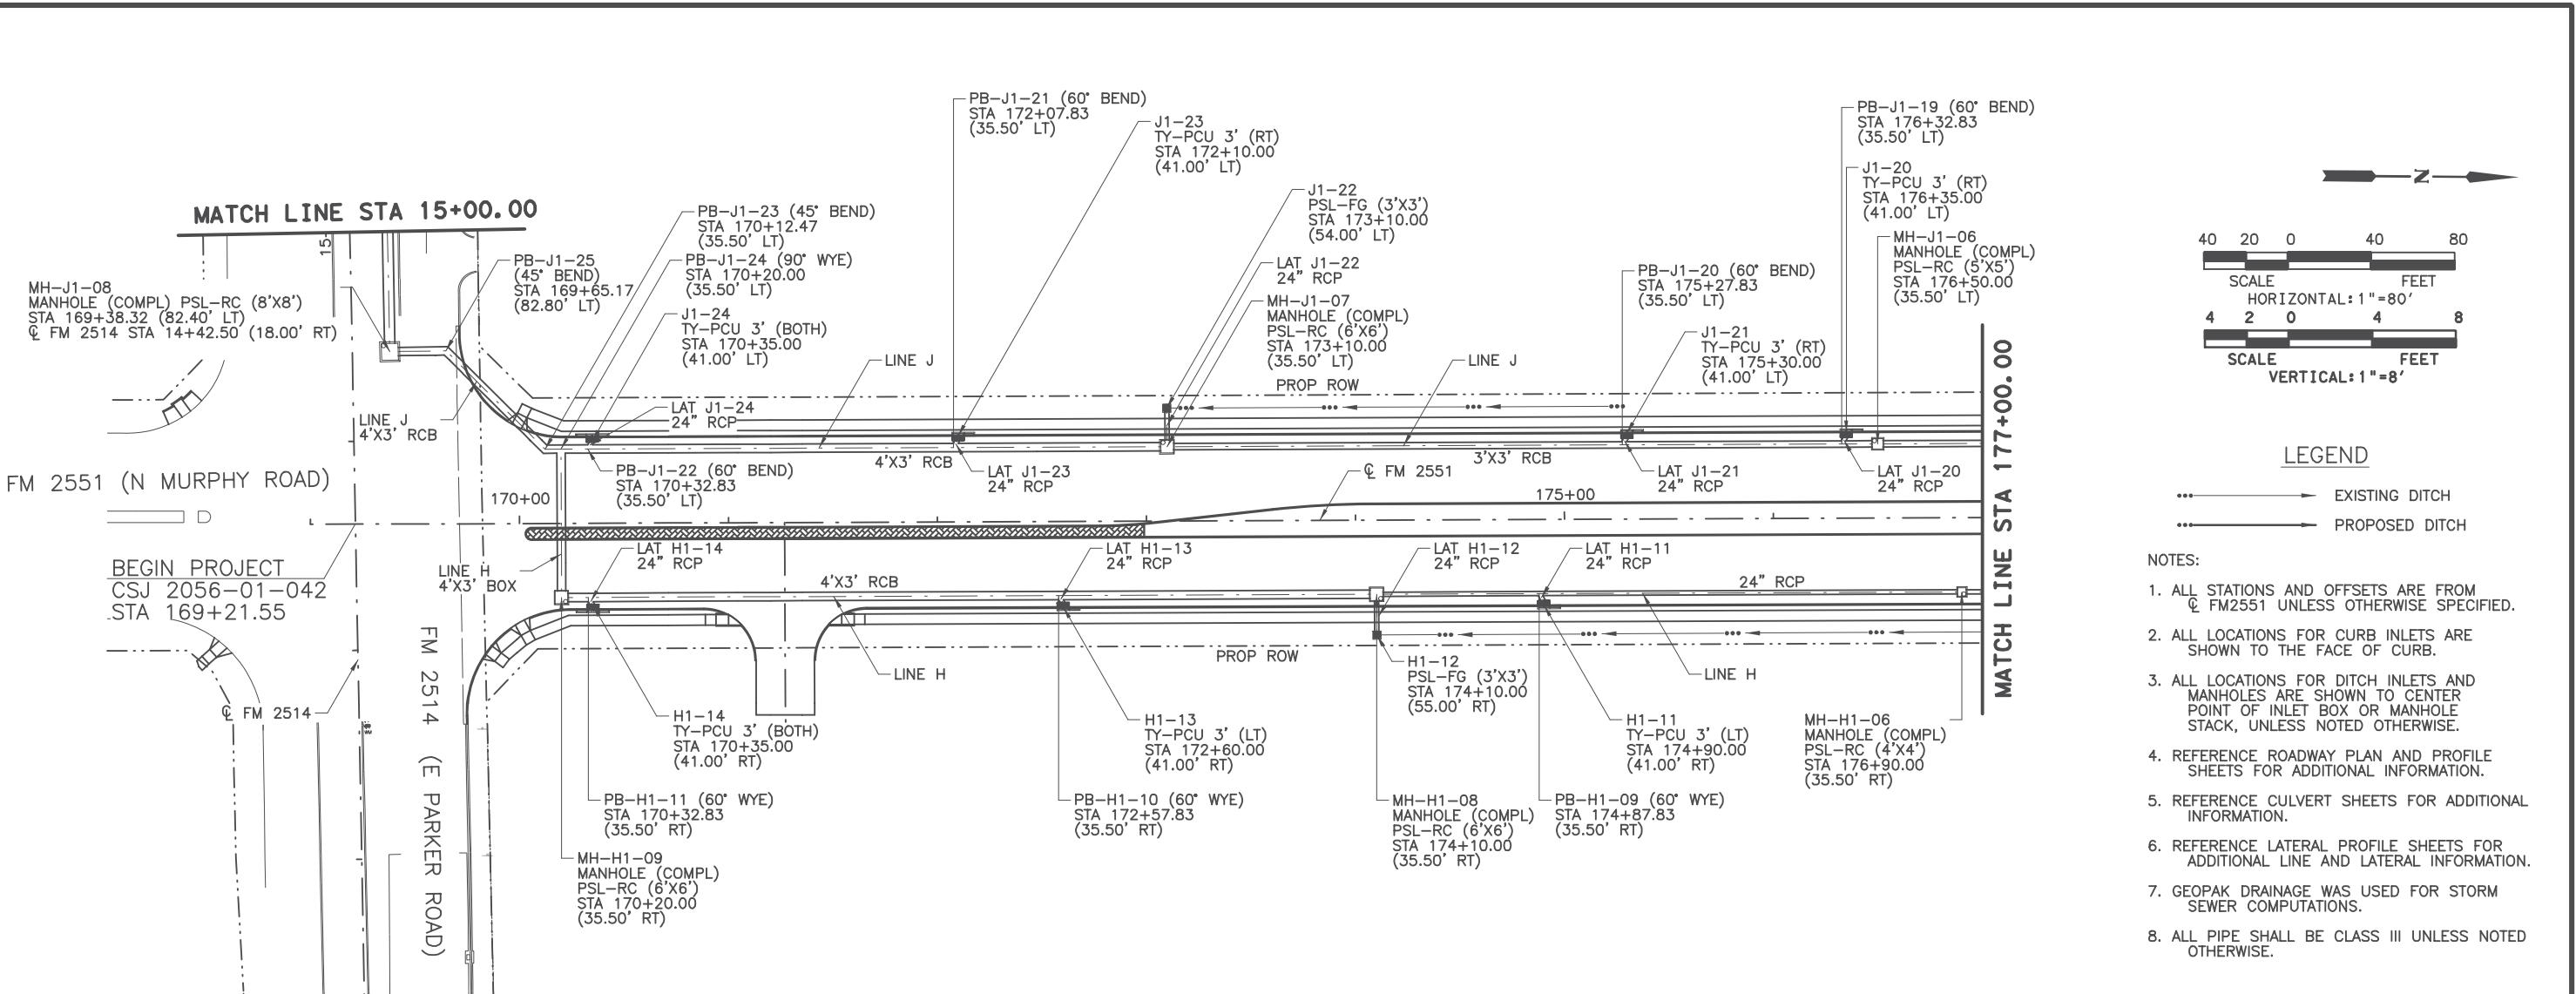



ADDENDUM 1. 3/22/23. REVISED SHEET
SHEET 4 OF 25

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FROM FM 2514 (PARKER ROAD) TO FM 2170 (MAIN STREET)
FM 2551 (MURPHY ROAD)

DRAINAGE PLAN AND PROFILE
BEGIN PROJECT TO STA 177+00.00


Designed	CPY	FED. DIV.	RD. NO.	STATE	PROJECT NO.	HIGHWAY NO.
Checked	CPY	6	TEXAS	SEE TITLE SHEET	FM 2551	
Drawn	CPY	DIST.	COUNTY	CONTROL SECTION NO.	JOB NO.	
Checked	CPY	DALLAS	COLLIN	2056	01	042

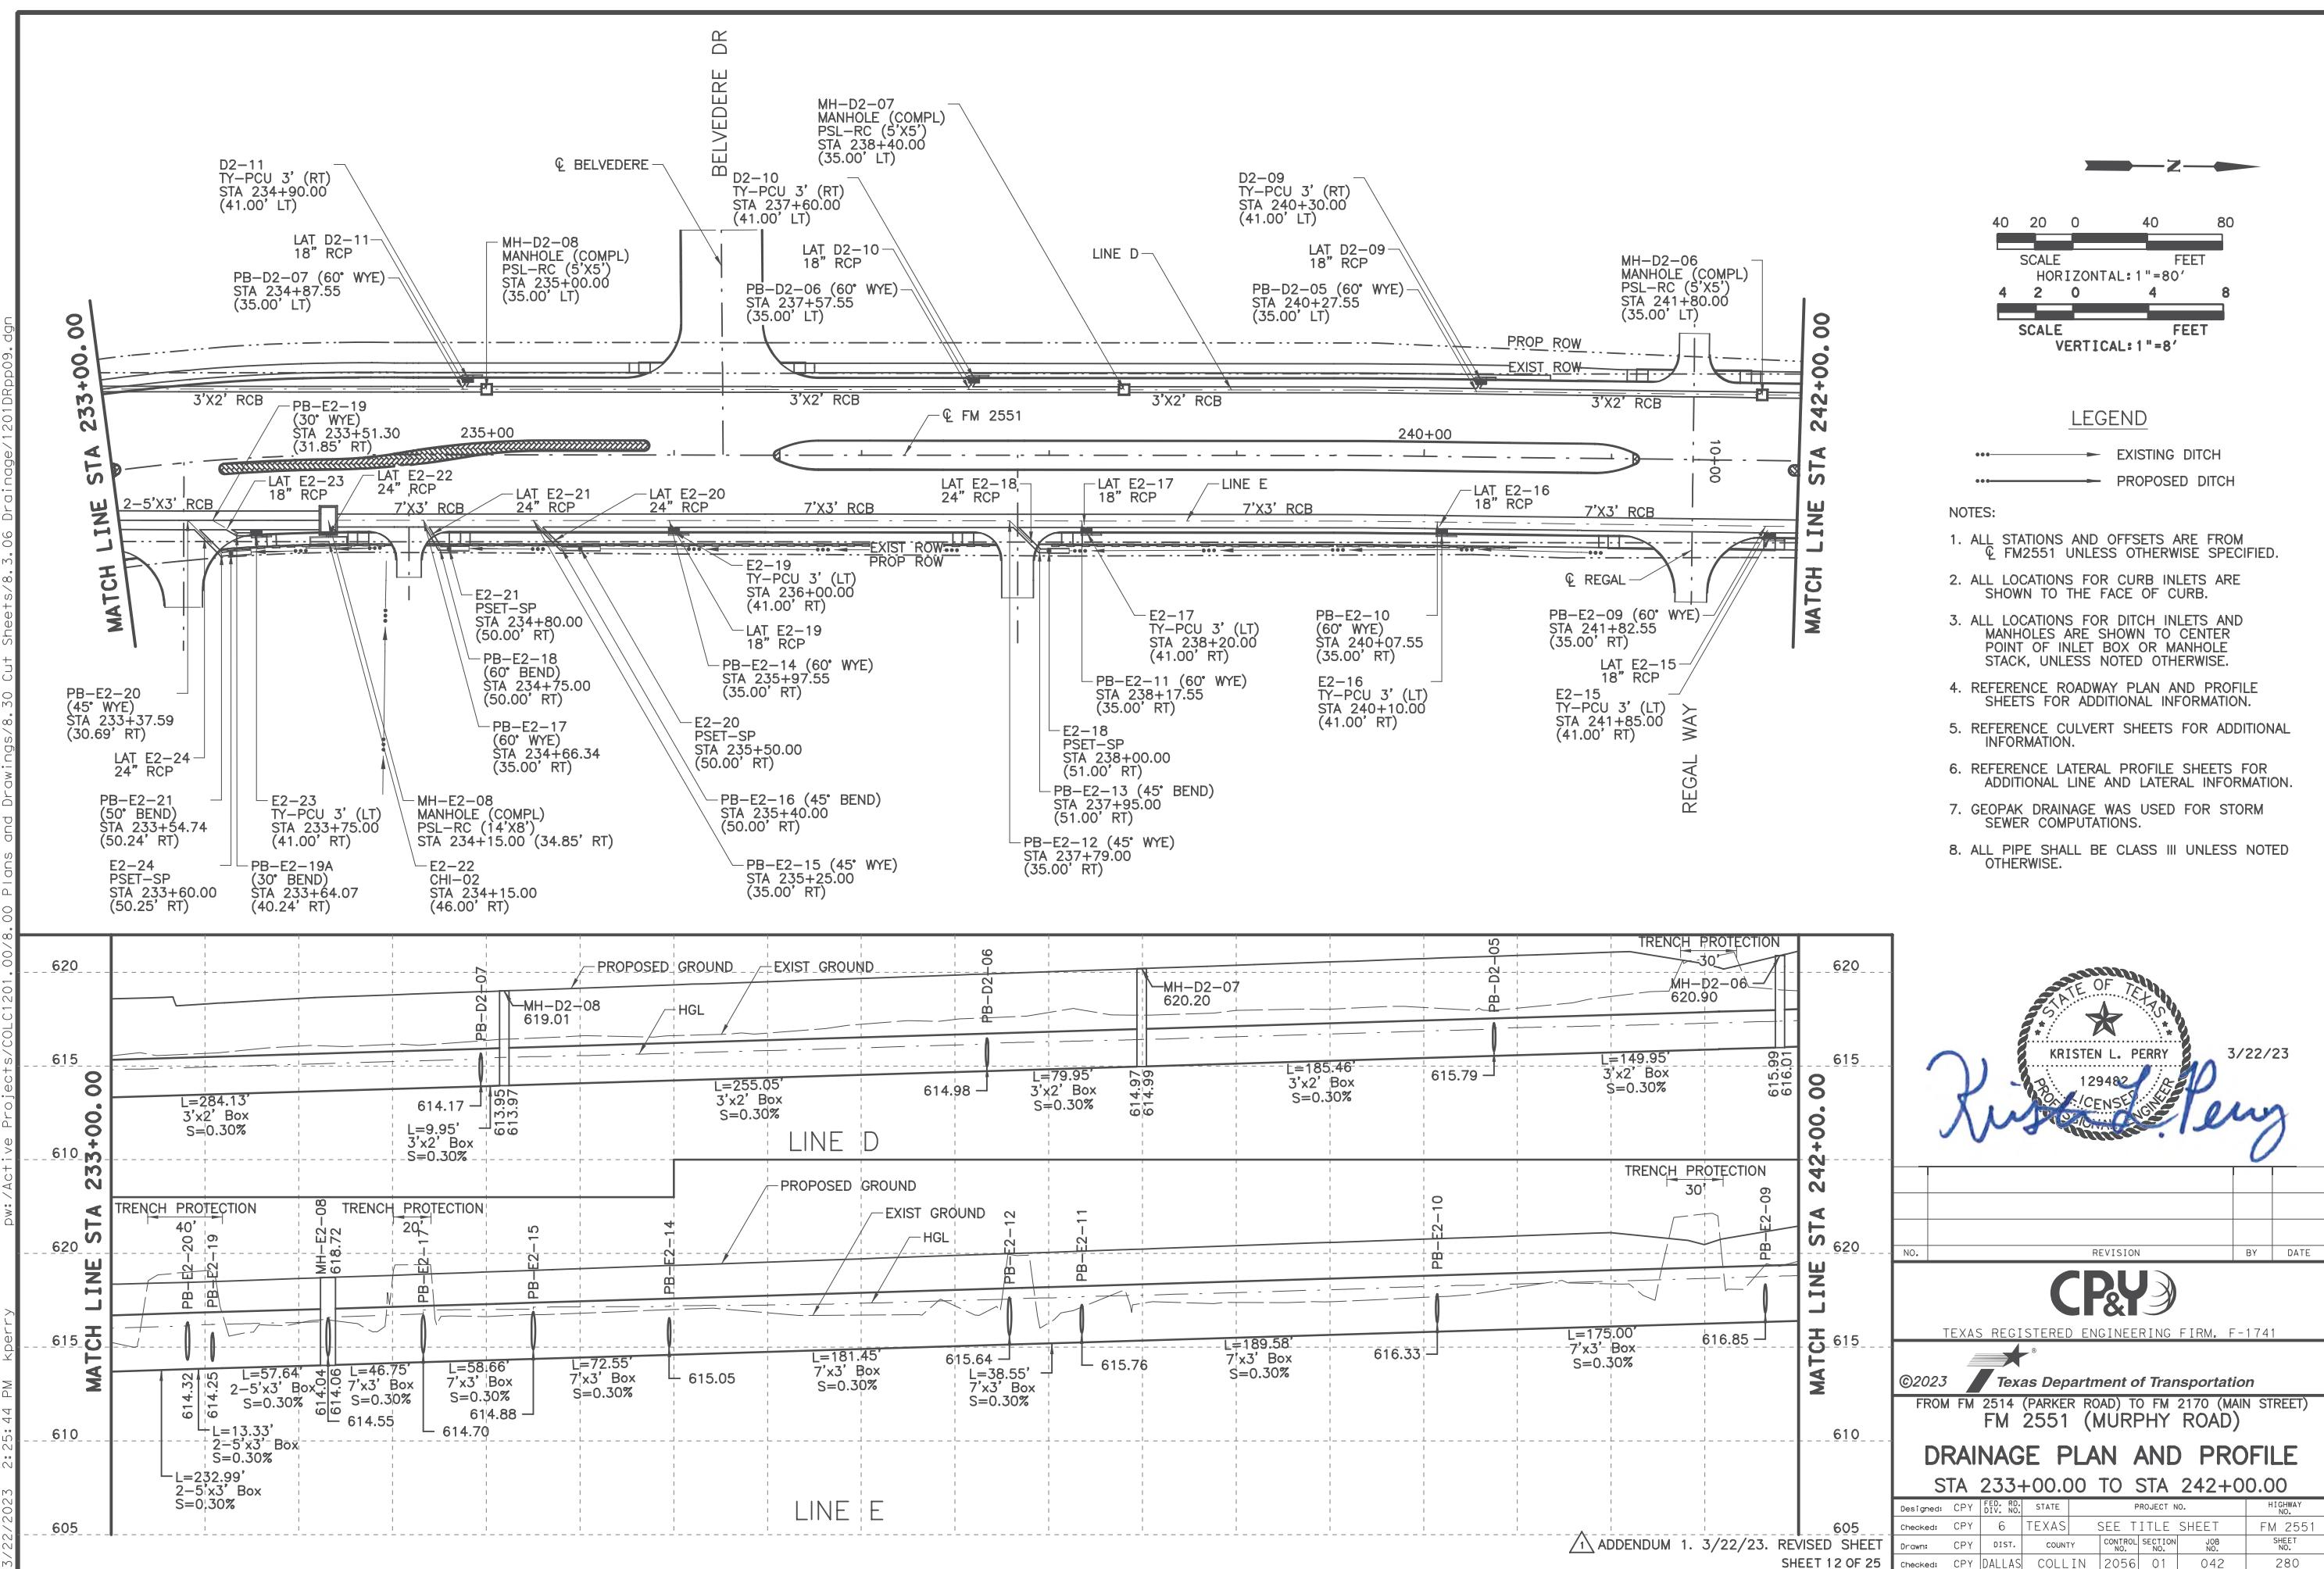

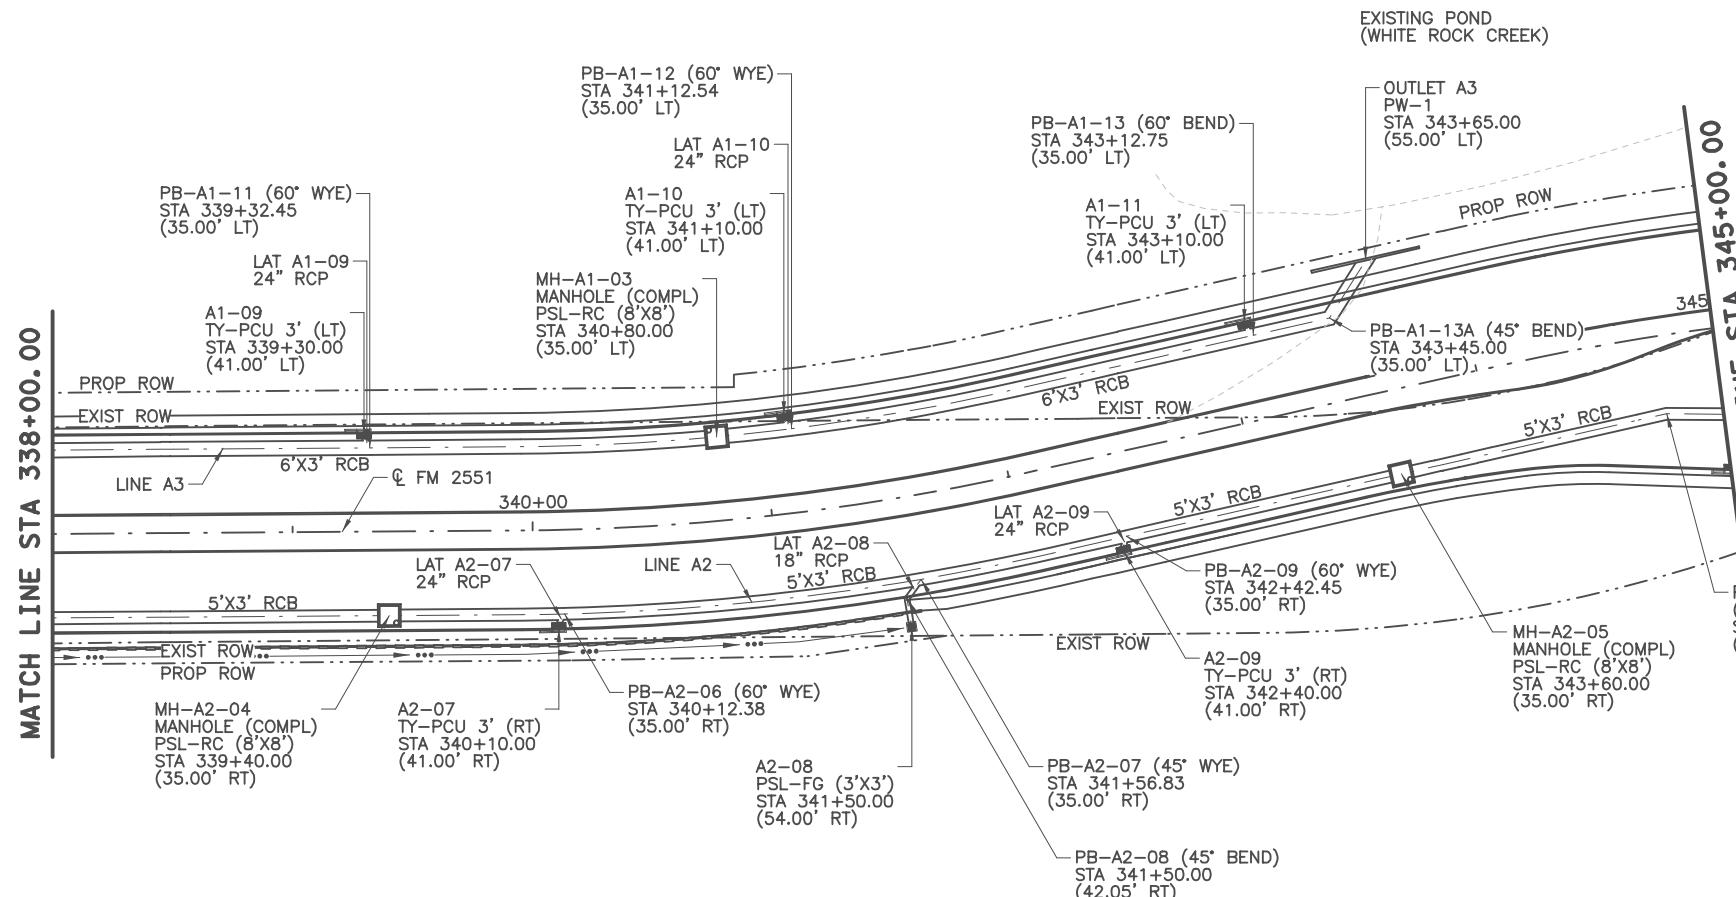

NOTES:

1. ALL STATIONS AND OFFSETS ARE FROM
 Q FM2551 UNLESS OTHERWISE SPECIFIED.
2. ALL LOCATIONS FOR CURB INLETS ARE
 SHOWN TO THE FACE OF CURB.
3. ALL LOCATIONS FOR DITCH INLETS AND
 MANHOLES ARE SHOWN TO CENTER
 POINT OF INLET BOX OR MANHOLE
 STACK, UNLESS NOTED OTHERWISE.
4. REFERENCE ROADWAY PLAN AND PROFILE
 SHEETS FOR ADDITIONAL INFORMATION.
5. REFERENCE CULVERT SHEETS FOR ADDITIONAL
 INFORMATION.
6. REFERENCE LATERAL PROFILE SHEETS FOR
 ADDITIONAL LINE AND LATERAL INFORMATION.
7. GEOPAK DRAINAGE WAS USED FOR STORM
 SEWER COMPUTATIONS.
8. ALL PIPE SHALL BE CLASS III UNLESS NOTED
 OTHERWISE.

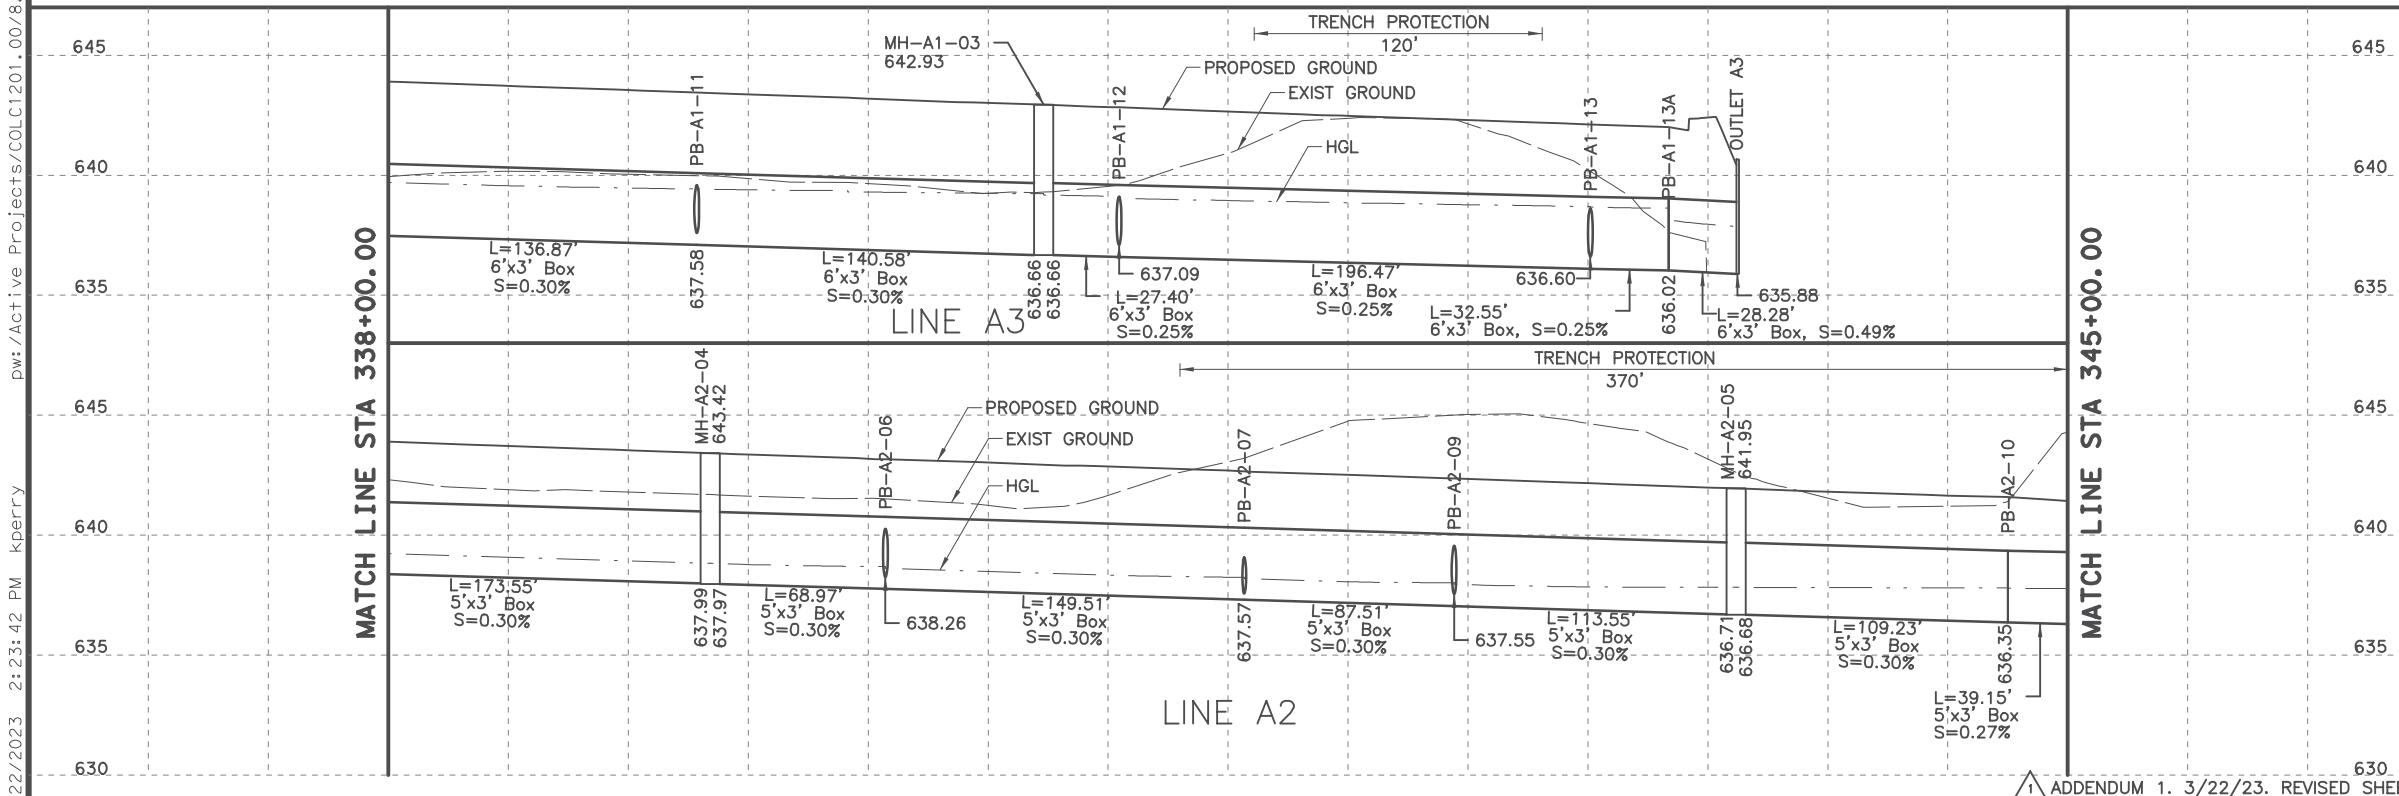


The image shows a circular official seal. At the top, it reads "STATE OF TEXAS". In the center is a five-pointed star. Below the star, the words "ENGINEERING BOARD" are written in a circular pattern. At the bottom of the seal, the number "129482" is printed. A handwritten signature "Kristen L. Perry" is overlaid across the center of the seal.



3/22/23


NO.	REVISION	BY	DATE				
 TEXAS REGISTERED ENGINEERING FIRM. F-1741							
 Texas Department of Transportation							
©2023 FROM FM 2514 (PARKER ROAD) TO FM 2170 (MAIN STREET) FM 2551 (MURPHY ROAD)							
<h1>DRAINAGE PLAN AND PROFILE</h1> <p>STA 338+00.00 TO STA 345+00.00</p>							
Designed:	CPY	FED. RD. DIV. NO.	STATE	PROJECT NO.			HIGHWAY NO.
Checked:	CPY	6	TEXAS	SEE TITLE SHEET			FM 2551
Drawn:	CPY	DIST.	COUNTY	CONTROL NO.	SECTION NO.	JOB NO.	SHEET NO.
Checked:	CPY	DALLAS	COLLIN	2056	01	042	292

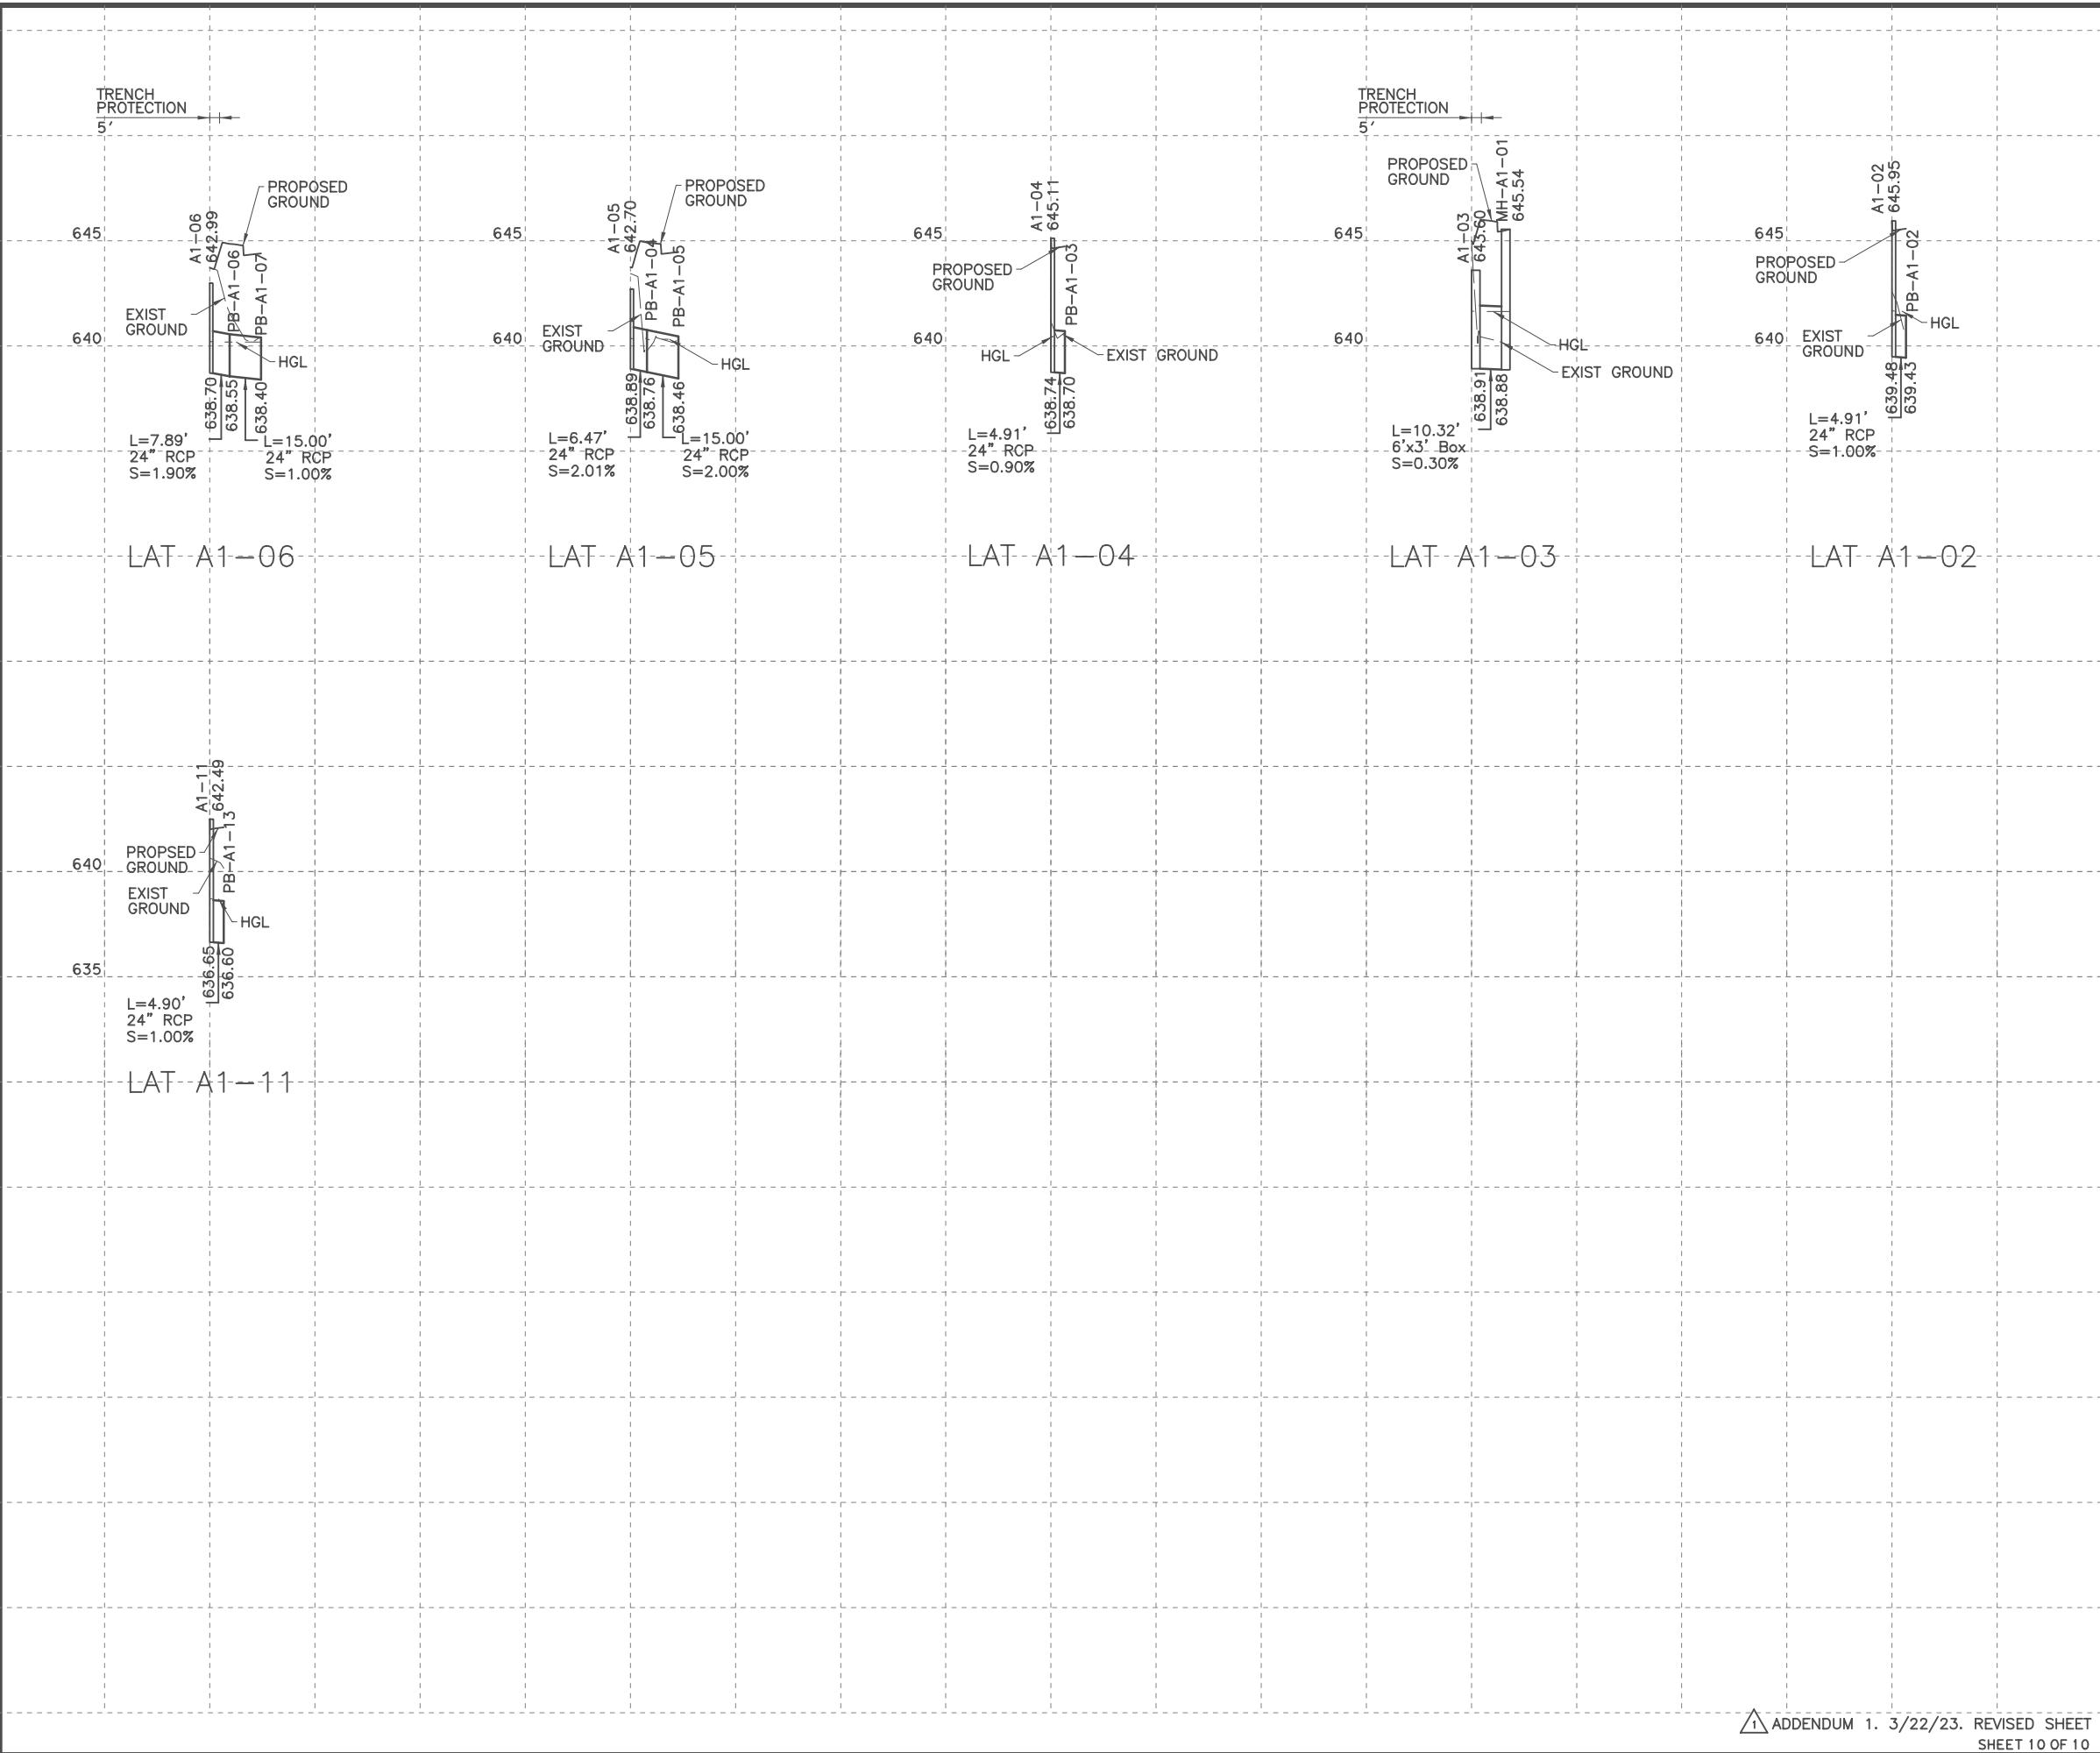

Kristen L. Perry
 3/22/23



NO.	REVISION	BY	DATE			
CP&Y <small>TEXAS REGISTERED ENGINEERING FIRM, F-1741</small>						
©2023  Texas Department of Transportation						
FROM FM 2514 (PARKER ROAD) TO FM 2170 (MAIN STREET) FM 2551 (MURPHY ROAD)						
DRAINAGE LATERAL PROFILES						
Designed:	CPY	FED. DIV.	RD. NO.	STATE	PROJECT NO.	HIGHWAY NO.
Checked:	CPY	6	TEXAS	SEE TITLE SHEET	FM 2551	
Drawn:	CPY	DIST.	COUNTY	CONTROL SECTION NO.	JOB NO.	SET NO.
Checked:	CPY	DALLAS	COLLIN	2056	01	042
						303

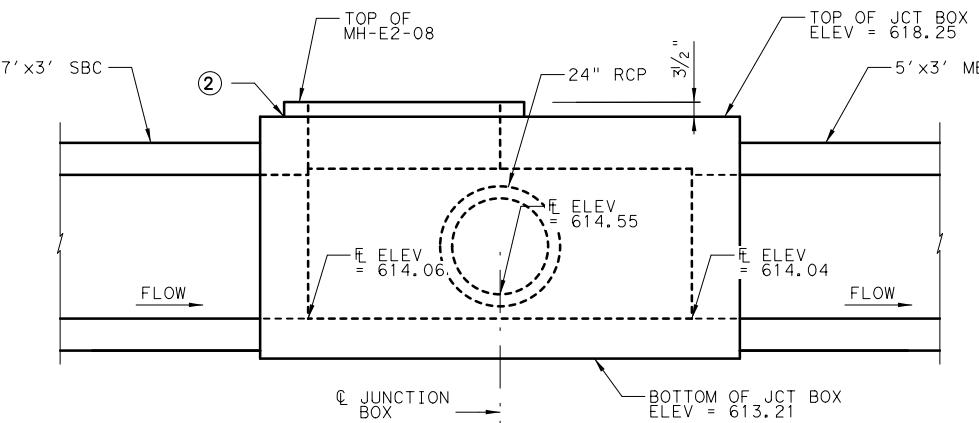

WEST ELEVATION ①


(1/4" = 1')

GENERAL NOTES:

1. DESIGNED ACCORDING TO AASHTO LRFD BRIDGE DESIGN SPECIFICATIONS, 9TH EDITION (2020).
2. CLASS "S" CONCRETE, $f'c = 4,000$ PSI.
3. ALL REINFORCING SHALL BE GRADE 60.
4. ALL EXPOSED CORNERS TO BE CHAMFERED $\frac{3}{4}$ ".
5. REINFORCING BAR DIMENSIONS ARE OUT-TO-OUT OF BAR. COVER DIMENSIONS ARE CLEAR DIMENSIONS.
6. REINFORCING BARS TO BE CUT, BENT OR ADJUSTED AS NECESSARY TO PROVIDE 2" END CLEARANCE TO CONCRETE PIPE OR RISER PENETRATIONS. REINFORCING TO BE ADJUSTED AS NECESSARY TO PROVIDE A MINIMUM OF $\frac{1}{2}$ " CLEAR COVER.
7. SEE DRAINAGE PLAN AND PROFILE SHEETS FOR ADDITIONAL INFORMATION.
8. PAYMENT FOR JUNCTION BOX TO BE PAID FOR BY THE BID ITEM 420 6143 CLASS "S" CONC (JUNCTION BOX).


① ELEVATION VIEWS ARE ILLUSTRATIVE AND FOR CONTRACTOR'S INFORMATION ONLY. SEE DRAINAGE PLAN AND PROFILE SHEETS FOR COMPLETE DRAINAGE INFORMATION.

② SEE PBGC STANDARD FOR PRECAST RISER AND RCP TO JUNCTION BOX GROUTED CONNECTION DETAILS AND NOTES.

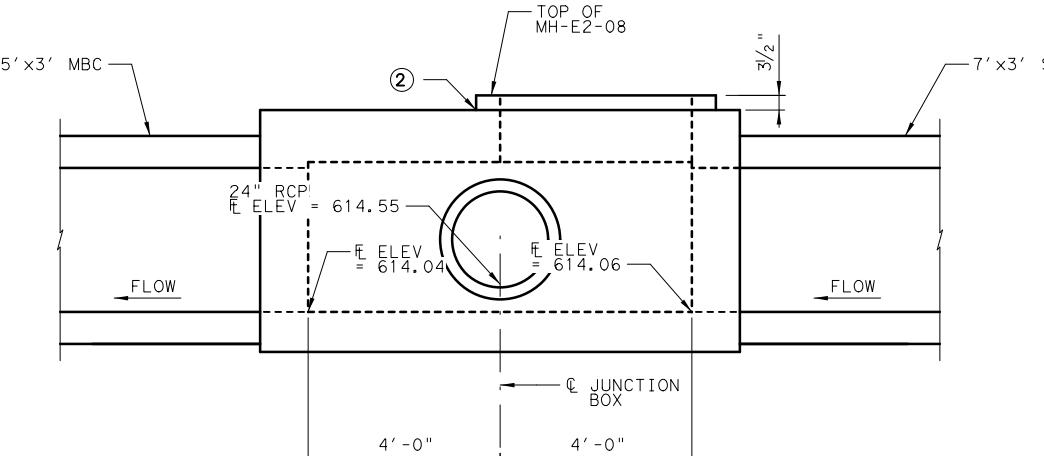

EAST ELEVATION ①

(1/4" = 1')

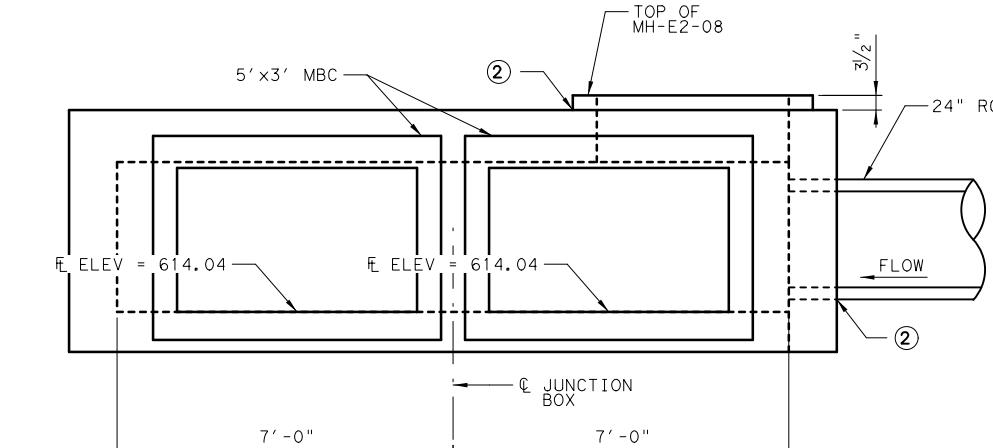

SOUTH ELEVATION ①

(1/4" = 1')


▲ ADDENDUM 1. 3/22/23. REVISED SHEET

SHEET 1 OF 9




NO.	REVISION	BY	DATE			
CP&Y						
TEXAS REGISTERED ENGINEERING FIRM, F-1741						
©2023 Texas Department of Transportation						
FROM FM 2514 (PARKER ROAD) TO FM 2170 (MAIN STREET)						
FM 2551 (MURPHY ROAD)						
MISC DETAILS JUNCTION BOXES						
14'X8' JUNCTION BOX AT STA 234+15.00						
Designed	KH	FED. DIV.	RD. NO.	STATE	PROJECT NO.	HIGHWAY NO.
Checked	CPY	6	TEXAS	SEE TITLE SHEET	FM 2551	
Drawn		DIST.	COUNTY	CONTROL SECTION NO.	JOB NO.	SHEET NO.
Checked		DALLAS	COLLIN	2056	01	042
305A						

CONTRACTOR TO BREAK BACK 5'X3' AND
7'X3 MBC 2'-0", CLEAN REINFORCING
AND EXTEND BARS L1 TO PROVIDE
1'-10" MIN LAP WITH
MBC REINFORCING (TYP)

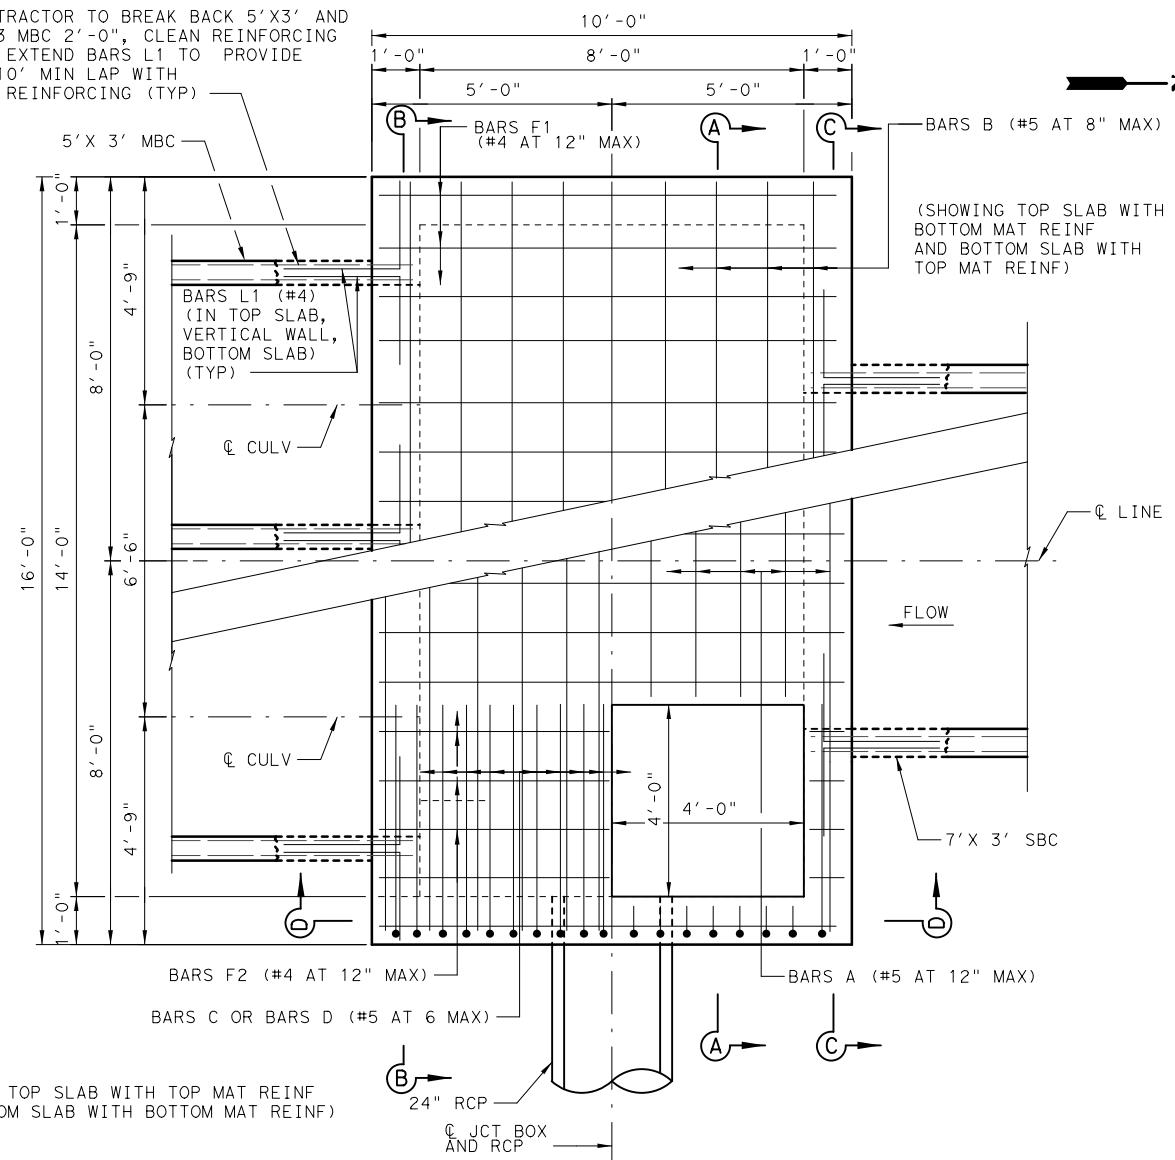

PLAN
(SHOWING TOP AND BOTTOM SLAB)

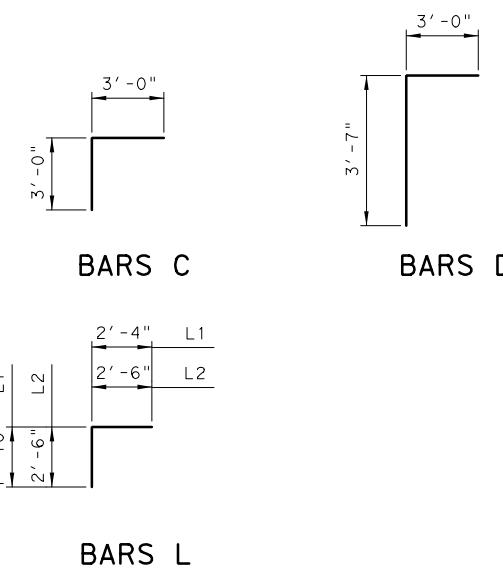


BARS C

BARS □


The diagram shows a stepped foundation with two levels. The top level has a width of 2'-4" and is labeled L1. The bottom level has a width of 2'-6" and is labeled L2. A vertical dimension line indicates a height of 1'-10" between the two levels.

BARS L

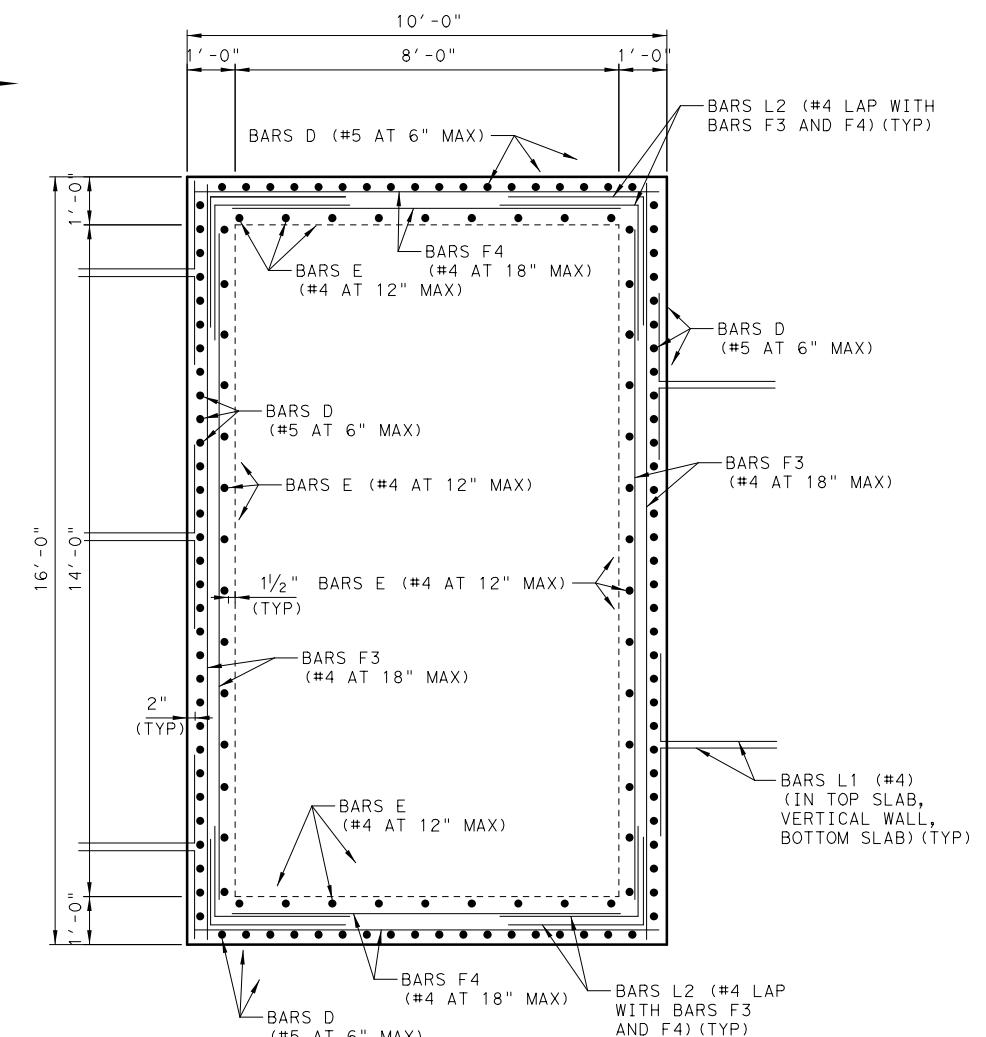

PLA

(SHOWING VERTICAL JUNCTION BOX WALLS,
CONCRETE CULVERTS NOT SHOWN FOR CLARITY)

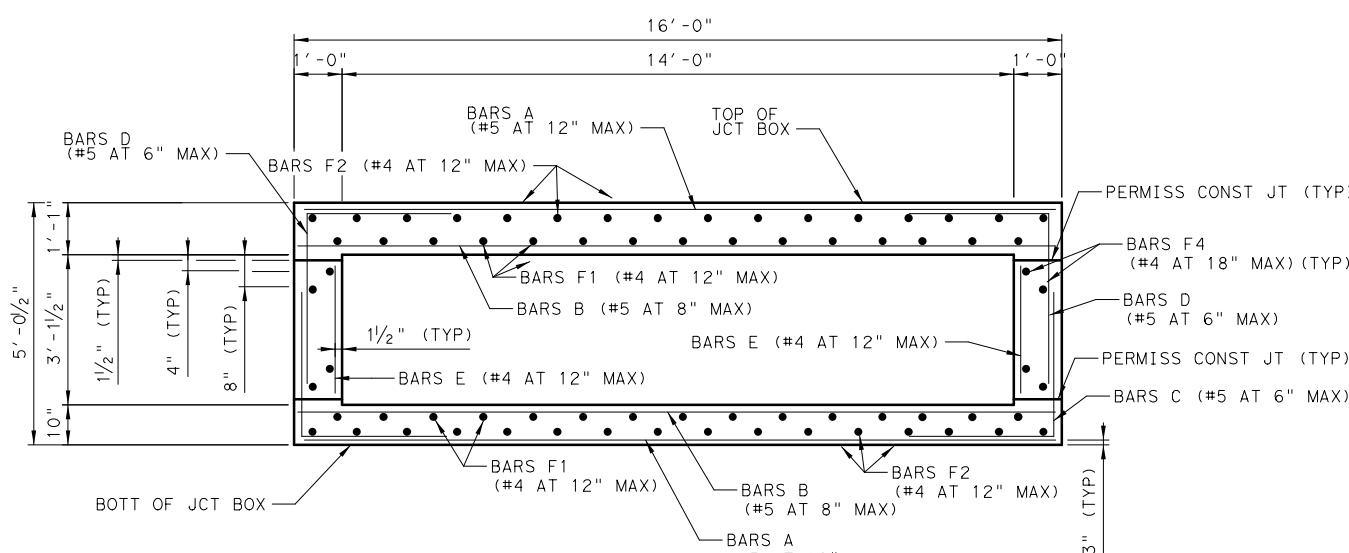

SECTION A-A
(CULVERTS AND PIPE NOT SHOWN FOR CLARITY)

ADDENDUM 1, 3/22/23, REVISED SHEET

SHEET 2 OF 9

TABLE OF ESTIMATED QUANTITIES
 14X8 JUNCTION BOX
 STA 234+15.00

BAR	NO.	SIZE	LENGTH	WEIGHT
A	30	#5	15' - 8"	49
B	32	#5	15' - 8"	52
C	98	#5	6' - 0"	61
D	98	#5	6' - 9"	69
E	46	#4	2' - 7"	7
F1	30	#4	9' - 8"	19
F2	32	#4	9' - 8"	20
F3	8	#4	15' - 8"	8
F4	8	#4	9' - 8"	5
L1	36	#4	4' - 2"	100
L2	16	#4	5' - 0"	5
V	4	#4	4' - 0"	1
REINFORCING STEEL			LB	3,094
CLASS "S" CONC (MISC)			CY	14.



03/22/2023

1 NO.	REVISED REVISION	KH S/N	03/22/23 DATE

CPU & I


TEXAS REGISTERED ENGINEERING FIRM # E-1344

TEXAS REGISTERED ENGINEERING FIRM, F-1741
 Texas Department of Transportation
FM 2514 (PARKER ROAD) TO FM 2170 (MAIN STREET)

MISC DETAILS JUNCTION BOXES


4'X8' JUNCTION BOX AT STA 234+15.00

JUNCTION BOX AT STA 234+13.00						
Tigned:	KH	FED. RD. DIV.	RD. NO.	STATE	PROJECT NO.	HIGHWAY NO.
checked	CPY	6	TEXAS	SEE TITLE SHEET		FM 2551
own:		DIST.	COUNTY	CONTROL NO.	SECTION NO.	JOB NO.
checked		DALLAS	COLLIN	2056	01	042
						305B

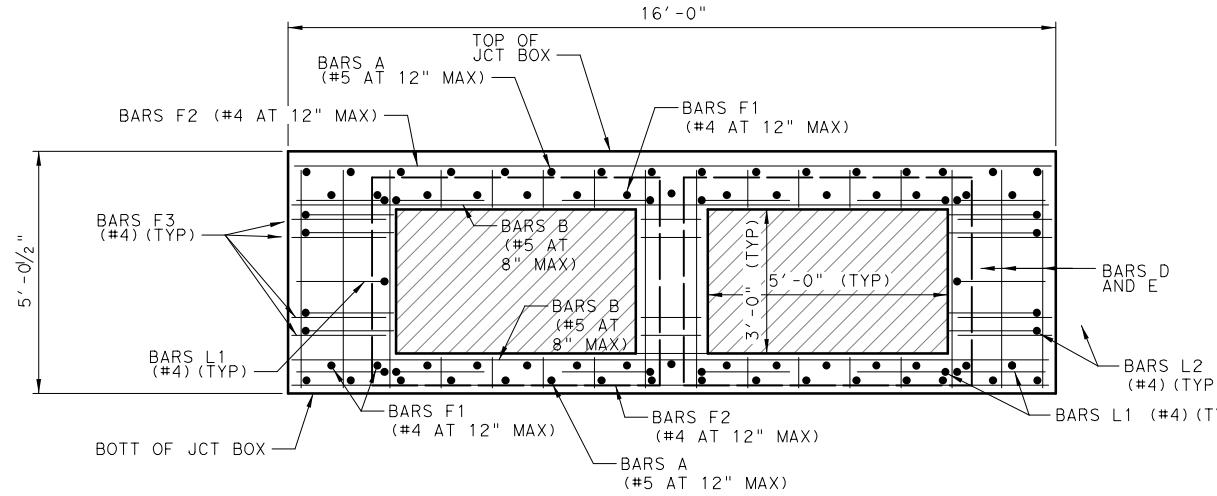


SECTION B-B

(SHOWING 2~5'X3' OPENINGS,
FIELD CUT BARS AS NECESSARY.)

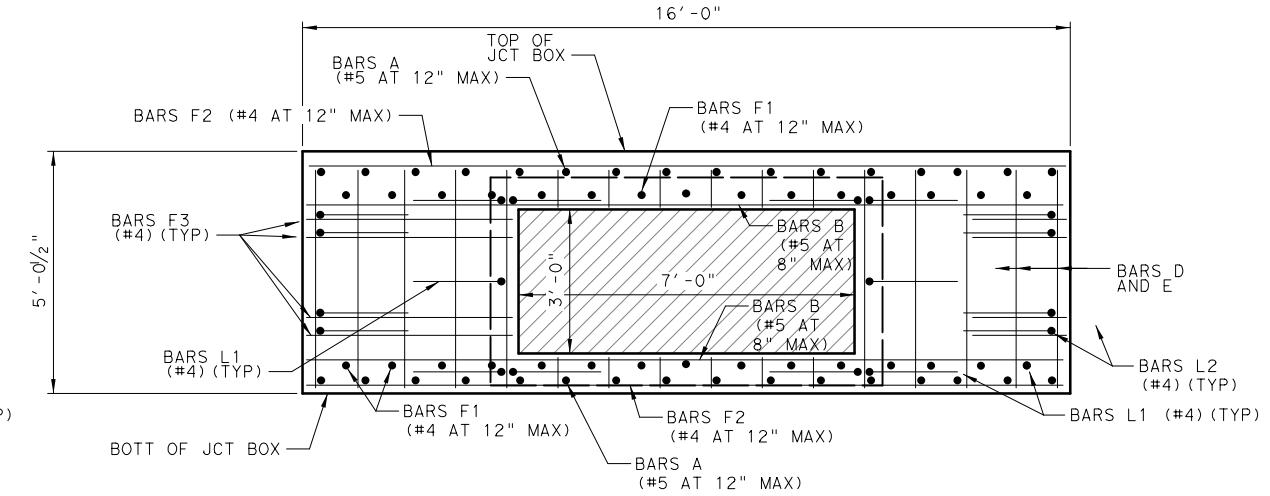

SECTION C-C

(SHOWING 7'X3' OPENING,
FIELD CUT BARS AS NECESSARY.)

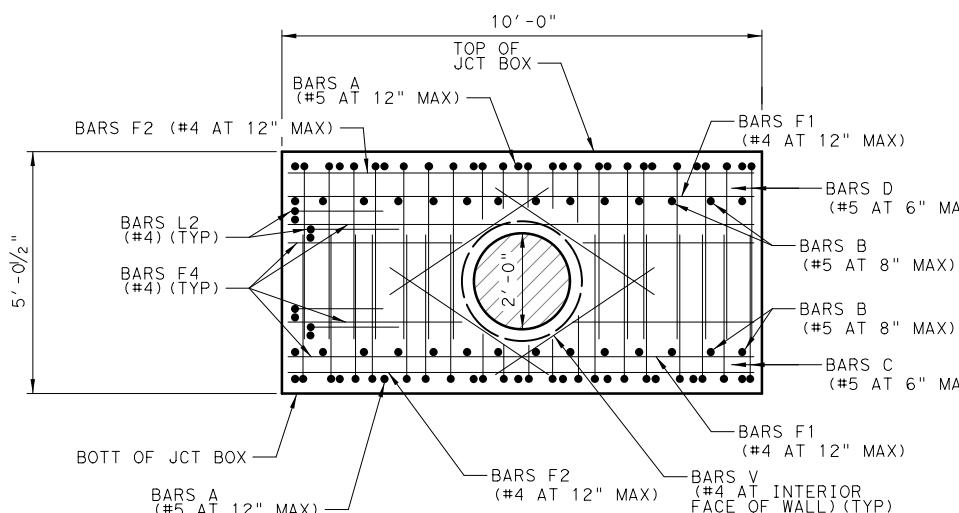

SECTION D-D

(SHOWING 24" RCP OPENING. FIELD CUT BARS AS NECESSARY.)



NO.	REVISION	BY	DATE
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TEXAS REGISTERED ENGINEERING FIRM, F-1741

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FROM FM 2514 (PARKER ROAD) TO FM 2170 (MAIN STREET)
FM 2551 (MURPHY ROAD)


MISC DETAILS JUNCTION BOXES

14'X8' JUNCTION BOX AT STA 234+15.00

ADDENDUM 1. 3/22/23. ADDED SHEET

SHEET 3 OF 9

Designed	KH	FED. DIV.	RD. NO.	STATE	PROJECT NO.	HIGHWAY NO.
Checked:	CPY	6	TEXAS	SEE TITLE SHEET	FM 2551	
Drawn:		DIST.	COUNTY	CONTROL SECTION NO.	JOB NO.	SHEET NO.
Checked:	DALLAS	COLLIN	2056	01	042	305C

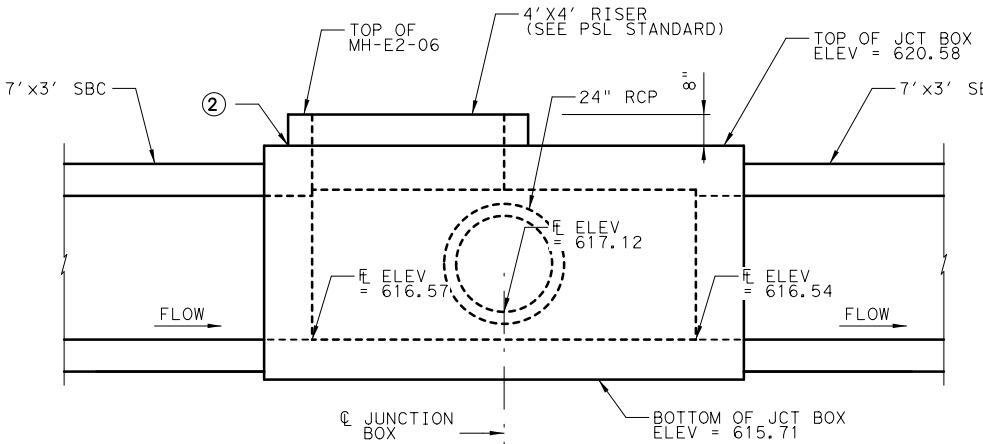

WEST ELEVATION ①


(1/4" = 1')

GENERAL NOTES:

1. DESIGNED ACCORDING TO AASHTO LRFD BRIDGE DESIGN SPECIFICATIONS, 9TH EDITION (2020).
2. CLASS "S" CONCRETE, f'c = 4,000 PSI.
3. ALL REINFORCING SHALL BE GRADE 60.
4. ALL EXPOSED CORNERS TO BE CHAMFERED $\frac{3}{4}$ ".
5. REINFORCING BAR DIMENSIONS ARE OUT-TO-OUT OF BAR. COVER DIMENSIONS ARE CLEAR DIMENSIONS.
6. REINFORCING BARS TO BE CUT, BENT OR ADJUSTED AS NECESSARY TO PROVIDE 2" END CLEARANCE TO CONCRETE PIPE OR RISER PENETRATIONS. REINFORCING TO BE ADJUSTED AS NECESSARY TO PROVIDE A MINIMUM OF $\frac{1}{2}$ " CLEAR COVER.
7. SEE DRAINAGE PLAN AND PROFILE SHEETS FOR ADDITIONAL INFORMATION.
8. PAYMENT FOR JUNCTION BOX TO BE PAID FOR BY THE BID ITEM 420 6143 CLASS "S" CONC (JUNCTION BOX).


① ELEVATION VIEWS ARE ILLUSTRATIVE AND FOR CONTRACTOR'S INFORMATION ONLY. SEE DRAINAGE PLAN AND PROFILE SHEETS FOR COMPLETE DRAINAGE INFORMATION.

② SEE PBGC STANDARD FOR PRECAST RISER AND RCP TO JUNCTION BOX GROUTED CONNECTION DETAILS AND NOTES.

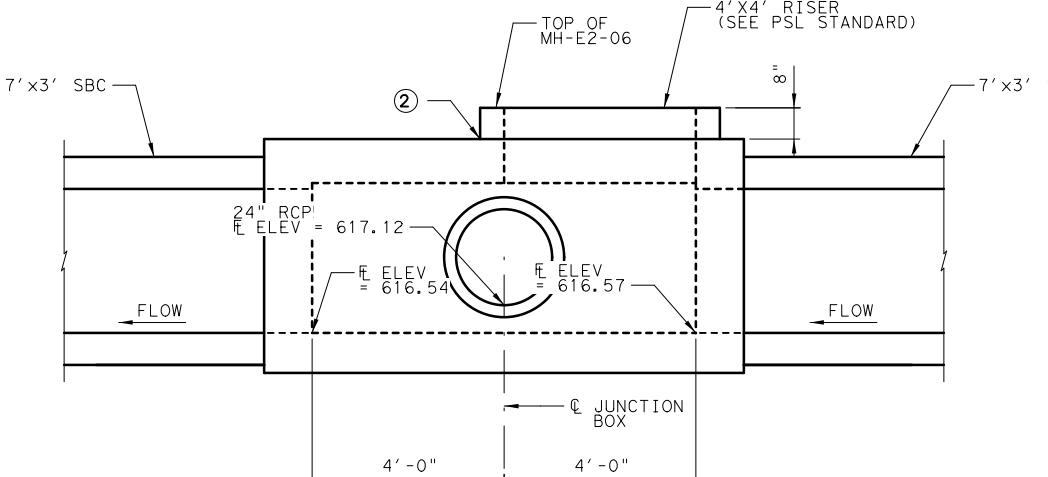

EAST ELEVATION ①

(1/4" = 1')

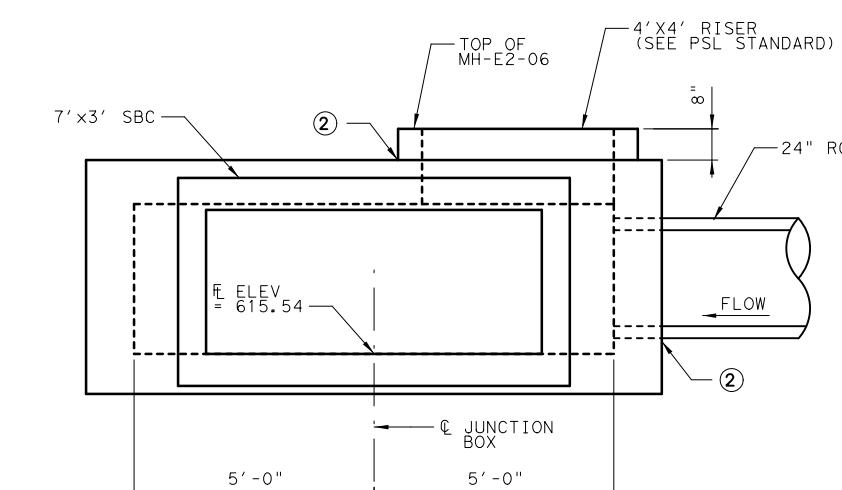

SOUTH ELEVATION ①

(1/4" = 1')

▲ ADDENDUM 1. 3/22/23. REVISED SHEET

Designed	KH	FED. DIV.	RD. NO.	STATE	PROJECT NO.	HIGHWAY NO.
Checked	CPY	6	TEXAS	SEE TITLE SHEET	FM 2551	
Drawn		DIST.	COUNTY	CONTROL SECTION NO.	JOB NO.	SHEET NO.
Checked	DALLAS	COLLIN	2056	01	042	305D

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FROM FM 2514 (PARKER ROAD) TO FM 2170 (MAIN STREET)
FM 2551 (MURPHY ROAD)

MISC DETAILS JUNCTION BOXES
10'X8' JUNCTION BOX AT STA 242+49.00



CP&Y

TEXAS REGISTERED ENGINEERING FIRM, F-1741

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FROM FM 2514 (PARKER ROAD) TO FM 2170 (MAIN STREET)
FM 2551 (MURPHY ROAD)

MISC DETAILS JUNCTION BOXES

10'X8' JUNCTION BOX AT STA 242+49.00




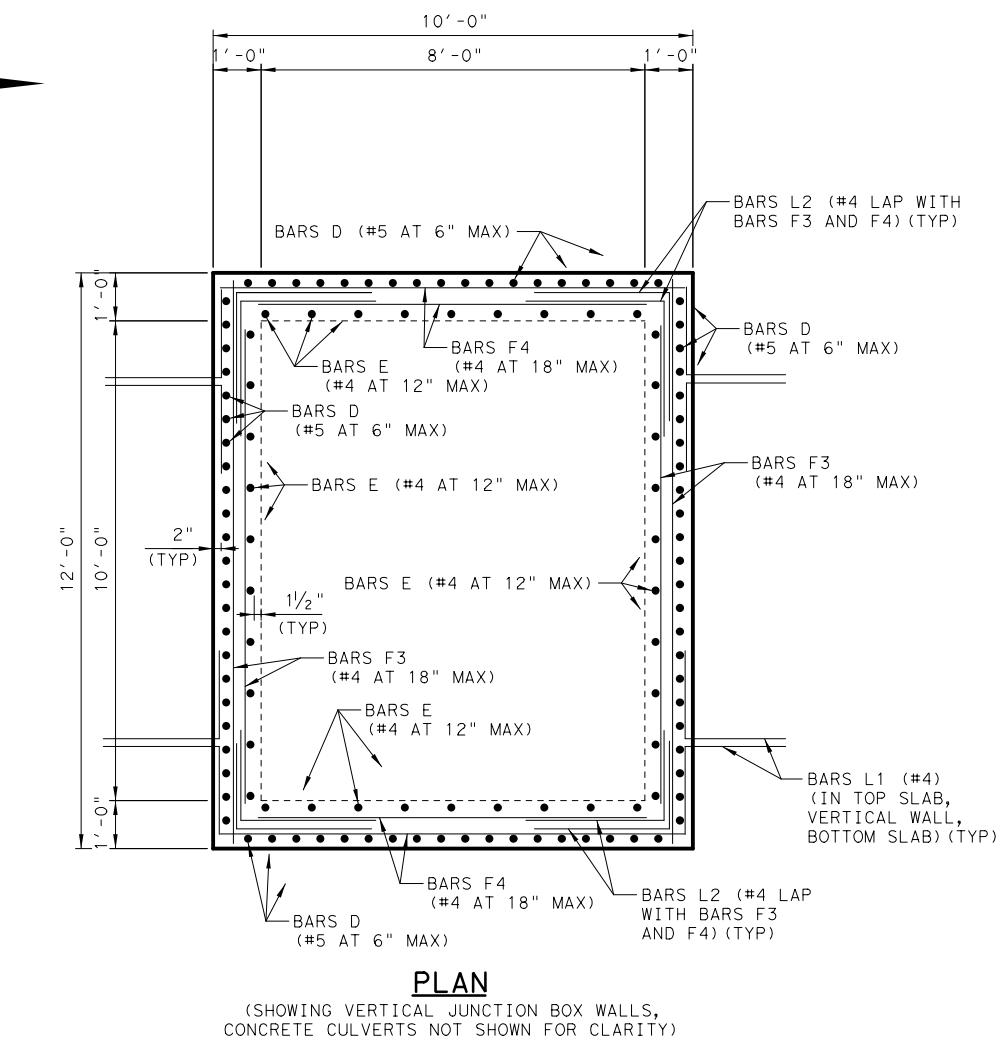


TABLE OF ESTIMATED QUANTITIES 10X8 JUNCTION BOX STA 242+49.00				
BAR	NO.	SIZE	LENGTH	WEIGHT
A	22	#5	11'- 8"	268
B	28	#5	11'- 8"	341
C	82	#5	6'- 0"	513
D	82	#5	6'- 7"	563
E	38	#4	2'- 7"	66
F1	22	#4	9'- 8"	142
F2	24	#4	9'- 8"	155
F3	8	#4	11'- 8"	62
F4	8	#4	9'- 8"	52
L1	24	#4	4'- 2"	67
L2	16	#4	5'- 0"	53
V	4	#4	4'- 0"	11
REINFORCING STEEL				LB
CLASS "S" CONC (MISC)				CY
2,293				10.1

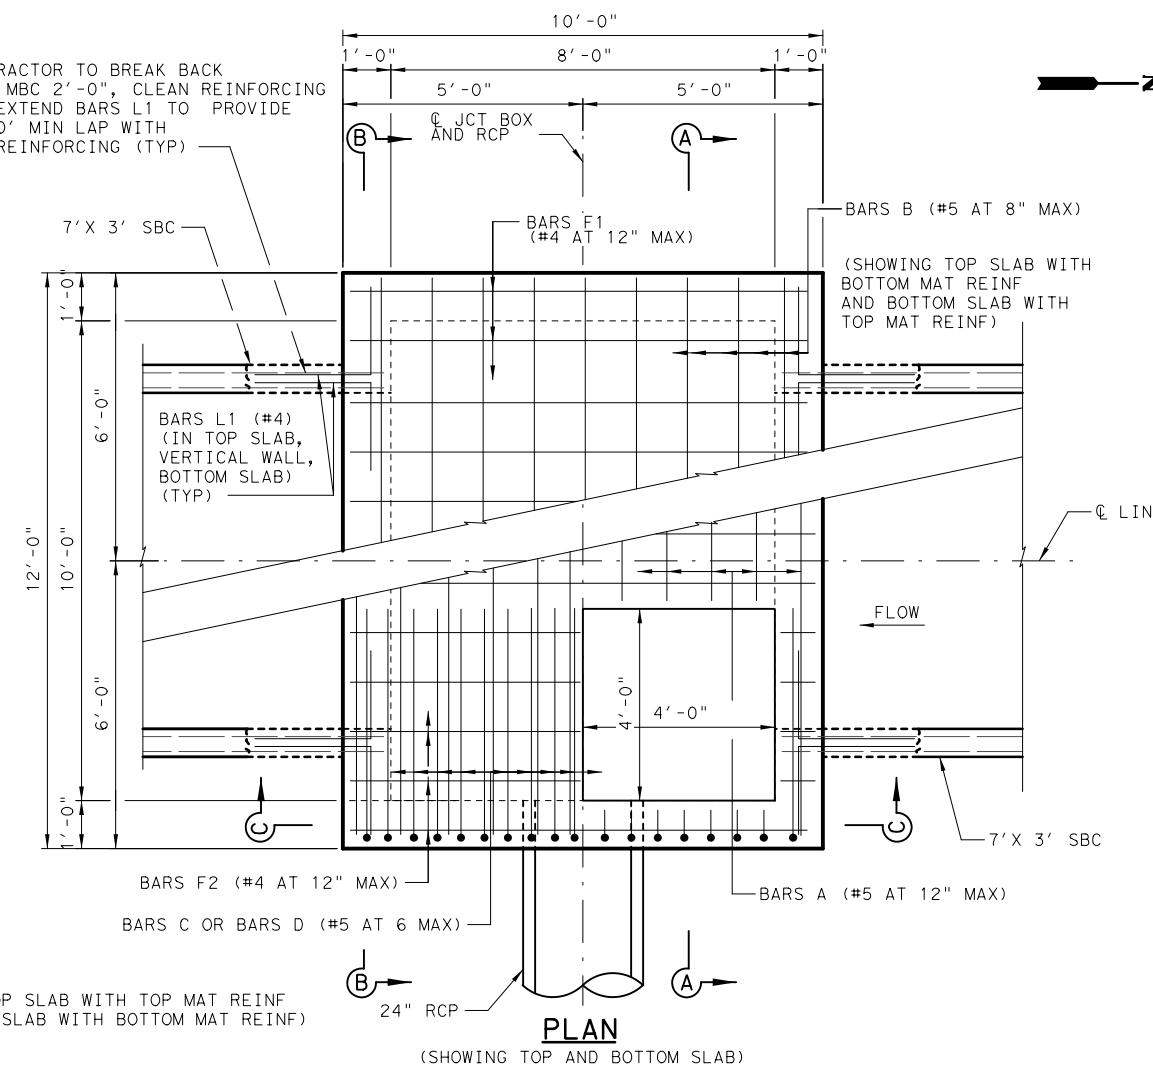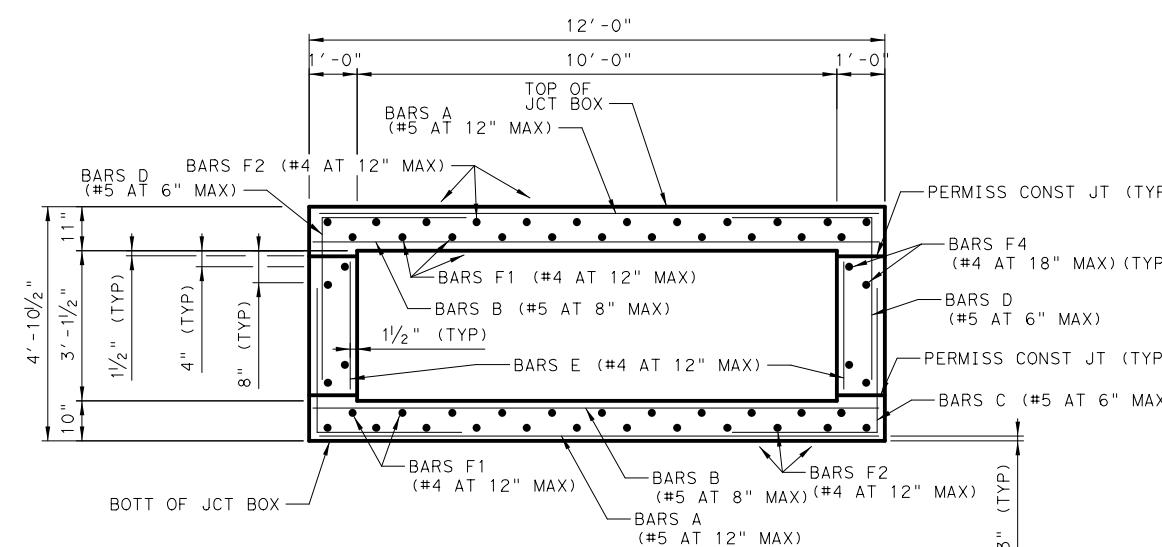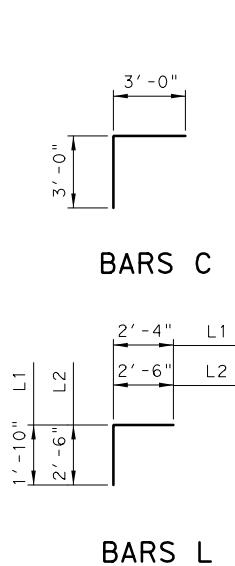

ADDENDUM 1. 3/22/23. REVISED SHEET


03/22/2023

KELLY HO
 112947
 PROFESSIONAL ENGINEER
 TEXAS REGISTERED ENGINEERING FIRM, F-1741
CP&Y
 TEXAS REGISTERED ENGINEERING FIRM, F-1741
 ©2023 Texas Department of Transportation
 FROM FM 2514 (PARKER ROAD) TO FM 2170 (MAIN STREET)
 FM 2551 (MURPHY ROAD)

MISC DETAILS JUNCTION BOXES
10'X8' JUNCTION BOX AT STA 242+49.00


Designed	KH	FED. DIV.	RD. NO.	STATE	PROJECT NO.	HIGHWAY NO.
Checked	CPY	6	TEXAS	SEE TITLE SHEET	FM 2551	
Drawn	DIST.	COUNTY	CONTROL SECTION NO.	JOB NO.	SHEET NO.	
Checked	DALLAS	COLLIN	2056	01	042	305E

SHEET 5 OF 9

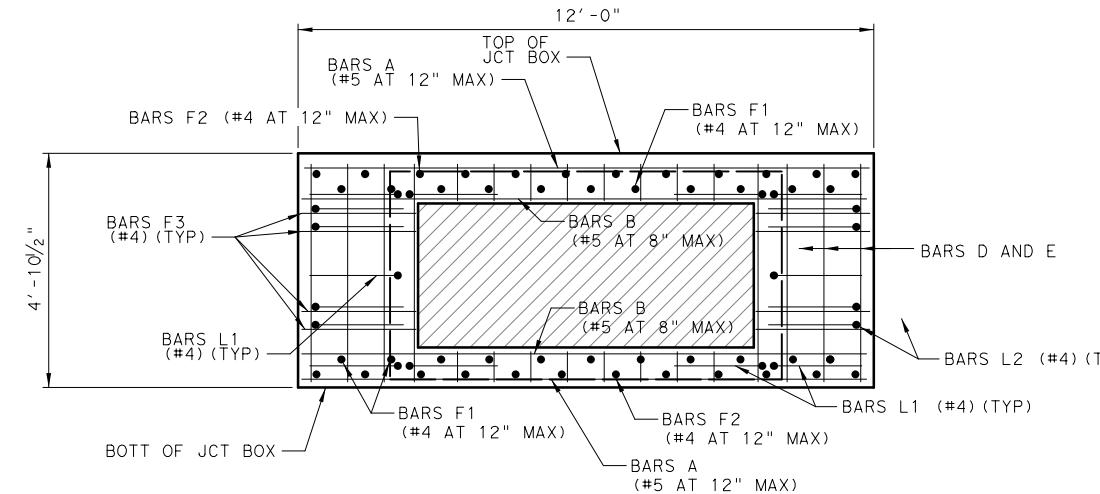

SECTION B-B

(SHOWING 7'X3' OPENING,
FIELD CUT BARS AS NECESSARY.)

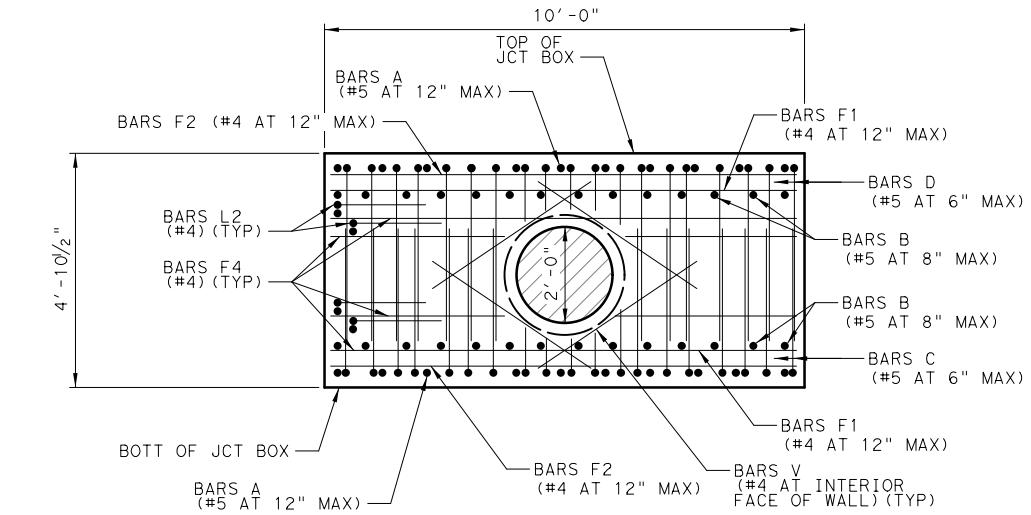

SECTION C-C

(SHOWING 24" RCP OPENING. FIELD CUT BARS AS NECESSARY.)




03/22/2023

NO.	REVISION	BY	DATE			
CP&Y						
TEXAS REGISTERED ENGINEERING FIRM, F-1741						
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FROM FM 2514 (PARKER ROAD) TO FM 2170 (MAIN STREET) FM 2551 (MURPHY ROAD)						
MISC DETAILS JUNCTION BOXES						
10'X8' JUNCTION BOX AT STA 242+49.00						
Designed:	KH	FED. DIV.	RD. NO.	STATE	PROJECT NO.	HIGHWAY NO.
Checked:	CPY	6	TEXAS	SEE TITLE SHEET	FM 2551	
Drawn:	DIST.	COUNTY	CONTROL SECTION NO.	JOB NO.	SHEET NO.	
Checked:	DALLAS	COLLIN	2056	01	042	305F




ADDENDUM 1. 3/22/23. ADDED SHEET

SHEET 6 OF 9

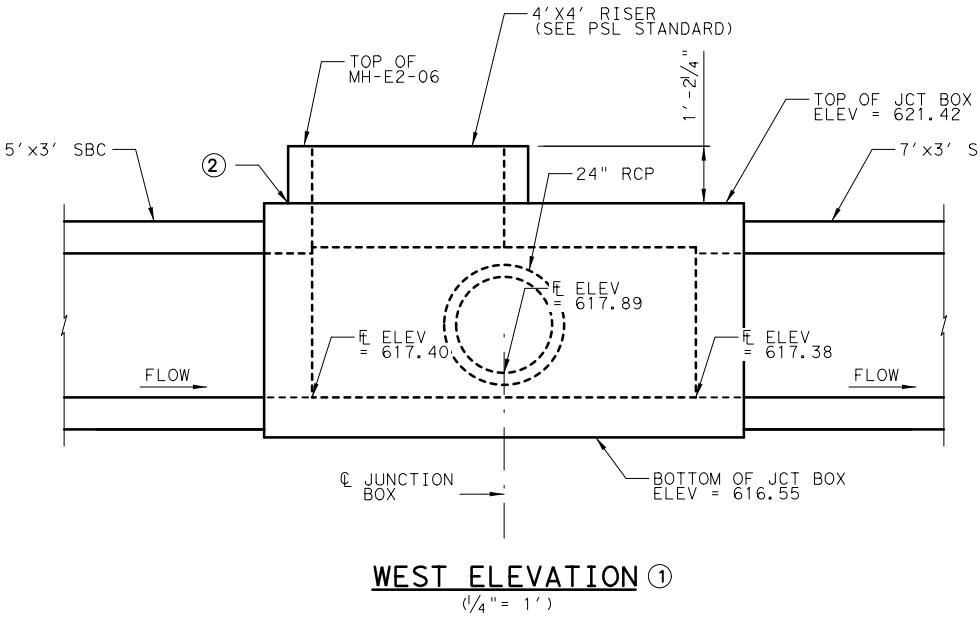

① ELEVATION VIEWS ARE ILLUSTRATIVE AND FOR CONTRACTOR'S INFORMATION ONLY. SEE DRAINAGE PLAN AND PROFILE SHEETS FOR COMPLETE DRAINAGE INFORMATION.

② SEE PBGC STANDARD FOR PRECAST RISER AND RCP TO JUNCTION BOX GROUTED CONNECTION DETAILS AND NOTES.

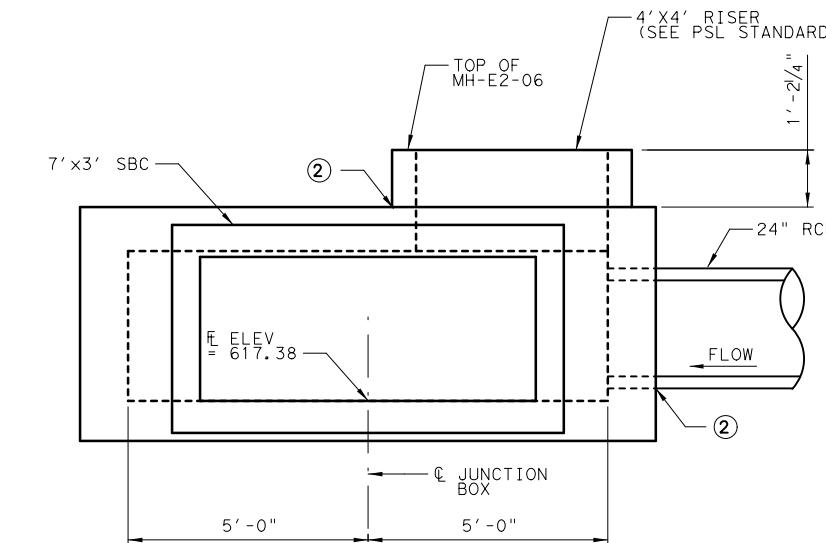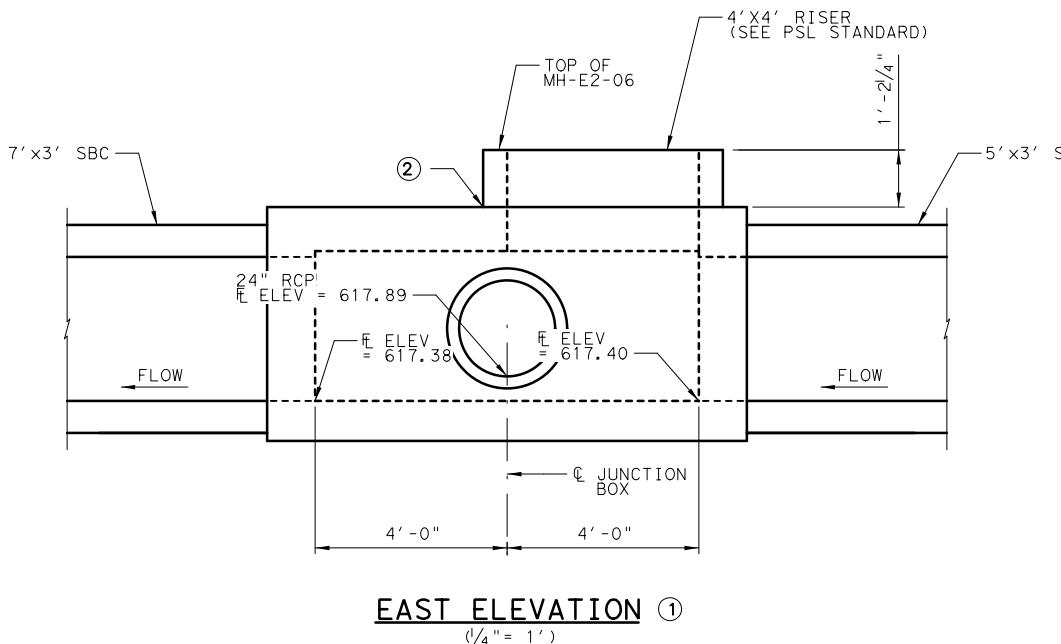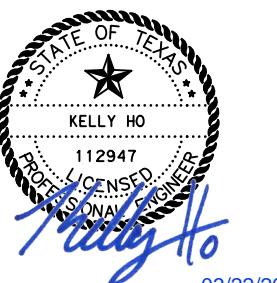

ADDENDUM 1. 3/22/23. REVISED SHEET

- GENERAL NOTES:**
- DESIGNED ACCORDING TO AASHTO LRFD BRIDGE DESIGN SPECIFICATIONS, 9TH EDITION (2020).
 - CLASS "S" CONCRETE, $f'_c = 4,000$ PSI.
 - ALL REINFORCING SHALL BE GRADE 60.
 - ALL EXPOSED CORNERS TO BE CHAMFERED $\frac{3}{4}$ ".
 - REINFORCING BAR DIMENSIONS ARE OUT-TO-OUT OF BAR. COVER DIMENSIONS ARE CLEAR DIMENSIONS.
 - REINFORCING BARS TO BE CUT, BENT OR ADJUSTED AS NECESSARY TO PROVIDE 2" END CLEARANCE TO CONCRETE PIPE OR RISER PENETRATIONS. REINFORCING TO BE ADJUSTED AS NECESSARY TO PROVIDE A MINIMUM OF $\frac{1}{2}$ " CLEAR COVER.
 - SEE DRAINAGE PLAN AND PROFILE SHEETS FOR ADDITIONAL INFORMATION.
 - PAYMENT FOR JUNCTION BOX TO BE PAID FOR BY THE BID ITEM 420 6143 CLASS "S" CONC (JUNCTION BOX).

NO.	REVISION	BY	DATE			
CP&Y						
TEXAS REGISTERED ENGINEERING FIRM. F-1741						
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FROM FM 2514 (PARKER ROAD) TO FM 2170 (MAIN STREET) FM 2551 (MURPHY ROAD)						
MISC DETAILS JUNCTION BOXES						
10'X8' JUNCTION BOX AT STA 245+28.00						
Designed	KH	FED. DIV.	RD. NO.	STATE	PROJECT NO.	HIGHWAY NO.
Checked	CPY	6	TEXAS	SEE TITLE SHEET	FM 2551	
Drawn		DIST.	COUNTY	CONTROL SECTION NO.	JOB NO.	SHEET NO.
Checked		DALLAS	COLLIN	2056	01	042
305G						

SHEET 7 OF 9




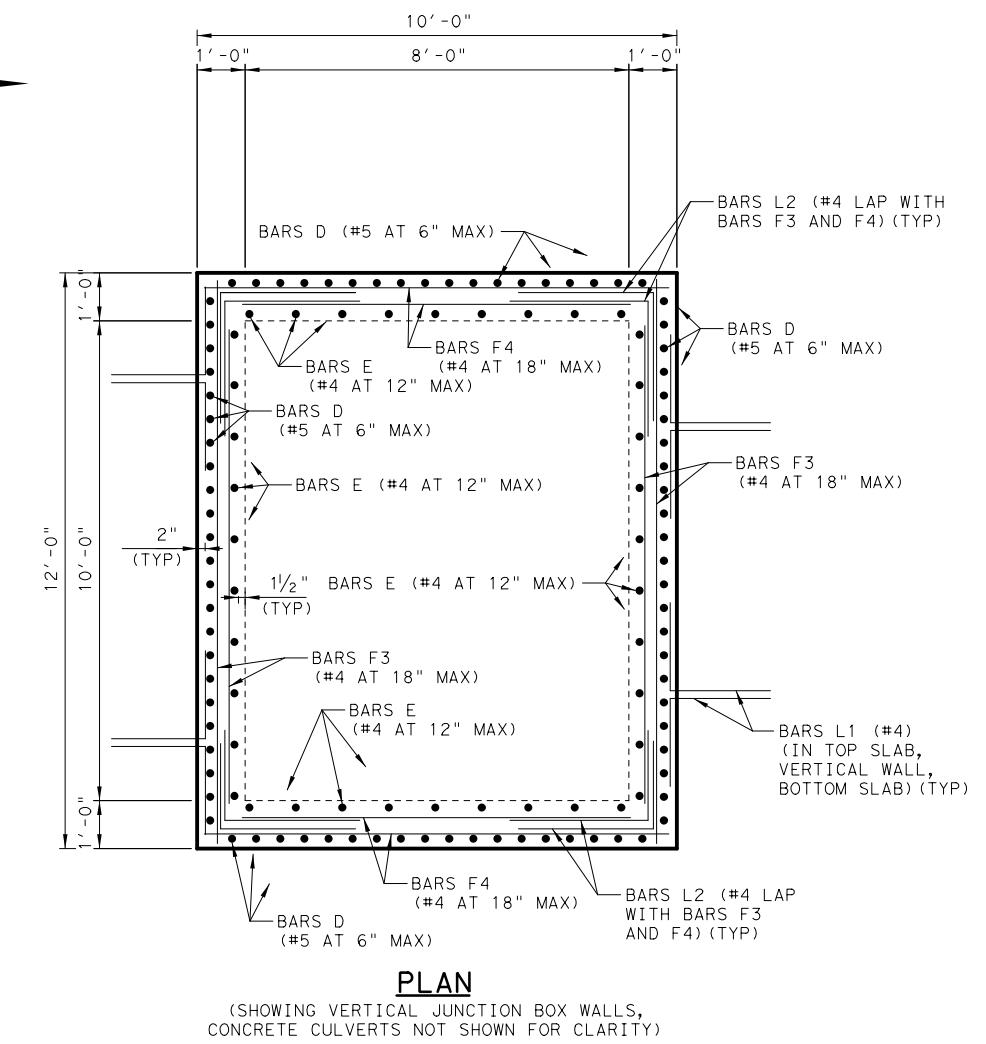


TABLE OF ESTIMATED QUANTITIES 10X8 JUNCTION BOX STA 245+28.00				
BAR	NO.	SIZE	LENGTH	WEIGHT
A	22	#5	11' - 8"	268
B	28	#5	11' - 8"	341
C	82	#5	6' - 0"	513
D	82	#5	6' - 7"	563
E	38	#4	2' - 7"	66
F1	22	#4	9' - 8"	142
F2	24	#4	9' - 8"	155
F3	8	#4	11' - 8"	62
F4	8	#4	9' - 8"	52
L1	24	#4	4' - 2"	67
L2	16	#4	5' - 0"	53
V	4	#4	4' - 0"	11
REINFORCING STEEL				LB 2,293
CLASS "S" CONC (MISC)				CY 10.3

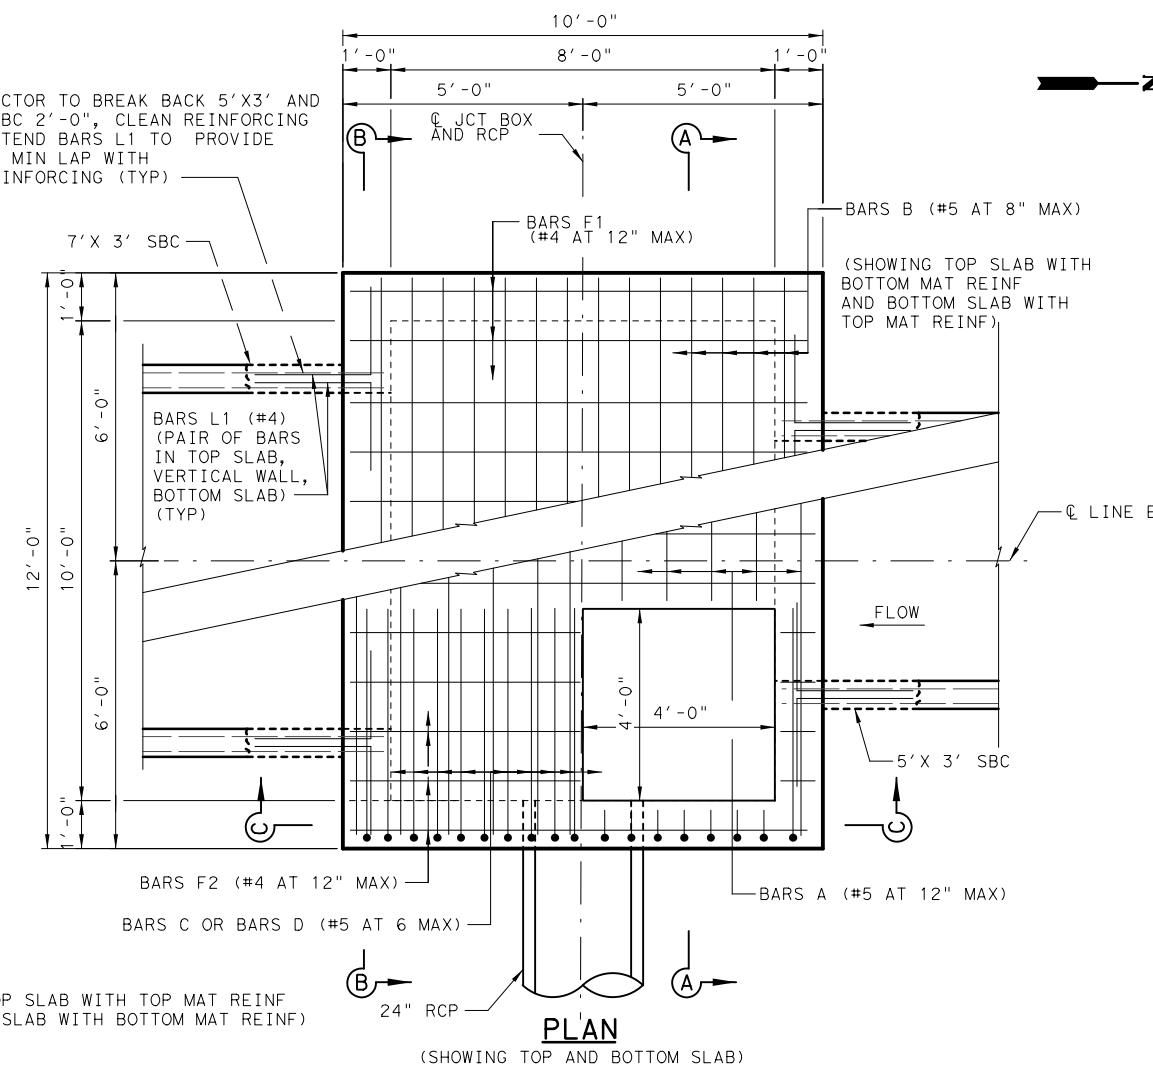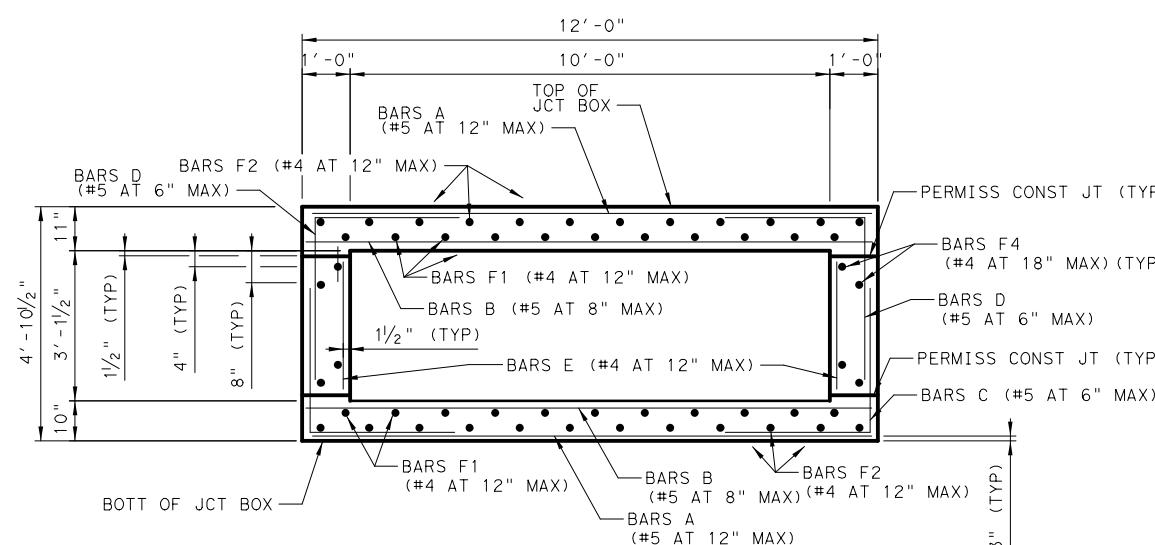

ADDENDUM 1. 3/22/23. REVISED SHEET

SHEET 8 OF 9

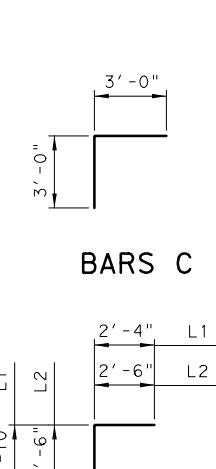


CP&Y

TEXAS REGISTERED ENGINEERING FIRM, F-1741

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 FROM FM 2514 (PARKER ROAD) TO FM 2170 (MAIN STREET)
 FM 2551 (MURPHY ROAD)


MISC DETAILS JUNCTION BOXES
10'X8' JUNCTION BOX AT STA 245+28.00

Designed	KH	FED.	RD. NO.	STATE	PROJECT NO.	HIGHWAY NO.
Checked	CPY	6	TEXAS	SEE TITLE SHEET	FM 2551	
Drawn						
Checked	DALLAS	COLLIN	2056	01	042	305H

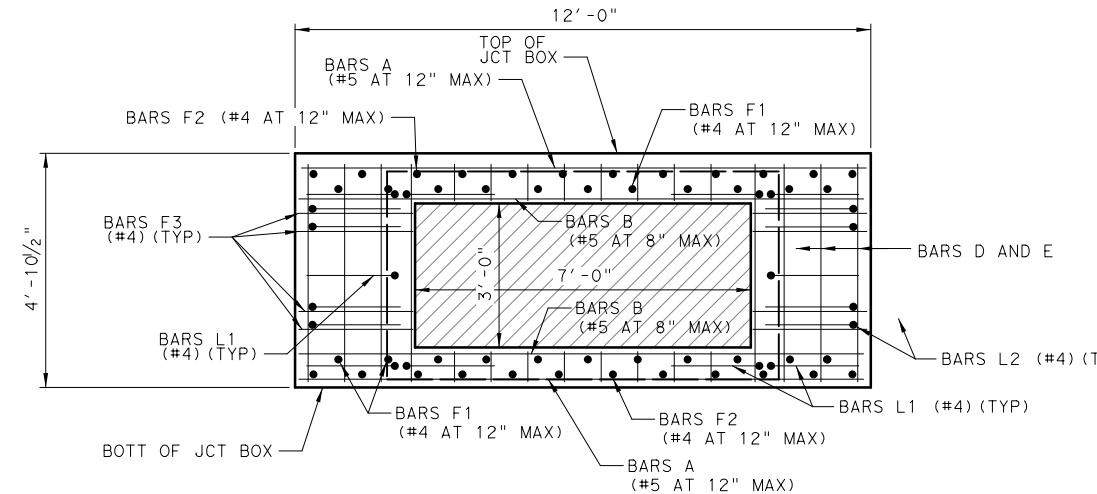

SECTION B-B

(SHOWING 7'X3' OPENING, 5'X3' SIMILAR.
FIELD CUT BARS AS NECESSARY.)

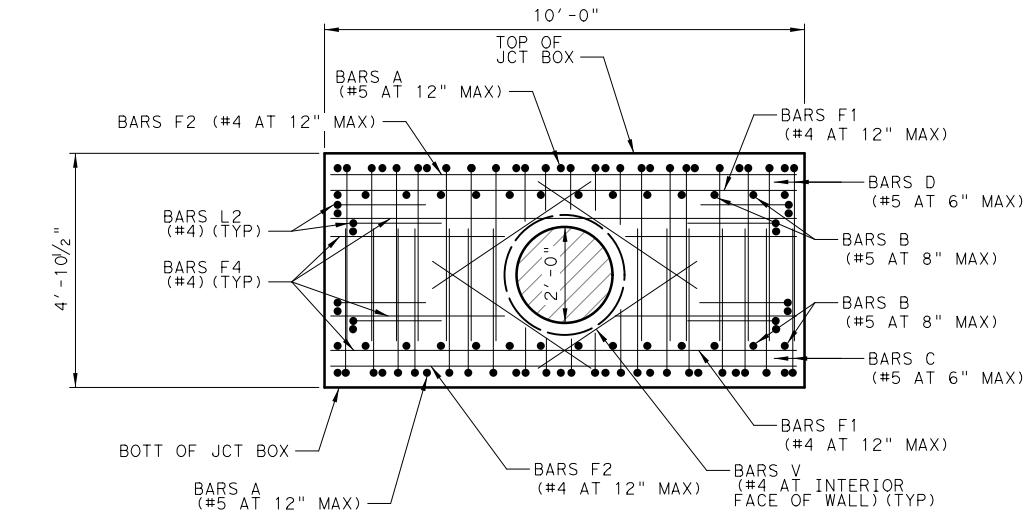

SECTION C-C

(SHOWING 24" RCP OPENING. FIELD CUT BARS AS NECESSARY.)



NO.	REVISION	BY	DATE			
CP&Y						
TEXAS REGISTERED ENGINEERING FIRM, F-1741						
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FROM FM 2514 (PARKER ROAD) TO FM 2170 (MAIN STREET) FM 2551 (MURPHY ROAD)						
MISC DETAILS JUNCTION BOXES						
10'X8' JUNCTION BOX AT STA 245+28.00						
Designed:	KH	FED. DIV.	RD. NO.	STATE	PROJECT NO.	HIGHWAY NO.
Checked:	CPY	6	TEXAS	SEE TITLE SHEET	FM 2551	
Drawn:	DIST.	COUNTY	CONTROL SECTION NO.	JOB NO.	SHEET NO.	
Checked:	DALLAS	COLLIN	2056	01	042	3051

ADDENDUM 1. 3/22/23. ADDED SHEET

SHEET 9 OF 9