912-00-710

J

PROJ. NO.: _____

HARRIS VARIOUS

COUNTY: HWY. NO. DATE ACC

STATE OF TEXAS DEPARTMENT OF TRANSPORTATION

INDEX OF SHEETS


SEE SHEET 2 FOR INDEX OF SHEETS

PLANS OF PROPOSED

STATE HIGHWAY IMPROVEMENT

FORT BEND AND WALLER COUNTIES VARIOUS ROADWAYS LIMITS: VARIOUS LOCATIONS IN FORT BEND AND WALLER COUNTIES PROJECT: C 912-00-710 CONTROL 0912-00-710

FOR THE CONSTRUCTION OF PAVEMENT MARKINGS.

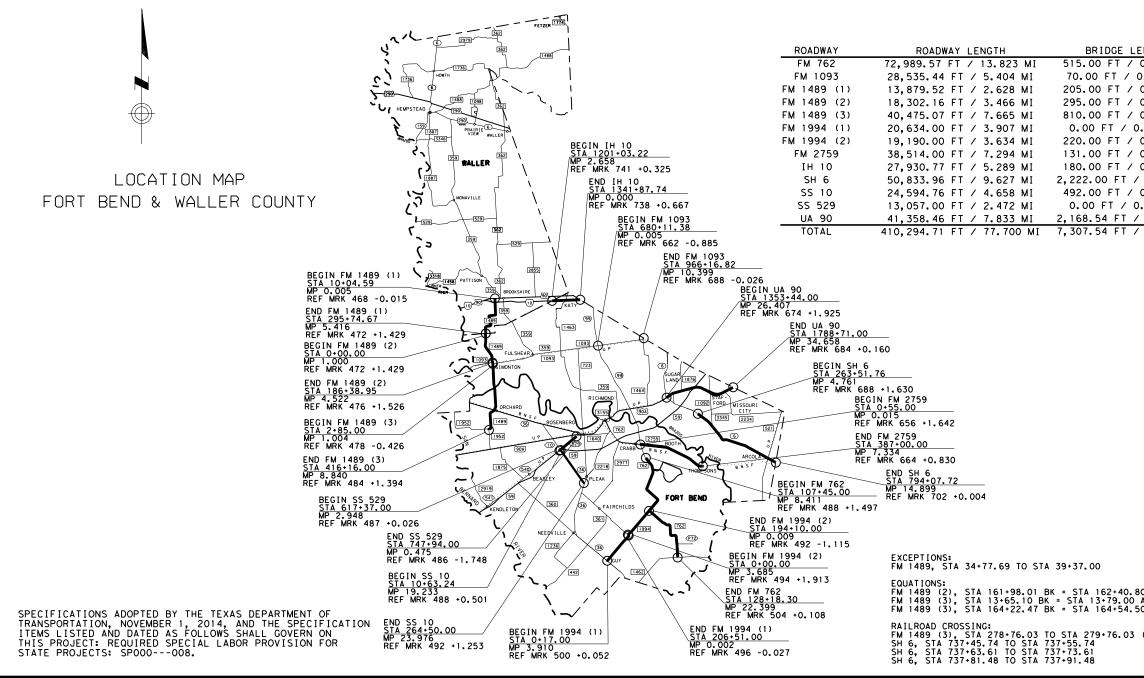

FED.RD. DIV.NO.	PR	OJECT N	۷0.	SHEET NO.
6	C 9	912-00-	710	1
STATE	DIST.		COUNT	Y
TEXAS	HOU		HARRI	S
CONT.	SECT.	JOB	HIGH	IWAY NO.
0912	00	710	VA	RIOUS

BRIDGE LENGTH	TOTAL LENGTH
5.00 FT / 0.097 MI	73,504.57 FT / 13.921 MI
0.00 FT / 0.013 MI	28,605.44 FT / 5.417 MI
5.00 FT / 0.038 MI	14,084.52 FT / 2.667 MI
5.00 FT / 0.055 MI	18,596.16 FT / 3.522 MI
0.00 FT / 0.153 MI	41,285.07 FT / 7.819 MI
.00 FT / 0.000 MI	20,634.00 FT / 3.907 MI
0.00 FT / 0.041 MI	19,410.00 FT / 3.676 MI
1.00 FT / 0.024 MI	38,645.00 FT / 7.319 MI
0.00 FT / 0.034 MI	28,110.77 FT / 5.324 MI
22.00 FT / 0.420 MI	53,055.96 FT / 10.048 MI
2.00 FT / 0.093 MI	25,086.76 FT / 4.751 MI
.00 FT / 0.000 MI	13,057.00 FT / 2.472 MI
68.54 FT / 0.410 MI	43,527.00 FT / 8.243 MI
07.54 FT / 1.378 MI	417,602.25 FT / 79.086 MI

	© 2024 Texas Departm All Rights Rese	Rent of Transportation arved.
	SUBMITTED FOR LETTING:	2/14/2024
	—DocuSigned by:	
	Carlos M. Zepeda,	Jr., P.E.
l	AREĂ ÊNGINEER 999EB2AF5ACE472	-
0_AH	APPROVED FOR LETTING:	2/15/2024
ан Оан	DocuSigned by:	
(BNSF RR)	Brett McLeod	, P.E.
	FE9C2D7C24E543D FOF DISTRICT ENGINE	EER

SHEET NO. DESCRIPTION

I. GENERAL

*

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- 2 INDEX OF SHEETS
- 3, 3A-3C GENERAL NOTES
- 4, 4A-4B ESTIMATE & QUANTITY SHEET
- 5-14 SUMMARY OF QUANTITIES

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- * 27 TRAFFIC CONTROL PLAN TYPICAL DETAILS WZ(TD)-17
- 28 WORK ZONE GIVE US A BREAK SIGNS WZ(BRK)-13
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- * 30 TCP MOBILE OPERATIONS UNDIVIDED HIGHWAYS TCP(3-1)-13
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47-50	PAVEMENT	MARKING	LAYOUT	- FM	1489 - US 90 TO FORT BEND COUNTY LINE
51-52	PAVEMENT	MARKING	LAYOUT	- FM	1489 - WALLER COUNTY LINE TO FM 1093
53-57	PAVEMENT	MARKING	LAYOUT	- FM	1489 - FM 1093 TO FM 1952
58-60	PAVEMENT	MARKING	LAYOUT	- FM	1994 - SH 36 TO FM 361
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68-69	PAVEMENT	MARKING	LAYOUT	- IH	10 - WALLER COUNTY LINE TO HARIS COUNTY LINE
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76-78	PAVEMENT	MARKING	LAYOUT	- 55	10 - US 59 TO SH 36
79-80	PAVEMENT	MARKING	LAYOUT	- 55	529 - US 59 TO WEST OF FM 1640
01 07	DAVEMENT	MADKINC		11.0	OD EH E TO HADDLE COUNTY LINE

81-87 PAVEMENT MARKING LAYOUT - UA 90 - SH 6 TO HARRIS COUNTY LINE

SHEET NO. DESCRIPTION

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- RAILROAD CROSSING DETAILS SIGNING, STRIPING, AND DEVICE PLACEMENT RCD(1)-22 88 89 RAILROAD CROSSING DETAILS SIGNING & STRIPING RCD(2)-22 TYPICAL STANDARD PAVEMENT MARKINGS PM(1)-22 90 91 POSITION GUIDANCE USING RAISED MARKERS REFLECTORIZED PROFILE MARKINGS PM(2)-22 92 TWO-WAY LEFT TURN LANES, RURAL LEFT TURN BAYS, AND LANE REDUCTION PAVEMENT MARKINGS PM(3)-22 CROSSWALK PAVEMENT MARKINGS PM(4)-22A 93 94 TYPICAL STANDARD FREEWAY PAVEMENT MARKINGS WITH RAISED PAVEMENT MARKERS FPM(1)-22 95 TYPICAL STANDARD FREEWAY PAVEMENT MARKINGS ENTRANCE AND EXIT RAMPS FPM(2)-22 TYPICAL STANDARD FREEWAY PAVEMENT MARKINGS SINGLE LANE DROP (EXIT ONLY) AND LANE REDUCTION DETAILS FPM(3)-22 96 97 TYPICAL STANDARD FREEWAY PAVEMENT MARKINGS MULTIPLE LANE DROP (EXIT) DETAILS FPM(4)-22 98 EXIT GORE PAVEMENT MARKINGS FPM(5)-22 99 TYPICAL STANDARD FREEWAY AND FRONTAGE ROAD PAVEMENT MARKINGS FPM(6)-22 SIGNING AND PAVEMENT MARKING DETAILS EXIT RAMPS-FRONTAGE ROAD ER-FR(1)-09 (HOU DIST) 100 * SIGNING AND PAVEMENT MARKING DETAILS EXIT RAMPS-FRONTAGE ROAD ER-FR(2)-09 (HOU DIST) 101
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128-129	RAILROAD	REQUIREM	IENTS	FOR NON-L	BRIDGE CC	NSTRUCTIO	N PROJE

V. ENVIRONMENTAL

130 ENVIRONMENTAL PERMITS, ISSUES AND COMMITMENTS EPIC

/ SH 6 / UA 90 IECTS

ROBERT S. BISSE

* THE STANDARD SHEETS SPECIFICALLY IDENTIFIED ABOVE HAVE BEEN SELECTED BY ME OR UNDER MY RESPONSIBLE SUPERVISION AS BEING APPLICABLE TO THIS PROJECT.

Robert & Bisett p. P.E. 02/12/24 DATE

INDEX OF SHEETS

®	CONT	SECT	JOB	HIGHWAY
	0912	00	710	VARIOUS
©2023 Texas Department	DIST	COUNTY		SHEET NO.
of Transportation	HOU		HARRIS	2

County: Harris

Highway: Various

General Notes:

General:

Area Engineer contact information for this project follows:

Carlos M. Zepeda, Jr., P.E., Email: Carlos.Zepeda@txdot.gov

Daniel J. Dvorak, P.E. Email:Daniel.Dvorak@txdot.gov

Submit any questions about this project via the Letting Pre-Bid Q&A web page, located at:

https://tableau.txdot.gov/views/ProjectInformationDashboard/NoticetoContractors

The Letting Pre-Bid Q&A web page for each project can be accessed by scrolling or filtering the dashboard using the controls on the left side to navigate to the project. Hover over the blue hyperlink of the project to view the Q&A and click on the link in the window that pops up.

Large files with relevant project documentation, such as Geotech reports, As-Built plans, and cross-sections will continue to be provided on the following FTP site:

Index of /pub/txdot-info/Pre-Letting Responses/Houston District (state.tx.us) or

https://ftp.dot.state.tx.us/pub/txdot-info/Pre-Letting%20Responses/Houston%20District/

References to manufacturer's trade name or catalog numbers are for the purpose of identification only. Similar materials from other manufacturers are permitted if they are of equal quality, comply with the specifications for this project, and are approved, except for roadway illumination, electrical, and traffic signal items.

The cost for materials, labor, and incidentals to provide for traffic across the roadway and for ingress and egress to private property in accordance with Section 7.2.4 of the standard specifications is subsidiary to the various bid items. Restore access roadways to their original condition upon completing construction.

Tolls incurred by the Contractor are subsidiary to the various bid items.

Procure permits and licenses, which are to be issued by the City, County, or Municipal Utility District.

General: Site Management

Do not mix or store materials, or store or repair equipment, on top of concrete pavement or bridge decks unless authorized by the Engineer. Permission will be granted to store materials on surfaces if no damage or discoloration will result.

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County: Harris

Highway: Harris

Personal vehicles of employees are not permitted to park within the right of way, including sections closed to public traffic. Employees may park on the right of way at the Contractor's office, equipment, and materials storage yard sites.

Assume ownership of debris and dispose of at an approved location. Do not dispose of debris on private property unless approved in writing by the District Engineer.

Control the dust caused by construction operations. For sweeping the base material in preparation for laying asphalt and for sweeping the finished concrete pavement, use one of the following types of sweepers or approved equal:

Tricycle Type

Wayne Series 900 Elgin White Wing Elgin Pelican

General: Utilities

If the Contractor damages or causes damage (breaks, leaks, nicks, dents, gouges, etc.) to the utility, contact the utility facility owner or operator immediately.

Be aware that an operational Computerized Transportation Management System (CTMS) exists within the limits of this project and that the system must remain operational throughout construction. If the Contractor damages or causes damage to this system, repair such damage within 8 hours of occurrence at no cost to the Department. In the event of system damage, notify the Director of Traffic Management Systems at 713-881-3283 within one hour of occurrence. Failure of the Contractor to repair damage to the main fiber optic cable and CCTV cable trunk lines, which convey all corridor information to TranStar, will result in the Contractor being billed for the full cost of emergency repairs.

At least 72 hours before starting work, make arrangements for locating existing Departmentowned above ground and underground fiber optic, communications, power, illumination, and traffic signal cabling and conduit. Do this by calling the Department's Houston District Traffic Signal Operations Office at 713-802-5662, or by e-mailing the Department's Houston District Traffic Signal Operations Office at: HOU-LocateRequest@txdot.gov, to schedule marking of underground lines on the ground. Use caution if working in these areas to avoid damaging or interfering with existing facilities.

If overhead or underground power lines need to be de-energized, contact the electrical service provider to perform this work. Costs associated with de-energizing the power lines or other protective measures required are at no expense to the Department.

If working near power lines, comply with the appropriate sections of Texas State Law and Federal Regulations relating to the type of work involved.

Control: 0912-00-710

Truck Type - 4 Wheel

M-B Cruiser II Wayne Model 945 Mobile TE-3 Mobile TE-4 Murphy 4042

General Notes

Highway: Various

Item 7: Legal Relations and Responsibilities

This project does not require a U.S. Army Corps of Engineers (USACE) Section 404 Permit before letting, but if a permit is needed during construction, assume responsibility for preparing the permit application. Submit the permit application to the Department's District Environmental Section for approval. Once the permit application is approved, the Department will submit it to the USACE. Assume responsibility for the requested revisions, in coordination with the Department's District Environmental Section.

If the work is on or in the vicinity of an at-grade railroad crossing, involves incidental work on railroad right of way, or involves construction of a railroad grade separation structure, notify the railroad company's Division Engineer and the Department's Project Engineer at least 30 days before performing any work on the railroad right of way and make arrangements for railroad flaggers unless otherwise shown in the contract. Obtain the required Railroad Right of Entry Permit from the railroad company. Payment of applicable permit fees is the responsibility of the Contractor. Acquiring the Railroad Right of Entry Permit is a lengthy process, allow sufficient time for this.

This project is on a hurricane evacuation route. Provide at the pre-construction meeting a written plan outlining procedures to suspend work, secure the job site, and safely handle traffic through and across the project in the event of a hurricane evacuation.

During the hurricane season (June 1 through November 30), do not close any travel lanes except when the Contractor can demonstrate that he/she can provide labor, equipment, material, a work plan, and quality of work to satisfactorily return all lanes to an open, all-weather travel surface within 3 days of receiving written or verbal notice but no later than 3 days before the predicted hurricane landfall. Construction of temporary lanes to an all-weather surface will be paid for in accordance with Article 9.7, "Payment for Extra Work and Force Account Method."

In addition to lane closures, cease work 3 days before the predicted hurricane landfall on or near the roadway that adversely impacts the flow of traffic and reduces the capacity of the highway during an evacuation. Vehicles of the Contractor, subcontractors, or material suppliers will not be allowed to enter or exit the traffic stream, including those for the purpose of material hauling and delivery, and mobilization or demobilization of equipment. When directed, this prohibition will include a reasonable time period for the evacuees to return to their point of origin.

No significant traffic generator events have been identified.

Item 8: Prosecution and Progress

The Department will not adjust the number of days for the project and milestones, if any, due to differences in opinion regarding any assumptions made in the preparation of the schedule or for errors, omissions, or discrepancies found in the time determination schedule.

Working days will be computed and charged based on a standard workweek in accordance with Section 8.3.1.4.

County: Harris

Highway: Harris

Item 502: Barricades, Signs, and Traffic Handling

Use a traffic control plan for handling traffic through the various phases of construction. Follow the phasing sequence unless otherwise agreed upon by the Area Engineer and the Project Manager. Ensure this plan conforms to the latest "Texas Manual on Uniform Traffic Control Devices" and the latest Barricade and Construction (BC) Standard Sheets.

Submit changes to the traffic control plan to the Area Engineer. Provide a layout showing the construction phasing, signs, striping, and signalizations for changes to the original traffic control plan.

Furnish and maintain the barricades and warning signs, including the necessary temporary and portable traffic control devices, during the various phases of construction. Place and construct these barricades and warning signs in accordance with the latest "Texas Manual on Uniform Traffic Control Devices" for typical construction layouts.

Cover work zone signs when work related to the signs is not in progress, or when any hazard related to the signs no longer exists.

Keep the delineation devices, signs, and pavement markings clean. This work is subsidiary to the Item, "Barricades, Signs, and Traffic Handling."

Erect temporary signs when exit ramps are closed or moved to new locations during construction.

Before detouring traffic onto the mainlane shoulders, remove dirt, debris, vegetation, and other deleterious material from the surface of the shoulders. Appropriately sign the detour in an approved manner. This work is subsidiary to the various bid items.

Do not mount signs on drums or barricades, except those listed in the latest Barricades and Construction standard sheets.

Use traffic cones for daytime work only. Replace the cones with plastic drums during nighttime hours.

Do not reduce the existing number of lanes open to traffic except as shown on the following time schedule:

One Lane Closure/Two Lane Roadway Facility FM 762 (A Myors Rd to FM 1462) FM 1489 FM 1994 & SS 529

Day	Daytime Work Hours	Nighttime Work Hours	Restricted Hours Subject to Lane Assessment Fee
Monday Through Friday	No Restrictions	No Restrictions	No Restrictions

Control: 0912-00-710

Highway: Various

Control: 0912-00-710

One Lane Closure/Two Lane Roadway Facility

FM 2759 (FM 762 to Thompsons)					
Day	Daytime Work Hours	Nighttime Work	Restricted Hours		
		Hours			
Monday Through Friday	9:00 AM - 3:00 PM	7:00 PM -12:00 AM 12:00 AM - 5:00 AM	5:00 AM - 9:00 AM 3:00 PM - 7:00 PM		

One Lane Closure/Four Lane Highway Facility SS 10 (US 59 to SH 36S)

Day	Daytime Work Hours	Nighttime Work Hours	Restricted Hours Subject to Lane Assessment Fee
Monday Through Friday	No Restrictions	No Restrictions	No Restrictions

One Lane Closure/Four Lane Highway Facility

FM 762 (FM 2759 to A. Myers Rd.) & FM 1093 (Main St. in Fulshear to Harris C/L)

Day	Daytime Work	Nighttime Work	Restricted Hours Subject
	Hours	Hours	to Lane Assessment
Monday through Friday	9:00 AM – 3:00 PM	7:00 PM-12:00 AM 12:00 AM- 5:00 AM	5:00 AM -9:00 AM 3:00 PM- 7:00 PM

One, Two or More Lane Closure/Multiple Lane Highway IH 10 ML, SH 6, & UA 90A (SH 6 to Harris C/L)

Day	Daytime Work Hours	Nighttime Work Hours	Restricted Hours Subject to Lane Assessment Fee
Monday Through Friday	None	9:00 PM – 12:00 AM 12:00 AM - 5:00 AM	5:00 AM - 9:00 PM

Weekend One/Two Lane Closure

]	FM 762, FM 1093, FM 1489, FM 1994, FM 2759, IH 10, SH 6, SS 10, SS 529, & UA 90A						
	Day	Daytime Work	Nighttime Work	Restricted Hours Subject			
	-	Hours	Hours	to Lane Assessment Fee			
	Saturday Through Sunday	None	8:00 PM - 12:00 AM 12:00 AM - 11:00 AM	11:00 AM - 8:00 PM			

The above times are approved for the traffic control conditions listed. The Area Engineer may approve other closure times if traffic counts warrant. The Area Engineer may reduce the above times for special events.

Law enforcement assistance will be required for this project and is expected to be required for major traffic control changes and lane closures. Coordinate with local law enforcement and

County: Harris

Highway: Harris

arrange for law enforcement as directed or agreed by the Engineer. Before payment will be made, complete the "Daily Report on Law Enforcement Force Account Work" (Form 318), provided by the Department and submit daily invoices that agree with this form for any day during the month in which approved services were provided.

Provide full-time, off-duty, uniformed, certified peace officers, as part of traffic control operations. The peace officers must be able to show proof of certification by the Texas Commission on Law Enforcement Officers Standards. The cost of the officers is paid for on a force account basis.

The Contractor Force Account "Safety Contingency" that has been established for this project is intended to be utilized for work zone enhancements, to improve the effectiveness of the Traffic Control Plan, that could not be foreseen in the project planning and design stage. These enhancements will be mutually agreed upon by the Engineer and the Contractor's Responsible Person based on weekly or more frequent traffic management reviews on the project. The Engineer may choose to use existing bid items if it does not slow the implementation of enhancement.

Item 506: Temporary Erosion, Sedimentation and Environmental Controls

Due to the nature of the work involved, a Storm Water Pollution Prevention Plan (SWP3) is not required. However, if a SWP3 becomes necessary, it will be paid as extra work.

Item 666: Reflectorized Pavement Markings Item 668: Prefabricated Pavement Markings Item 6020: Multipolymer Pavement Markings (MPM) with Warranty

Use Type III glass beads for thermoplastic and multipolymer pavement markings.

Use a 0.100 in. (100 mil) thickness for thermoplastic pavement markings, measured to the top of the thermoplastic, not including the exposed glass beads.

Use a 0.022 in. (22 mil) thickness for multipolymer pavement markings, measured to the top of the multipolymer, not including the exposed glass beads.

For roadways with asphalt surfaces to be striped with work zone or permanent thermoplastic markings, the Contractor has the option to apply paint and beads markings for a maximum 30-day period until placing the thermoplastic markings, or until starting the succeeding phase of work on the striped area. Maintain the paint and beads markings, at no expense to the Department, until placing the thermoplastic markings or starting the succeeding phase of work on the striped area. The work zone markings, whether paint and beads or thermoplastic, are paid under the Item, "Work Zone Pavement Markings" and the markings are paid for only once for the given phase of construction.

If using paint and bead markings as described above, purchase the traffic paint from the open market.

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County: Harris

Highway: Various

Control: 0912-00-710

If the Type II markings become dirty and require cleaning by washing, brushing, compressed air, or other approved methods before applying the Type I thermoplastic markings, this additional cleaning is subsidiary to the Item, "Reflectorized Pavement Markings."

Establish the alignment and layout for work zone striping and permanent striping.

Stripe all roadways before opening them to traffic.

Place pavement markings under these items in accordance with details shown on the plans, the latest "Texas Manual on Uniform Traffic Control Devices," or as directed.

When design details are not shown on the plans, provide pavement markings for arrows, words, and symbols conforming to the latest "Standard Highway Sign Designs for Texas" manual.

Item 672: Raised Pavement Markers

If other operations are complete on the project and if the curing time period is not yet elapsed, the contract time will be suspended until the curing is done.

Before placing the raised pavement markers on concrete pavement, blast clean the surface using an abrasive-blasting medium. This work is subsidiary to the Item, "Raised Pavement Markers."

Provide epoxy adhesive that is machine-mixed or nozzle-mixed and dispensed. Equip the machine or nozzle with a mechanism to ensure positive mix measurement control.

Item 677: Eliminating Existing Pavement Markings and Markers

Remove existing pavement markings on concrete or asphalt surfaces by flail milling or as directed.

Item 678: Pavement Surface Preparation for Markings

Do not blast clean asphalt concrete pavement. Clean asphalt concrete pavement as required under the applicable specifications or as directed.

On new concrete pavement or on existing concrete pavement when placing a new stripe on a new location, remove the curing compounds and contamination from the pavement surface by flail milling or as directed. In addition, air-blast the surface with compressed air just before placing the new stripe.

On existing concrete pavement when placing a new stripe on an existing location, after removing the existing stripe under the Item, "Eliminating Existing Pavement Markings and Markers," airblast the surface with compressed air just before placing the new stripe.

Do not clean concrete pavement by grinding.

County: Harris

Highway: Harris

Item 6185: Truck Mounted Attenuator (TMA) and Trailer Attenuator (TA)

A shadow vehicle with Truck Mounted Attenuators (TMAs) or Trailer Attenuators (TAs) is required as shown on the appropriate Traffic Control Plan (TCP) sheets. TMAs/TAs must meet the requirements of the Compliant Work Zone Traffic Control Device List.

Level 3 Compliant TMAs/TAs are required for this project.

A total of one (1) shadow vehicle with a TMA/TA is required for the work with the exception of Pavement Marking Operations. The Contractor is responsible for determining if one or more of these operations will be ongoing at the same time to determine the total number of TMAs/TAs needed on the project.

A total of three (3) shadow vehicles with a TMA/TA are required for Pavement Marking Operations. The Contractor is responsible for determining if one or more of these operations will be ongoing at the same time to determine the total number of TMAs/TAs needed on the project.

Control: 0912-00-710



CONTROLLING PROJECT ID 0912-00-710

DISTRICT Houston **HIGHWAY** Various

Estimate

COUNTY Harris

Qua tity Sheet

		CONTROL SECTION	ON JOB	0912-00	-710				
		PROJ	ECT ID	A00197	/984				
		C	ουντγ	Harr	is	TOTAL EST.	TOTAL FINAL		
		ніс	HWAY	Vario	us		TINAL		
ALT	BID CODE	DESCRIPTION	UNIT	EST.	FINAL				
	500-6001	MOBILIZATION	LS	1.000		1.000			
	502-6001	BARRICADES, SIGNS AND TRAFFIC HANDLING	мо	8.000		8.000			
	666-6036	REFL PAV MRK TY I (W)8"(SLD)(100MIL)	LF	16,317.000		16,317.000			
	666-6048	REFL PAV MRK TY I (W)24"(SLD)(100MIL)	LF	9,159.000		9,159.000			
	666-6054	REFL PAV MRK TY I (W)(ARROW)(100MIL)	EA	102.000		102.000			
	666-6078	REFL PAV MRK TY I (W)(WORD)(100MIL)	EA	96.000		96.000			
	666-6093	REFL PAV MRK TY I (W)(RR XING)(100MIL)	EA	3.000		3.000			
	666-6102	REF PAV MRK TY I(W)36"(YLD TRI)(100MIL)	EA	6.000		6.000			
	666-6147	REFL PAV MRK TY I (Y)24"(SLD)(100MIL)	LF	11,109.000		11,109.000			
	666-6162	RE PV MRK TY I(BLACK)6"(SHADOW)(100MIL)	LF	11,900.000		11,900.000			
	666-6212	REFL PAV MRK TY II (Y) 12" (SLD)	LF	74,140.000		74,140.000			
	666-6225	PAVEMENT SEALER 6"	LF	303,175.000		303,175.000			
	666-6226	PAVEMENT SEALER 8"	LF	1,332.000		1,332.000			
	666-6230	PAVEMENT SEALER 24"	LF	499.000		499.000			
	666-6231	PAVEMENT SEALER (ARROW)	EA	10.000		10.000			
	666-6232	PAVEMENT SEALER (WORD)	EA	12.000		12.000			
	666-6243	PAVEMENT SEALER (YLD TRI)	EA	6.000		6.000			
	666-6306	RE PM W/RET REQ TY I (W)6"(BRK)(100MIL)	LF	115,188.000		115,188.000			
	666-6309	RE PM W/RET REQ TY I (W)6"(SLD)(100MIL)	LF	154,917.000		154,917.000			
	666-6318	RE PM W/RET REQ TY I (Y)6"(BRK)(100MIL)	LF	20,617.000		20,617.000			
	666-6321	RE PM W/RET REQ TY I (Y)6"(SLD)(100MIL)	LF	113,603.000		113,603.000			
	666-6343	REF PROF PAV MRK TY I(W)6"(SLD)(100MIL)	LF	307,426.000		307,426.000			
	666-6346	REF PROF PAV MRK TY I(Y)6"(BRK)(100MIL)	LF	21,370.000		21,370.000			
	666-6347	REF PROF PAV MRK TY I(Y)6"(SLD)(100MIL)	LF	110,687.000		110,687.000			
	668-6010	PREFAB PAV MRK TY B (W)(6")(BRK)CNTST	LF	14,040.000		14,040.000			
	668-6077	PREFAB PAV MRK TY C (W) (ARROW)	EA	474.000		474.000			
	668-6078	PREFAB PAV MRK TY C (W) (DBL ARROW)	EA	45.000		45.000			
	668-6080	PREFAB PAV MRK TY C (W) (UTURN ARROW)	EA	9.000		9.000			
	668-6084	PREFAB PAV MRK TY C (W) (NUMBER)	EA	3.000		3.000			
	668-6085	PREFAB PAV MRK TY C (W) (WORD)	EA	435.000		435.000			
	668-6089	PREFAB PAV MRK TY C (W) (RR XING)	EA	8.000		8.000			
	668-6091	PREFAB PAV MRK TY C (W) (18")(YLD TRI)	EA	73.000		73.000			
	668-6092	PREFAB PAV MRK TY C (W) (36")(YLD TRI)	EA	156.000		156.000			
	672-6006	REFL PAV MRKR TY I-A	EA	115.000		115.000			
	672-6007	REFL PAV MRKR TY I-C	EA	528.000		528.000			
	672-6009	REFL PAV MRKR TY II-A-A	EA	7,363.000		7,363.000			
	672-6010	REFL PAV MRKR TY II-C-R	EA	13,992.000		13,992.000			



DISTRICT	COUNTY	CCSJ	SHEET
Houston	Harris	0912-00-710	4



CONTROLLING PROJECT ID 0912-00-710

DISTRICT Houston **HIGHWAY** Various

Estimate

COUNTY Harris

Qua tity Sheet

		CONTROL SECTION	ON JOB	0912-00	-710		
		PROJ	ECT ID	A00197	/984		
		C	ουντγ	Harr	is	TOTAL EST.	TOTAL FINAL
		ніс	GHWAY	Vario	us		FINAL
٩LT	BID CODE	DESCRIPTION	UNIT	EST.	FINAL		
	677-6001	ELIM EXT PAV MRK & MRKS (4")	LF	259,879.000		259,879.000	
	677-6002	ELIM EXT PAV MRK & MRKS (6")	LF	146,967.000		146,967.000	
	677-6003	ELIM EXT PAV MRK & MRKS (8")	LF	39,313.000		39,313.000	
	677-6005	ELIM EXT PAV MRK & MRKS (12")	LF	30,583.000		30,583.000	
	677-6007	ELIM EXT PAV MRK & MRKS (24")	LF	13,016.000		13,016.000	
	677-6008	ELIM EXT PAV MRK & MRKS (ARROW)	EA	207.000		207.000	
	677-6009	ELIM EXT PAV MRK & MRKS (DBL ARROW)	EA	35.000		35.000	
	677-6012	ELIM EXT PAV MRK & MRKS (WORD)	EA	189.000		189.000	
	677-6016	ELIM EXT PAV MRK & MRKS (RR XING)	EA	4.000		4.000	
	677-6018	ELIM EXT PAV MRK & MRKS (18")(YLD TRI)	EA	61.000		61.000	
	677-6019	ELIM EXT PAV MRK & MRKS (36")(YLD TRI)	EA	144.000		144.000	
	677-6036	ELIM EXT PAV MRK & MRKS (UTURN ARROW)	EA	7.000		7.000	
	678-6002	PAV SURF PREP FOR MRK (6")	LF	423,096.000		423,096.000	
	678-6004	PAV SURF PREP FOR MRK (8")	LF	39,313.000		39,313.000	
	678-6006	PAV SURF PREP FOR MRK (12")	LF	10,493.000		10,493.000	
	678-6008	PAV SURF PREP FOR MRK (24")	LF	16,228.000		16,228.000	
	678-6009	PAV SURF PREP FOR MRK (ARROW)	EA	207.000		207.000	
	678-6010	PAV SURF PREP FOR MRK (DBL ARROW)	EA	35.000		35.000	
	678-6012	PAV SURF PREP FOR MRK (UTURN ARR)	EA	7.000		7.000	
	678-6016	PAV SURF PREP FOR MRK (WORD)	EA	189.000		189.000	
	678-6020	PAV SURF PREP FOR MRK (RR XING)	EA	4.000		4.000	
	678-6022	PAV SURF PREP FOR MRK (18")(YLD TRI)	EA	61.000		61.000	
	678-6023	PAV SURF PREP FOR MRK (36")(YLD TRI)	EA	144.000		144.000	
	6020-6004	MLTPLY PV MK W/WTY (W) (6") (SLD)	LF	156,253.000		156,253.000	
	6020-6005	MLTPLY PV MK W/WTY (W) (6") (BRK)	LF	138,340.000		138,340.000	
	6020-6006	MLTPLY PV MK W/WTY (W) (6") (DOT)	LF	2,749.000		2,749.000	
	6020-6007	MLTPLY PV MK W/WTY (W) (8") (SLD)	LF	93,168.000		93,168.000	
	6020-6008	MLTPLY PV MK W/WTY (W) (12") (SLD)	LF	11,793.000		11,793.000	
	6020-6010	MLTPLY PV MK W/WTY (W) (24") (SLD)	LF	27,970.000		27,970.000	
	6020-6014	MLTPLY PV MK W/WTY (Y) (6") (SLD)	LF	41,454.000		41,454.000	
	6020-6017	MLTPLY PV MK W/WTY (Y) (8") (SLD)	LF	2,669.000		2,669.000	
	6020-6019	MLTPLY PV MK W/WTY (Y) (12") (SLD)	LF	934.000		934.000	
	6020-6020	MLTPLY PV MK W/WTY (Y) (24") (SLD)	LF	1,809.000		1,809.000	
	6020-6022	MLTPLY PV MK W/WTY (BLK) (6") (BRK)	LF	119,870.000		119,870.000	
	6020-6029	MLTPLY PV MK W/WTY (W)(8")(DOT)	LF	204.000		204.000	
	6185-6005	TMA (MOBILE OPERATION)	DAY	281.000		281.000	
	08	CONTRACTOR FORCE ACCOUNT EROSION CONTROL MAINTENANCE (NON-PARTICIPATING)	LS	1.000		1.000	

TxDOTCONNECT

DISTRICT	COUNTY	CCSJ	SHEET
Houston	Harris	0912-00-710	4A



CONTROLLING PROJECT ID 0912-00-710

DISTRICT Houston HIGHWAY Various

Estimate

COUNTY Harris


Qua tity Sheet

		CONTROL SECTI	ON JOB	0912-0	0-710		
		PRO	JECT ID	A0019	7984		
		c	OUNTY	Har	ris	TOTAL EST.	TOTAL FINAL
		HI	GHWAY	Vari	ous		
ALT	BID CODE	DESCRIPTION	UNIT	EST.	FINAL		
	08	CONTRACTOR FORCE ACCOUNT RAILROAD FLAGGING (NON-PARTICIPATING)	LS	1.000		1.000	
		CONTRACTOR FORCE ACCOUNT SAFETY CONTINGENCY (NON-PARTICIPATING)	LS	1.000		1.000	
		CONTRACTOR FORCE ACCOUNT LAW ENFORCEMENT (NON-PARTICIPATING)	LS	1.000		1.000	



DISTRICT	COUNTY	CCSJ	SHEET
Houston	Harris	0912-00-710	4B

		0500-6001	0502-6001		0666	REFL PAV MRK	ΤΥ Ι
ROADWAY	LIMITS	MOBILIZATION	BARRICADES, SIGNS AND TRAFFIC HANDLING	-6036 (W) 8"(SLD) (100MIL)	-6048 (W) 24"(SLD) (100MIL)	-6054 (W) (ARROW) (100MIL)	-6078 (W) (WORD) (100M1L)
		LS	МО	LF	LF	EA	EA
FM 762	1.542 MI. S. OF BRIDLEWOOD DR. TO FM 1462			522	332	4	4
FM 1093	SH 99 TO HARRIS COUNTY LINE - FRTG RDS						
FM 1489	US 90 TO FORT BEND COUNTY LINE				92		
FM 1489	WALLER COUNTY LINE TO FM 1093				70		2
FM 1489	FM 1093 TO FM 1952			250	168	3	3
FM 1994	SH 36 TO FM 361				93		
FM 1994	FM 361 TO FM 762			400	36	3	3
FM 2759	FM 762 TO THOMPSONS			3,820	275	14	16
IH 10	WALLER C/L TO HARRIS C/L - MAINLANES						
SH 6	MISSOURI CITY TO BRAZORIA COUNTY LINE						
55 10	US 59 TO SH 36 SOUTH			10,515	7,996	72	62
SS 529	US 59 TO W. OF US 90A (ASPHALT)			810	97	6	6
UA 90	SH 6 TO HARRIS COUNTY LINE						
	QUANTITY	1	8	16,317	9,159	102	96

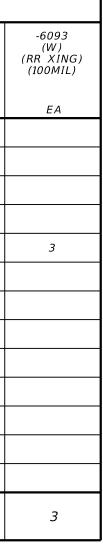

	SHEET 1 OF 10						
®	CONT	SECT	JOB	1	HIGHWAY		
	0912	00	710		VARIOUS		
©2023 Texas Department	DIST		COUNTY		SHEET NO.		
of Transportation	HOU		HARRIS		5		

		066	6 RE PV MRK T	ΓΥ Ι	0666-6212		0666 PAVEM	IENT SEALER	
ROADWAY	LIMITS	-6102 (W) 36"(YLD TRI) (100MIL)	-6147 (Y) 24"(SLD) (100MIL)	-6162 (BLACK) 6"(SHADOW) (100MIL)	REF PAV MRK TY II (Y)12" (SLD)	-6225 6"	-6226 8"	-6230 24"	-6231 (ARROW)
		EA	LF	LF	LF	LF	LF	LF	EA
FM 762	1.542 MI. S. OF BRIDLEWOOD DR. TO FM 1462	6				215,069	522	332	4
FM 1093	SH 99 TO HARRIS COUNTY LINE - FRTG RDS								
FM 1489	US 90 TO FORT BEND COUNTY LINE								
FM 1489	WALLER COUNTY LINE TO FM 1093					44,810		70	
FM 1489	FM 1093 TO FM 1952								
FM 1994	SH 36 TO FM 361								
FM 1994	FM 361 TO FM 762								
FM 2759	FM 762 TO THOMPSONS								
IH 10	WALLER C/L TO HARRIS C/L - MAINLANES								
SH 6	MISSOURI CITY TO BRAZORIA COUNTY LINE				56,924				
SS 10	US 59 TO SH 36 SOUTH		11,109	11,900					
SS 529	US 59 TO W. OF US 90A (ASPHALT)					43,296	810	97	6
UA 90	SH 6 TO HARRIS COUNTY LINE				17,126				
	QUANTITY	6	11,109	11,900	74,140	303,175	1,332	499	10

		S	HEET 2 OF 1	0	
®	CONT	SECT	JOB	HI	GHWAY
	0912	00	710	VA	RIOUS
©2023 Texas Department	DIST		COUNTY	5	HEET NO.
Department of Transportation	HOU		HARRIS		6

		0666 PAVE	MENT SEALER		0666 RE PM W	/RET REQ TY I	
ROADWAY	LIMITS	-6232 (WORD)	-6243 (YLD TRI)	-6306 (W) 6"(BRK) (100MIL)	-6309 (W) 6"(SLD) (100MIL)	-6318 (Y) 6"(BRK) (100MIL)	-6321 (Y) 6"(SLD) (100MIL)
		EA	EA	LF	LF	LF	LF
FM 762	1.542 MI. S. OF BRIDLEWOOD DR. TO FM 1462	4	6		55,017	12,315	55,966
FM 1093	SH 99 TO HARRIS COUNTY LINE - FRTG RDS						
FM 1489	US 90 TO FORT BEND COUNTY LINE				55,580	3,982	28,888
FM 1489	WALLER COUNTY LINE TO FM 1093	2			37,270	4,320	3,220
FM 1489	FM 1093 TO FM 1952						
FM 1994	SH 36 TO FM 361						
FM 1994	FM 361 TO FM 762						
FM 2759	FM 762 TO THOMPSONS			76,716	7,050		25,529
IH 10	WALLER C/L TO HARRIS C/L - MAINLANES						
SH 6	MISSOURI CITY TO BRAZORIA COUNTY LINE						
55 10	US 59 TO SH 36 SOUTH			11,900			
55 529	US 59 TO W. OF US 90A (ASPHALT)	6		26,572			
UA 90	SH 6 TO HARRIS COUNTY LINE						
	QUANTITY	12	6	115,188	154,917	20,617	113,603

0666-6343
REF PROF PAV MRK TY I (W)6"(SLD) (100MIL) LF
91,771
82,710
41,276
39,710
51,959
307,426



	SHEET 3 OF 10							
®	CONT	SECT	JOB	1	HIGHWAY			
	0912	00	710		VARIOUS			
©2023 Texas Department	DIST		COUNTY		SHEET NO.			
of Transportation	HOU		HARRIS		7			

		0666-6346	0666-6347	0668-6010		к тү с			
ROADWAY	ROADWAY LIMITS	PAV MRK TY I (Y)6"(BRK) (REF PROF PAV MRK TY I (Y)6"(SLD) (100MIL)	PREFAB PAV MRK TY B (W)6"(BRK) CNTST	-6077 (W) (ARROW)	-6078 (W) (DBL ARROW)	-6080 (W) (UTURN ARROW)	-6084 (W) (NUMBER)	-6085 (W) (WORD)
		LF	LF	LF	EA	EA	EA	EA	EA
FM 762	1.542 MI. S. OF BRIDLEWOOD DR. TO FM 1462								
FM 1093	SH 99 TO HARRIS COUNTY LINE - FRTG RDS				38	13	2		40
FM 1489	US 90 TO FORT BEND COUNTY LINE								
FM 1489	WALLER COUNTY LINE TO FM 1093								
FM 1489	FM 1093 TO FM 1952	8,810	24,724						
FM 1994	SH 36 TO FM 361	5,110	3,053						
FM 1994	FM 361 TO FM 762	4,320	8,145						
FM 2759	FM 762 TO THOMPSONS		5,429						
IH 10	WALLER C/L TO HARRIS C/L - MAINLANES			14,040				3	
SH 6	MISSOURI CITY TO BRAZORIA COUNTY LINE				277	10	2		258
SS 10	US 59 TO SH 36 SOUTH	820	54,922						
SS 529	US 59 TO W. OF US 90A (ASPHALT)	2,310	14,414						
UA 90	SH 6 TO HARRIS COUNTY LINE				159	22	5		137
	QUANTITY	21,370	110,687	14,040	474	45	9	3	435



	SHEET 4 OF 10								
®	CONT	SECT	JOB	HIGHWA	Y				
	0912	00	001	VARIOUS	5				
©2023 Texas Department	DIST		COUNTY	SHEET	NO.				
of Transportation	HOU		HARRIS	8					

		0668 H	PREFAB PAV MRI	к тү с		0672 REFL PAV MRKR				
ROADWAY	LIMITS	-6089 (W) (RR XING)	-6091 (W) (18") (YLD TRI)	-6092 (W) (36") (YLD TRI)	-6006 TY I-A	-6007 TY I-C	-6009 TY II-A-A			
		EA	EA	EA	EA	EA	EA			
FM 762	1.542 MI. S. OF BRIDLEWOOD DR. TO FM 1462					30	1,634			
FM 1093	SH 99 TO HARRIS COUNTY LINE - FRTG RDS			53						
FM 1489	US 90 TO FORT BEND COUNTY LINE						562			
FM 1489	WALLER COUNTY LINE TO FM 1093						257			
FM 1489	FM 1093 TO FM 1952					13	1,505			
FM 1994	SH 36 TO FM 361						295			
FM 1994	FM 361 TO FM 762					22	519			
FM 2759	FM 762 TO THOMPSONS					195	1,424			
IH 10	WALLER C/L TO HARRIS C/L - MAINLANES				48					
SH 6	MISSOURI CITY TO BRAZORIA COUNTY LINE	4	12	18		37	41	Γ		
55 10	US 59 TO SH 36 SOUTH					125	489			
55 529	US 59 TO W. OF US 90A (ASPHALT)					40	591	Γ		
UA 90	SH 6 TO HARRIS COUNTY LINE	4	61	85	67	66	36			
	QUANTITY	8	73	156	115	528	7,363			

-6010 TY II-C-R
 EA
1,405
958
5,524
1,007
5,098
13,992



SHEET 5 OF 10								
®	CONT	SECT	JOB		HIGHWAY			
	0912	00	710		VARIOUS			
©2023 Texas Department	DIST		COUNTY		SHEET NO.			
of Transportation	HOU		HARRIS		9			

				0677 ELI	M EXT PAV MRK	& MRKS	
ROADWAY	LIMITS	-6001 (4")	-6002 (6")	-6003 (8")	-6005 (12")	-6007 (24")	-6008 (ARROW)
		LF	LF	LF	LF	LF	EA
FM 762	1.542 MI. S. OF BRIDLEWOOD DR. TO FM 1462	215,069		522		332	4
FM 1093	SH 99 TO HARRIS COUNTY LINE - FRTG RDS		20,340	10,200	3,151	1,874	38
FM 1489	US 90 TO FORT BEND COUNTY LINE						
FM 1489	WALLER COUNTY LINE TO FM 1093	44,810				70	
FM 1489	FM 1093 TO FM 1952						
FM 1994	SH 36 TO FM 361						
FM 1994	FM 361 TO FM 762						
FM 2759	FM 762 TO THOMPSONS						
IH 10	WALLER C/L TO HARRIS C/L - MAINLANES						
SH 6	MISSOURI CITY TO BRAZORIA COUNTY LINE				6,228	3,306	
55 10	US 59 TO SH 36 SOUTH						
55 529	US 59 TO W. OF US 90A (ASPHALT)		43,296	810		97	6
UA 90	SH 6 TO HARRIS COUNTY LINE		83,331	27,781	21,204	7,337	159
	QUANTITY	259,879	146,967	39,313	30,583	13,016	207






,	SHEET 6 OF 10								
®	CONT	SECT	JOB		HIGHWAY				
	06912	00	710		VARIOUS				
©2023 Texas Department	DIST		COUNTY		SHEET NO.				
of Transportation	HOU		HARRIS		10				

			0677 ELI	0678 PAV SURF PREP FOR MRK				
ROADWAY	ROADWAY LIMITS	-6012 (WORD)	-6016 (RR XING)	-6018 (18") (YLD TRI)	-6019 (36") (YLD TRI)	-6036 (UTURN ARROW)	-6002 (6")	-6004 (8")
		EA	EA	EA	EA	EA	LF	LF
FM 762	1.542 MI. S. OF BRIDLEWOOD DR. TO FM 1462	4			6		215,069	522
FM 1093	SH 99 TO HARRIS COUNTY LINE - FRTG RDS	40			53	2	36,590	10,200
FM 1489	US 90 TO FORT BEND COUNTY LINE							
FM 1489	WALLER COUNTY LINE TO FM 1093	2					44,810	
FM 1489	FM 1093 TO FM 1952							
FM 1994	SH 36 TO FM 361							
FM 1994	FM 361 TO FM 762							
FM 2759	FM 762 TO THOMPSONS							
IH 10	WALLER C/L TO HARRIS C/L - MAINLANES							
SH 6	MISSOURI CITY TO BRAZORIA COUNTY LINE							
55 10	US 59 TO SH 36 SOUTH							
SS 529	US 59 TO W. OF US 90A (ASPHALT)	6					43,296	810
UA 90	SH 6 TO HARRIS COUNTY LINE	137	4	61	85	5	83,331	27,781
	QUANTITY	189	4	61	144	7	423,096	39,313



SHEET 7 OF 10								
®	CONT	SECT	JOB		HIGHWAY			
	0912	00	710		VARIOUS			
©2023 Texas Department	DIST		COUNTY		SHEET NO.			
of Transportation	HOU		HARRIS		11			

				0678 P	AV SURF PREP F	OR MRK	
ROADWAY	LIMITS	-6006 (12")	-6008 (24")	-6009 (ARROW)	-6010 (DBL ARROW)	-6012 (UTURN ARR)	-6016 (WORD)
		LF	LF	EA	EA	EA	EA
FM 762	1.542 MI. S. OF BRIDLEWOOD DR. TO FM 1462		332	4			4
FM 1093	SH 99 TO HARRIS COUNTY LINE - FRTG RDS		3,230	38	13	2	40
FM 1489	US 90 TO FORT BEND COUNTY LINE						
FM 1489	WALLER COUNTY LINE TO FM 1093		70				2
FM 1489	FM 1093 TO FM 1952						
FM 1994	SH 36 TO FM 361						
FM 1994	FM 361 TO FM 762						
FM 2759	FM 762 TO THOMPSONS						
IH 10	WALLER C/L TO HARRIS C/L - MAINLANES						
SH 6	MISSOURI CITY TO BRAZORIA COUNTY LINE						
55 10	US 59 TO SH 36 SOUTH						
SS 529	US 59 TO W. OF US 90A (ASPHALT)		97	6			6
UA 90	SH 6 TO HARRIS COUNTY LINE	10,493	12,499	159	22	5	137
	QUANTITY	10,493	16,228	207	35	7	189

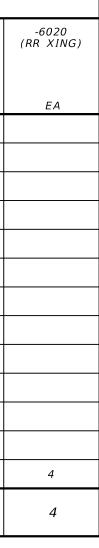

SHEET 8 OF 10								
®	CONT	SECT	JOB		HIGHWAY			
	0912	00	710		VARIOUS			
©2023 Texas Department	DIST		COUNTY		SHEET NO.			
of Transportation	HOU		HARRIS		12			

		0678 PAV SURF	PREP FOR MRK		6020 I	ALTPLY PV MK I	N/WTY	
ROADWAY	LIMITS	-6022 (18") (YLD TRI)	-6023 (36") (YLD TRI)	-6004 (W)(6") (SLD)	-6005 (W)(6") (BRK)	-6006 (W)(6") (DOT)	-6007 (W)(8") (SLD)	-6008 (W)(12") (SLD)
		EA	EA	LF	LF	LF	LF	LF
FM 762	1.542 MI. S. OF BRIDLEWOOD DR. TO FM 1462		6					
FM 1093	SH 99 TO HARRIS COUNTY LINE - FRTG RDS		53	1,756	16,250	308	10,002	
FM 1489	US 90 TO FORT BEND COUNTY LINE							
FM 1489	WALLER COUNTY LINE TO FM 1093							
FM 1489	FM 1093 TO FM 1952							
FM 1994	SH 36 TO FM 361							
FM 1994	FM 361 TO FM 762							
FM 2759	FM 762 TO THOMPSONS							
IH 10	WALLER C/L TO HARRIS C/L - MAINLANES			29,381	14,040	213	5,116	1,300
SH 6	MISSOURI CITY TO BRAZORIA COUNTY LINE			103,721	52,300	1,170	51,756	
<i>SS 10</i>	US 59 TO SH 36 SOUTH							
SS 529	US 59 TO W. OF US 90A (ASPHALT)							
UA 90	SH 6 TO HARRIS COUNTY LINE	61	85	21,395	55,750	1,058	26,294	10,493
	QUANTITY	61	144	156,253	138,340	2,749	93,168	11,793



	SHEET 9 OF 10							
®	CONT	SECT	JOB	HIGHWAY				
	0912	00	710	VARIOUS				
©2023 Texas Department	DIST		SHEET NO					
of Transportation	НОИ		13					

		6020 MLTPLY PV MK W/WTY							6185-6005
ROADWAY	LIMITS	-6010 (W)(24") (SLD)	-6014 (Y)(6") (SLD)	-6017 (Y)(8") (SLD)	-6019 (Y)(12") (SLD)	-6020 (Y)24") (SLD)	6022 (BLK)(6") (BRK)	6029 (W)(8") (DOT)	TMA (MOBILE OPERATION)
		LF	LF	LF	LF	LF	LF	LF	DAY
FM 762	1.542 MI. S. OF BRIDLEWOOD DR. TO FM 1462								34
FM 1093	SH 99 TO HARRIS COUNTY LINE - FRTG RDS	3,175	2,026	198		55	16,250		10
FM 1489	US 90 TO FORT BEND COUNTY LINE								6
FM 1489	WALLER COUNTY LINE TO FM 1093								8
FM 1489	FM 1093 TO FM 1952								8
FM 1994	SH 36 TO FM 361								4
FM 1994	FM 361 TO FM 762								6
FM 2759	FM 762 TO THOMPSONS								8
IH 10	WALLER C/L TO HARRIS C/L - MAINLANES		30,580	984					27
SH 6	MISSOURI CITY TO BRAZORIA COUNTY LINE	12,599	2,662		934	689	47,920	204	87
SS 10	US 59 TO SH 36 SOUTH					493			15
SS 529	US 59 TO W. OF US 90A (ASPHALT)								8
UA 90	SH 6 TO HARRIS COUNTY LINE	12,196	6,186	1,487		651	55,700		60
	QUANTITY	27,970	41,454	2,669	934	1,809	119,870	204	281

SHEET 10 OF 10								
®	CONT	SECT	JOB		HIGHWAY			
©2023 Texas Department of Transportation	0912	00	710	VARIOUS				
	DIST		SHEET NO.					
	HOU		14					

BARRICADE AND CONSTRUCTION (BC) STANDARD SHEETS GENERAL NOTES:

- The Barricade and Construction Standard Sheets (BC sheets) are intended 1. to show typical examples for placement of temporary traffic control devices, construction pavement markings, and typical work zone signs. The information contained in these sheets meet or exceed the requirements shown in the "Texas Manual on Uniform Traffic Control Devices" (TMUTCD).
- The development and design of the Traffic Control Plan (TCP) is the 2. responsibility of the Engineer.
- The Contractor may propose changes to the TCP that are signed and sealed by a licensed professional engineer for approval. The Engineer may develop, sign and seal Contractor proposed changes.
- 4. The Contractor is responsible for installing and maintaining the traffic control devices as shown in the plans. The Contractor may not move or change the approximate location of any device without the approval of the Engineer.
- Geometric design of lane shifts and detours should, when possible, meet the 5. applicable design criteria contained in manuals such as the American Association of State Highway and Transportation Officials (AASHTO), "A Policy on Geometric Design of Highways and Streets," the TxDOT "Roadway Design Manual" or engineering judgment.
- When projects abut, the Engineer(s) may omit the END ROAD WORK, TRAFFIC FINES DOUBLE, and other advance warning signs if the signing would be redundant and the work areas appear continuous to the motorists. If the adjacent project is completed first, the Contractor shall erect the necessary warning signs as shown on these sheets, the TCP sheets or as directed by the Engineer. The BEGIN ROAD WORK NEXT X MILES sign shall be revised to show appropriate work zone distance.
- The Engineer may require duplicate worning signs on the median side of divided highways where median width will permit and traffic volumes justify the signing.
- 8. All signs shall be constructed in accordance with the details found in the "Standard Highway Sign Designs for Texas," latest edition. Sign details not shown in this manual shall be shown in the plans or the Engineer shall provide a detail to the Contractor before the sign is manufactured.
- The temporary traffic control devices shown in the illustrations of the 9. BC sheets are examples. As necessary, the Engineer will determine the most appropriate traffic control devices to be used.
- 10. Where highway construction or maintenance work is being undertaken, other than mobile operations as defined by the Texas Manual on Uniform Traffic Control Devices, CSJ limit signs are required. CSJ limit signs are shown ON BC(2). THE OBEY WARNING SIGNS STATE LAW sign, STAY ALERT TALK OR TEXT LATER and the WORK ZONE TRAFFIC FINES DOUBLE sign with plaque shall be erected in advance of the CSJ limits. The BEGIN ROAD WORK NEXT X MILES. CONTRACTOR and END ROAD WORK signs shall be erected at or near the CSJ limits. For mobile operations, CSJ limit signs are not required.
- 11. Traffic control devices should be in place only while work is actually in progress or a definite need exists.
- 12. The Engineer has the final decision on the location of all traffic control devices.
- 13. Inactive equipment and work vehicles, including workers' private vehicles must be parked away from travel lanes. They should be as close to the right-of-way line as possible, or located behind a barrier or guardrail, or as approved by the Engineer.


WORKER SAFETY NOTES:


- 1. Workers on foot who are exposed to traffic or to construction equipment within the right-of-way shall wear high-visibility safety apparel meeting the requirements of ISEA "American National Standard for High-Visibility Apparel." or equivalent revisions, and labeled as ANSI 107-2004 standard performance for Class 2 or 3 risk exposure. Class 3 garments should be considered for high traffic volume work areas or night time work.
- 2. Except in emergency situations, flagger stations shall be illuminated when flagging is used at night.


COMPLIANT WORKZONE TRAFFIC CONTROL DEVICES

- 1. Only pre-qualified products shall be used. The "Compliant Work Zone Traffic Control Devices List" (CWZTCD) describes pre-qualified products and their sources.
- 2. Work zone traffic control devices shall be compliant with the Manual for Assessing safety Hardware (MASH).

THE DOCUMENTS BELOW CAN BE FOUND ON-LINE AT http://www.txdot.gov					
COMPLIANT WORK ZONE TRAFFIC CONTROL DEVICES LIST (CWZTCD)					
DEPARTMENTAL MATERIAL SPECIFICATIONS (DMS)					
MATERIAL PRODUCER LIST (MPL)					
ROADWAY DESIGN MANUAL - SEE "MANUALS (ONLINE MANUALS)"					
STANDARD HIGHWAY SIGN DESIGNS FOR TEXAS (SHSD)					
TEXAS MANUAL ON UNIFORM TRAFFIC CONTROL DEVICES (TMUTCD)					
TRAFFIC ENGINEERING STANDARD SHEETS					

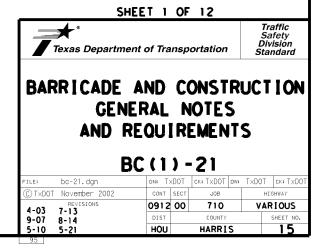

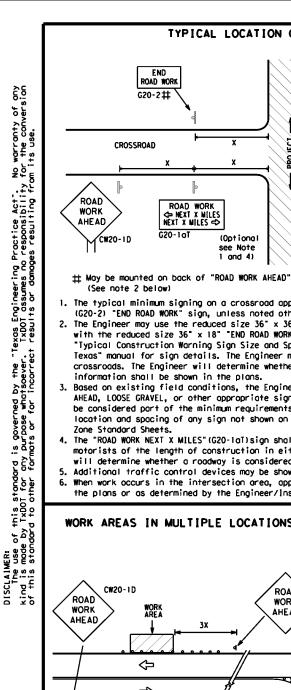

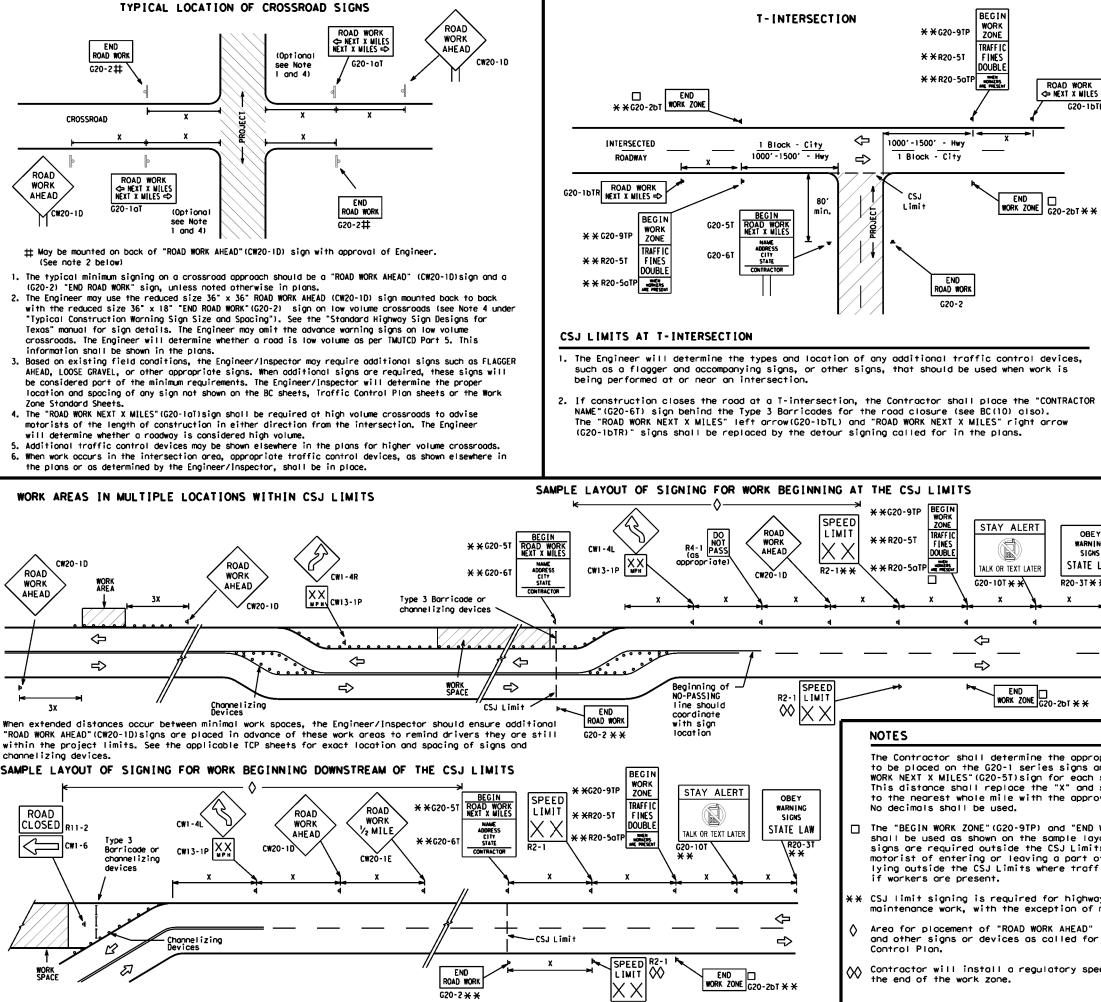

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	CW22	48" × 48"	48" x 48"	30	120			
	CW23			35	160			
	CW25			40	240			
		+		45	320			
	CW1, CW2,			50	400			
×	CW7, CW8,	36" × 36"	48" × 48"	55	500 ²			
	CW9, CW11, CW14							
	CWI4			60	600 ²			
	CW3, CW4,			65	700 2			
	CW5, CW6,	48" × 48"	48" × 48"	70	800 ²			
	CW8-3,			75	900 ²			
	CW10, CW12			80	1000 ²			
				/ *	* 3			
R VING XNS L LAW X	 G. Only diamond shaped warning sign sizes are indicated. AW 6. See sign size listing in "TMUTCD", Sign Appendix or the "Standard Highway 							
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		00	O Channeliz	ing Devices				
		-	Sign					
	te distance	x	Warning S Spacing c TMUTCD fo	al Construc ign Size and hart or the r sign equirements	d			
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	ZONE" (G20-2bT)	-	-	-	Standard			
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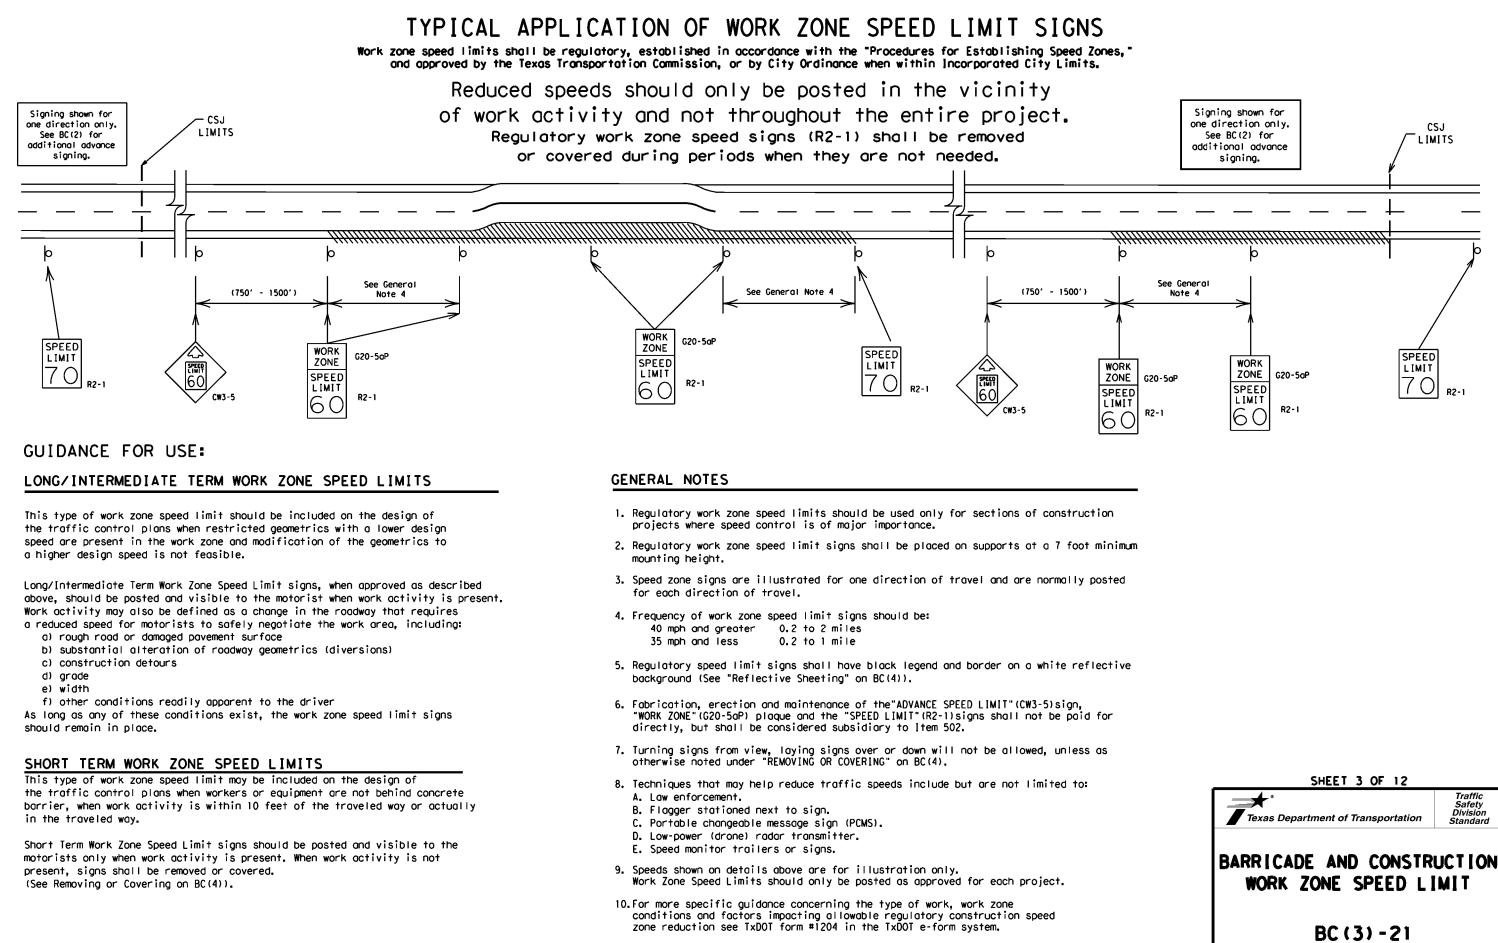
TYPICAL CONSTRUCTION WARNING SIGN SIZE AND SPACING 15,6

SIZE

Sign Number or Series	Conventional Road	Expressway/ Freeway
CW20 ⁴ CW21 CW22 CW23 CW25	48" × 48"	48" × 48"
CW1, CW2, CW7, CW8, CW9, CW11, CW14	36" × 36"	48" × 48"
CW3, CW4, CW5, CW6, CW8-3, CW10, CW12	48" × 48"	48" × 48"


Posted Speed	Sign∆ Spacing "X"
MPH	Feet (Apprx.)
30	120
35	160
40	240
45	320
50	400
55	500 ²
60	600 ²
65	700 ²
70	800 ²
75	900 ²
80	1000 ²
*	* 3

SPACING



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GENERAL NOTES FOR WORK ZONE SIGNS

- Contractor shall install and maintain signs in a straight and plumb condition and/or as directed by the Engineer.
- Wooden sign posts shall be painted white. Barricades shall NOT be used as sign supports
- guide the traveling public safely through the work zone.
- the Inspector's TxDOT diary and having both the Inspector and Contractor initial and date the agreed upon changes.
- the Engineer can verify the correct procedures are being followed.
- domoged or morred reflective sheeting as directed by the Engineer/Inspector.
- for identification shall be 1 inch.
- The Contractor shall replace damaged wood posts. New or damaged wood sign posts shall not be spliced.

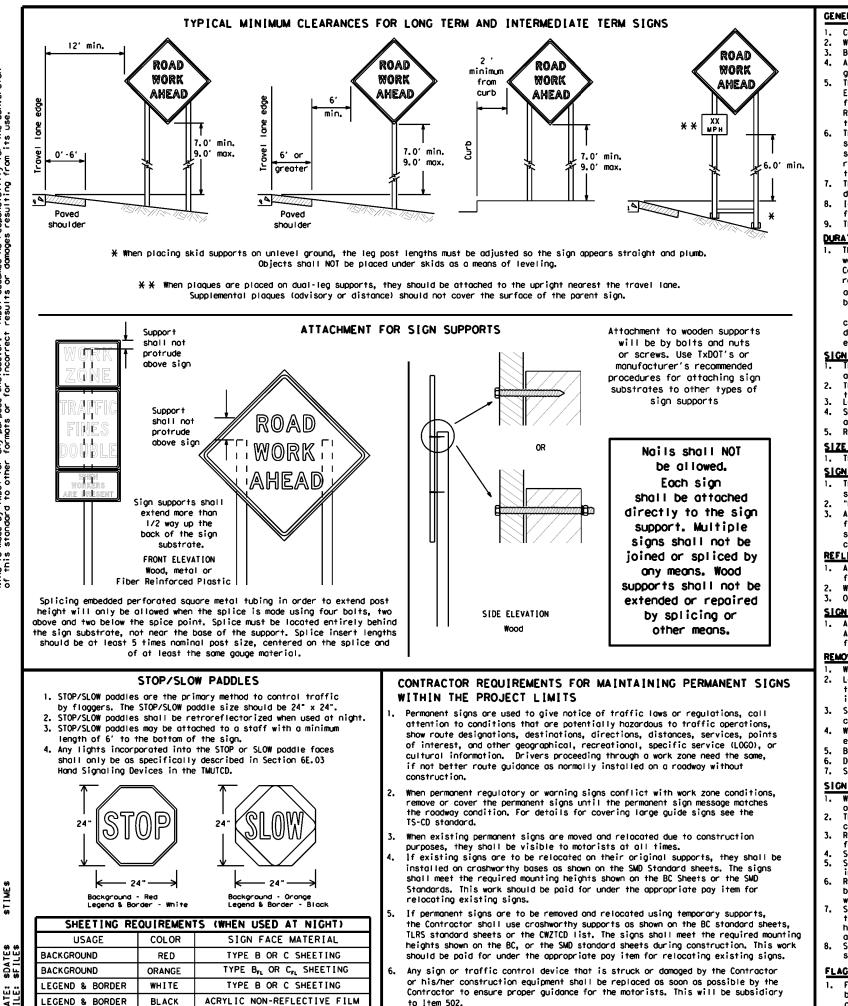DURATION OF WORK (as defined by the "Texas Manual on Uniform Traffic Control Devices" Part 6)

- The types of sign supports, sign mounting height, the size of signs, and the type of sign substrates can vary based on the type of reaard to crashworthiness and duration of work requirements.
 - a. Long-term stationary work that occupies a location more than 3 days.
 - more than one hour. c.
 - Short, duration work that occupies a location up to 1 hour. d.
- Mobile work that moves continuously or intermittently (stopping for up to approximately 15 minutes.) e.

SIGN MOUNTING HEIGHT

- as shown for supplemental plaques mounted below other signs.
- the ground. Long-term/Intermediate-term Signs may be used in lieu of Short-term/Short Duration signing.
- Short-term/Short Duration signs shall be used only during daylight and shall be removed at the end of the workday or raised to
- appropriate Long-term/intermediate sign height.

SIZE OF SIGNS

The Contractor shall furnish the sign sizes shown on BC (2) unless otherwise shown in the plans or as directed by the Engineer.

SIGN SUBSTRATES

- "Mesh" type materials are NOT an approved sign substrate, regardless of the tightness of the weave. centers. The Engineer may approve other methods of splicing the sign face.

REFLECTIVE SHEETING

- 1. All signs shall be retroreflective and constructed of sheeting meeting the color and retro-reflectivity requirements of DMS-8300
- for rigid signs or DMS-8310 for roll-up signs. The web address for DMS specifications is shown on BC(1).
- White sheeting, meeting the requirements of DWS-8300 Type A, shall be used for signs with a white background.

SIGN LETTERS

1. All sign letters and numbers shall be clear, and open rounded type uppercase alphabet letters as approved by the Federal Highway first class workmanship in accordance with Department Standards and Specifications.

REMOVING OR COVERING

- When sign messages may be confusing or do not apply, the signs shall be removed or completely covered.
- intersections where the sign may be seen from approaching traffic.
- covered when not required.
- Burlop shall NOT be used to cover signs.
- Duct tape or other adhesive material shall NOT be affixed to a sign face. Signs and anchor stubs shall be removed and holes backfilled upon completion of work.

SIGN SUPPORT WEIGHTS

- Where sign supports require the use of weights to keep from turning over, the use of sandbags with dry, cohesionless sand should be used.
 The sandbags will be tied shut to keep the sand from spilling and to maintain a
- constant weight.
- Rock, concrete, iron, steel or other solid objects shall not be permitted for use as sign support weights. Sandbags should weigh a minimum of 35 lbs and a maximum of 50 lbs.
- Sandbags shall be made of a durable material that tears upon vehicular
- impact. Rubber (such as tire inner tubes) shall NOT be used. Rubber ballasts designed for channelizing devices should not be used for ballast on portable sign supports. Sign supports designed and manufactured with rubber bases may be used when shown on the CWZICD list.
- Sandbags shall only be placed along or laid over the base supports of the traffic control device and shall not be suspended above ground level or hung with rope, wire, chains or other fasteners. Sandbags shall be placed along the length of the skids to weigh down the sign support.
- Sandbags shall NOT be placed under the skid and shall not be used to level sign supports placed on slopes.

FLAGS ON SIGNS

1. Flogs may be used to draw attention to warning signs. When used, the flag shall be 16 inches square or larger and shall be orange or fluorescent red-orange in color. Flags shall not be allowed to cover any portion of the sign face.

All signs shall be installed in accordance with the plans or as directed by the Engineer. Signs shall be used to regulate, warn, and

The Contractor may furnish either the sign design shown in the plans or in the "Standard Highway Sign Designs for Texas" (SHSD). The Engineer/Inspector may require the Contractor to furnish other work zone signs that are shown in the TMUTCD but may have been omitted from the plans. Any variation in the plans shall be documented by written agreement between the Engineer and the Contractor's Responsible Person. All changes must be documented in writing before being implemented. This can include documenting the changes in

The Contractor shall furnish sign supports listed in the "Compliant Work Zone Traffic Control Device List" (CWZICD) for small roadside signs. Supports for temporary large roadside signs shall meet the requirements detailed on the Temporary Large Roadside Signs (TLRS) standard sheets. The Contractor shall install the sign support in accordance with the manufacturer's recommendations. If there is a question regarding installation procedures, the Contractor shall furnish the Engineer a copy of the manufacturer's installation recommendations so

The Contractor is responsible for installing signs on approved supports and replacing signs with damaged or cracked substrates and/or

Identification morkings may be shown only on the back of the sign substrate. The maximum height of letters and/or company logos used

work being performed. The Engineer is responsible for selecting the appropriate size sign for the type of work being performed. The Contractor is responsible for ensuring the sign support, sign mounting height and substrate meets manufacturer's recommendations in

Intermediate-term stationary - work that occupies a location more than one daylight period up to 3 days, or nighttime work lasting

Short-term stationary - daytime work that occupies a location for more than 1 hour in a single daylight period.

The bottom of Long-term/intermediate-term signs shall be at least 7 feet, but not more than 9 feet, above the paved surface, except

The bottom of Short-term/Short Duration signs shall be a minimum of 1 foot above the pavement surface but no more than 2 feet above

Regulatory signs shall be mounted at least 7 feet, but not more than 9 feet, above the paved surface regardless of work duration.

The Contractor shall ensure the sign substrate is installed in accordance with the manufacturer's recommendations for the type of sign support that is being used. The CWZTCD lists each substrate that can be used on the different types and models of sign supports. All wooden individual sign panels fabricated from 2 or more pieces shall have one or more plywood cleat, 1/2" thick by 6" wide, fastened to the back of the sign and extending fully across the sign. The cleat shall be attached to the back of the sign using wood

screws that do not penetrate the face of the sign panel. The screws shall be placed on both sides of the splice and spaced at 6-

Orange sheeting, meeting the requirements of DMS-8300 Type B_{FL} or Type C_{FL}, shall be used for rigid signs with orange backgrounds.

Administration (FHWA) and as published in the Standard Highway Sign Design for Texas manual. Signs, letters and numbers shall be of

Long-term stationary or intermediate stationary signs installed on square metal tubing may be turned away from traffic 90 degrees when the sign message is not applicable. This technique may not be used for signs installed in the median of divided highways or near any

Signs installed on wooden skids shall not be turned at 90 degree angles to the roadway. These signs should be removed or completely

When signs are covered, the material used shall be opaque, such as heavy mil black plastic, or other materials which will cover the entire sign face and maintain their opaque properties under automobile headlights at night, without damaging the sign sheeting.


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Texas Department of Transportation

Traffic Safety Division Standard

BARRICADE AND CONSTRUCTION TEMPORARY SIGN NOTES

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WHEN NOT IN USE. REMOVE THE PCMS FROM THE RIGHT-OF-WAY OR PLACE THE PCMS BEHIND BARRIER OR GUARDRAIL WITH SIGN PANEL TURNED PARALLEL TO TRAFFIC

PORTABLE CHANGEABLE MESSAGE SIGNS

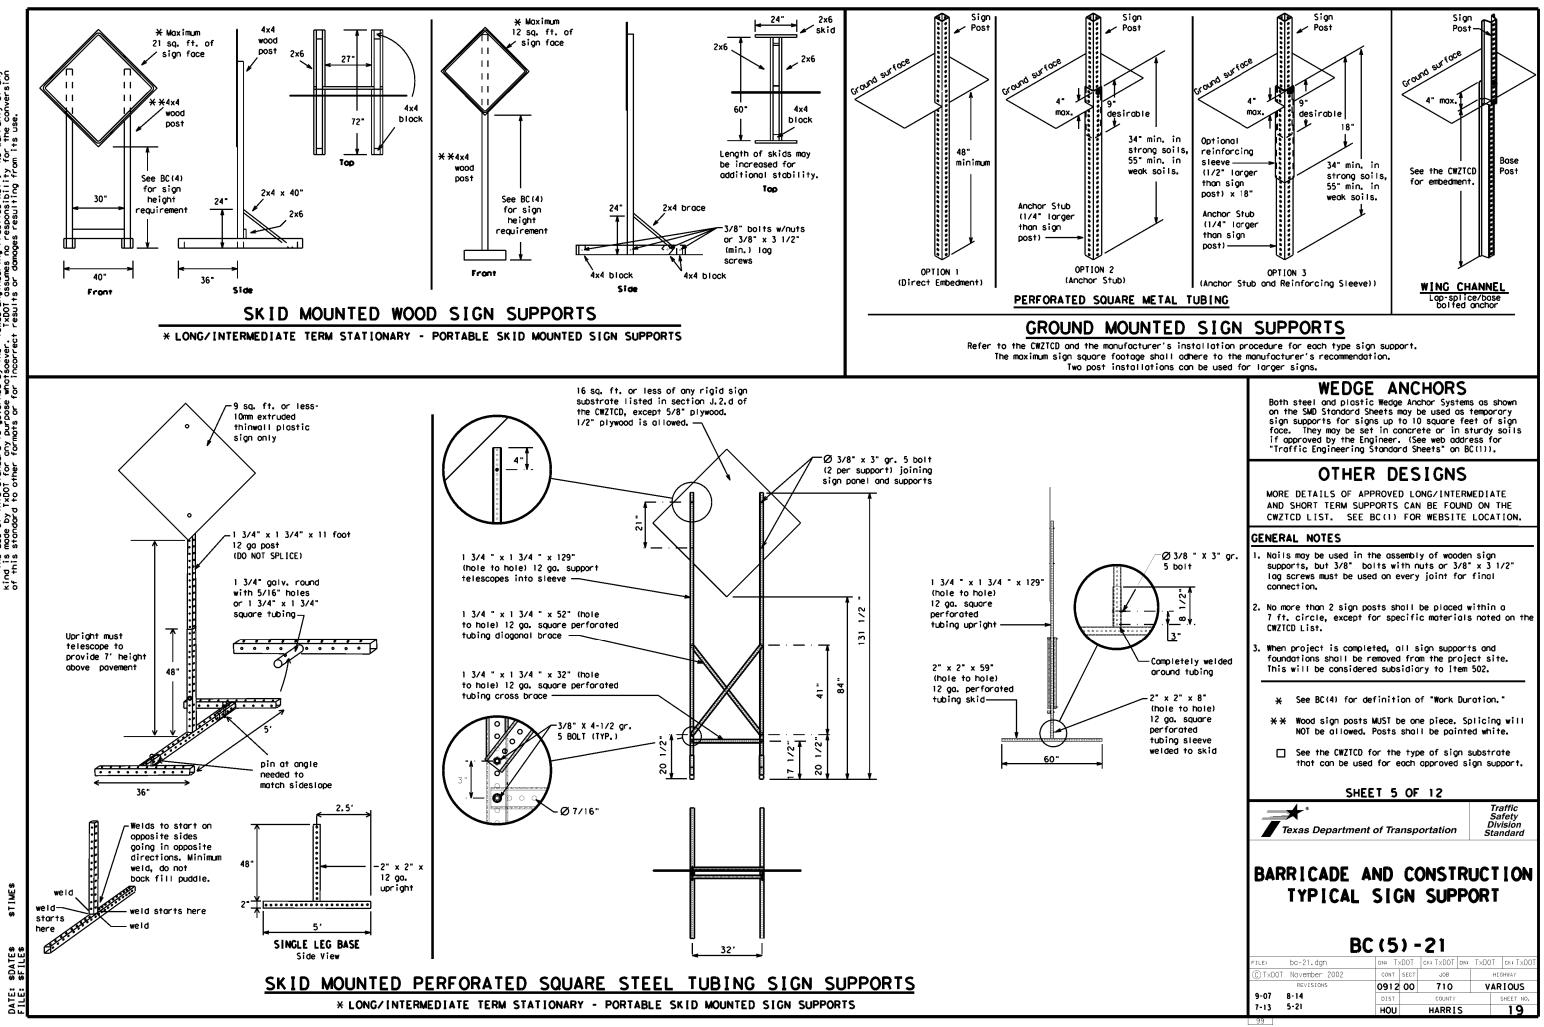- 1. The Engineer/Inspector shall approve all messages used on portable changeable message signs (PCMS).
- 2. Messages on PCMS should contain no more than 8 words (about four to eight characters per word), not including simple words such as "TO, FOR. " AT. " etc.
- Messages should consist of a single phase, or two phases that 3. alternate. Three-phase messages are not allowed. Each phase of the message should convey a single thought, and must be understood by itself.
- 4. Use the word "EXIT" to refer to an exit ramp on a freeway; i.e., "EXIT CLOSED." Do not use the term "RAMP."
- Always use the route or interstate designation (IH, US, SH, FM) 5. along with the number when referring to a roadway.
- When in use, the bottom of a stationary PCMS message panel should be a minimum 7 feet above the roadway, where possible.
- The message term "WEEKEND" should be used only if the work is to start on Saturday morning and end by Sunday evening at midnight. Actual days and hours of work should be displayed on the PCMS if work is to begin on Friday evening and/or continue into Monday morning.
- The Engineer/Inspector may select one of two options which are available for displaying a two-phase message on a PCMS. Each phase may be displayed for either four seconds each or for three seconds each.
- Do not "flash" messages or words included in a message. The message should be steady burn or continuous while displayed.
- 10. Do not present redundant information on a two-phase message; i.e., keeping two lines of the message the same and changing the third line. 11. Do not use the word "Danger" in message.
- 12. Do not display the message "LANES SHIFT LEFT" or "LANES SHIFT RIGHT" on a PCMS. Drivers do not understand the message.
- 13. Do not display messages that scroll horizontally or vertically across the face of the sign.
- 14. The following table lists abbreviated words and two-word phrases that are acceptable for use on a PCMS. Both words in a phrase must be displayed together. Words or phrases not on this list should not be abbreviated, unless shown in the TMUTCD.
- 15. PCMS character height should be at least 18 inches for trailer mounted units. They should be visible from at least 1/2 (.5) mile and the text should be legible from at least 600 feet at night and 800 feet in daylight. Truck mounted units must have a character height of 10 inches and must be legible from at least 400 feet.
- 16. Each line of text should be centered on the message board rather than left or right justified.
- 17. If disabled, the PCMS should default to an illegible display that will not alarm motorists and will only be used to alert workers that the PCMS has malfunctioned. A pattern such as a series of horizontal solid bars is appropriate.

WORD OR PHRASE	ABBREVIATION	WORD OR PHRASE	ABBREVIATION
Access Rood	ACCS RD	Major	MAJ
Alternate	ALT	Miles	MI
Avenue	AVE	Miles Per Hour	MPH
Best Route	BEST RTE	Minor	MNR
Boulevord	BLVD	Monday	MON
Bridge	BRDG	Normal	NORM
Cannot	CANT	North	N
Center	CTR	Nor thbound	(route) N
Construction Ahead	CONST AHD	Parking Road	PK ING RD
CROSSING	XING		
Detour Route	DETOUR RTE	Right Lane Saturday	RT LN SAT
Do Not	DONT	Service Road	SERV RD
East	E		SHLDR
Eastbound	(route) E	Shoulder	
Emergency	EMER	Slippery	SL IP S
Emergency Vehicle	EMER VEH	South	
Entrance, Enter	ENT	Southbound	(route) S
Express Lone	EXP LN	Speed	SPD
Expressway	EXPWY	Street	ST
XXXX Feet	XXXX FT	Sunday	SUN
Fog Ahead	FOG AHD	Telephone	PHONE
Freeway	FRWY, FWY	Temporory	TEMP
Freeway Blocked	FWY BLKD	Thursdoy	THURS
Friday	FRI	To Downtown	TO DWNTN
Hazardous Driving		Traffic	TRAF
Hazardous Material		Travelers	TRVLRS
High-Occupancy	HOV	Tuesday	TUES
Vehicle		Time Minutes	TIME MIN
Highway	HWY	Upper Level	UPR LEVEL
Hour (s)	HR. HRS	Vehicles (s)	VEH, VEHS
Information	INFO	Warning	WARN
It is	ITS	Wednesday	WED
Junction	JCT	Weight Limit	WT LIMIT
Left	LFT	West	W
Left Lane		Westbound	(route) 🕷
Lone Closed		Wet Povement	WET PVMT
Lower Level	LWR LEVEL	Will Not	WONT
Maintenance			
MUTHENUICE	100 A 111 I		

designation = IH-number, US-number, SH-number, FM-number

RECOMMENDED PHASES AND FORMATS FOR PCMS MESSAGES DURING ROADWORK ACTIVITIES (The Engineer may approve other messages not specifically covered here.)

MERGE

RIGHT

DETOUR

NEXT

X EXITS

USE

EXIT XXX

STAY ON

US XXX

SOUTH

TRUCKS

USE

US XXX N

WATCH

FOR

TRUCKS

EXPECT

DELAYS

REDUCE

SPEED

XXX FT

USE

OTHER

ROUTES

STAY ĪN

LANE

List

FORM

X LINES

RIGHT

USE

XXXXX

RD EXIT

USE EXIT

I-XX

NORTH

USE

I-XX F

TO I-XX N

WATCH

FOR

TRUCKS

EXPECT

DELAYS

PREPARE

то

STOP

END

SHOULDER

USE

WATCH

FOR

WORKERS

Phase 1: Condition Lists

Road/Lane/Ramp Closure List

		offici conditi
FREEWAY CLOSED X MILE	FRONTAGE ROAD CLOSED	ROADWORK XXX FT
ROAD CLOSED AT SH XXX	SHOULDER CLOSED XXX FT	FLAGGER XXXX FT
ROAD CLSD AT FM XXXX	RIGHT LN CLOSED XXX FT	RIGHT LN NARROWS XXXX FT
RIGHT X LANES CLOSED	RIGHT X LANES OPEN	MERGING TRAFFIC XXXX FT
CENTER LANE CLOSED	DAYTIME LANE CLOSURES	LOOSE GRAVEL XXXX FT
NIGHT LANE CLOSURES	I-XX SOUTH EXIT CLOSED	DETOUR X MILE
VARIOUS LANES CLOSED	EXIT XXX CLOSED X MILE	ROADWORK PAST SH XXXX
EXIT CLOSED	RIGHT LN TO BE CLOSED	BUMP XXXX FT
MALL DRIVEWAY CLOSED	X LANES CLOSED TUE - FRI	TRAFFIC SIGNAL XXXX FT
XXXXXXXX BL VD CLOSED	★ LANES SHIFT in Pho	use 1 must be used with ST

Other Condition List ROAD REPAIRS XXXX FT LANE NARROWS XXXX FT TWO-WAY TRAFFIC XX MILE CONST TRAFFIC XXX FT UNEVEN LANES XXXX FT ROUGH ROAD XXXX FT ROADWORK NFXT FRI-SUN US XXX EXIT X MILES LANES SHIFT

TAY IN LANE in Phose 2.

APPLICATION GUIDELINES

Only 1 or 2 phases are to be used on a PCMS. 2. The 1st phase (or both) should be selected from the

- Road/Lane/Romp Closure List" and the "Other Condition List".
- 3. A 2nd phase can be selected from the "Action to Take/Effect on Travel, Location, General Warning, or Advance Notice Phose Lists".
- 4. A Location Phase is necessary only if a distance or location is not included in the first phase selected.
- 5. If two PCMS are used in sequence, they must be separated by a minimum of 1000 ft. Each PCMS shall be limited to two phases, and should be understandable by themselves.
- 6. For advance notice, when the current date is within seven days of the actual work date, calendar days should be replaced with days of the week. Advance notification should typically be for no more than one week prior to the work.

WORDING ALTERNATIVES

- 1. The words RIGHT, LEFT and ALL can be interchanged as appropriate. 2. Roadway designations IH, US, SH, FM and LP can be interchanged as
- appropriate. EAST, WEST, NORTH and SOUTH (or abbreviations E, W, N and S) can
- be interchanged as appropriate.
- 4. Highway names and numbers replaced as appropriate.
- 5. ROAD, HIGHWAY and FREEWAY can be interchanged as needed. 6. AHEAD may be used instead of distances if necessary.
- 7. FT and MI. MILE and MILES interchanged as appropriate.
- 8. AT. BEFORE and PAST interchanged as needed.
- 9. Distances or AHEAD can be eliminated from the message if a

location phase is used.


PCMS SIGNS WITHIN THE R.O.W. SHALL BE BEHIND GUARDRAIL OR CONCRETE BARRIER OR SHALL HAVE A MINIMUM OF FOUR (4) PLASTIC DRUMS PLACED PERPENDICULAR TO TRAFFIC ON THE UPSTREAM SIDE OF THE PCMS, WHEN EXPOSED TO ONE DIRECTION OF TRAFFIC. WHEN EXPOSED TO TWO WAY TRAFFIC. THE FOUR DRUMS SHOULD BE PLACED WITH ONE DRUM AT FACH OF THE FOUR CORNERS OF THE UNIT.

FULL MATRIX PCMS SIGNS

- 1. When Full Matrix PCMS signs are used, the character height and legibility/visibility requirements shall be maintained as listed in Note 15 under "PORTABLE CHANGEABLE MESSAGE SIGNS" above.
 - When symbol signs, such as the "Flagger Symbol" (CW20-7) are represented graphically on the Full Matrix PCMS sign and, with the approval of the Engineer, it shall maintain the legibility/visibility requirement listed above
- When symbol signs are represented graphically on the Full Matrix PCMS, they shall only supplement the use of the static sign represented, and shall not substitute for, or replace that sign.
- 4. A full matrix PCMS may be used to simulate a flashing arrow board provided it meets the visibility, flash rate and dimming requirements on BC(7), for the some size arrow.


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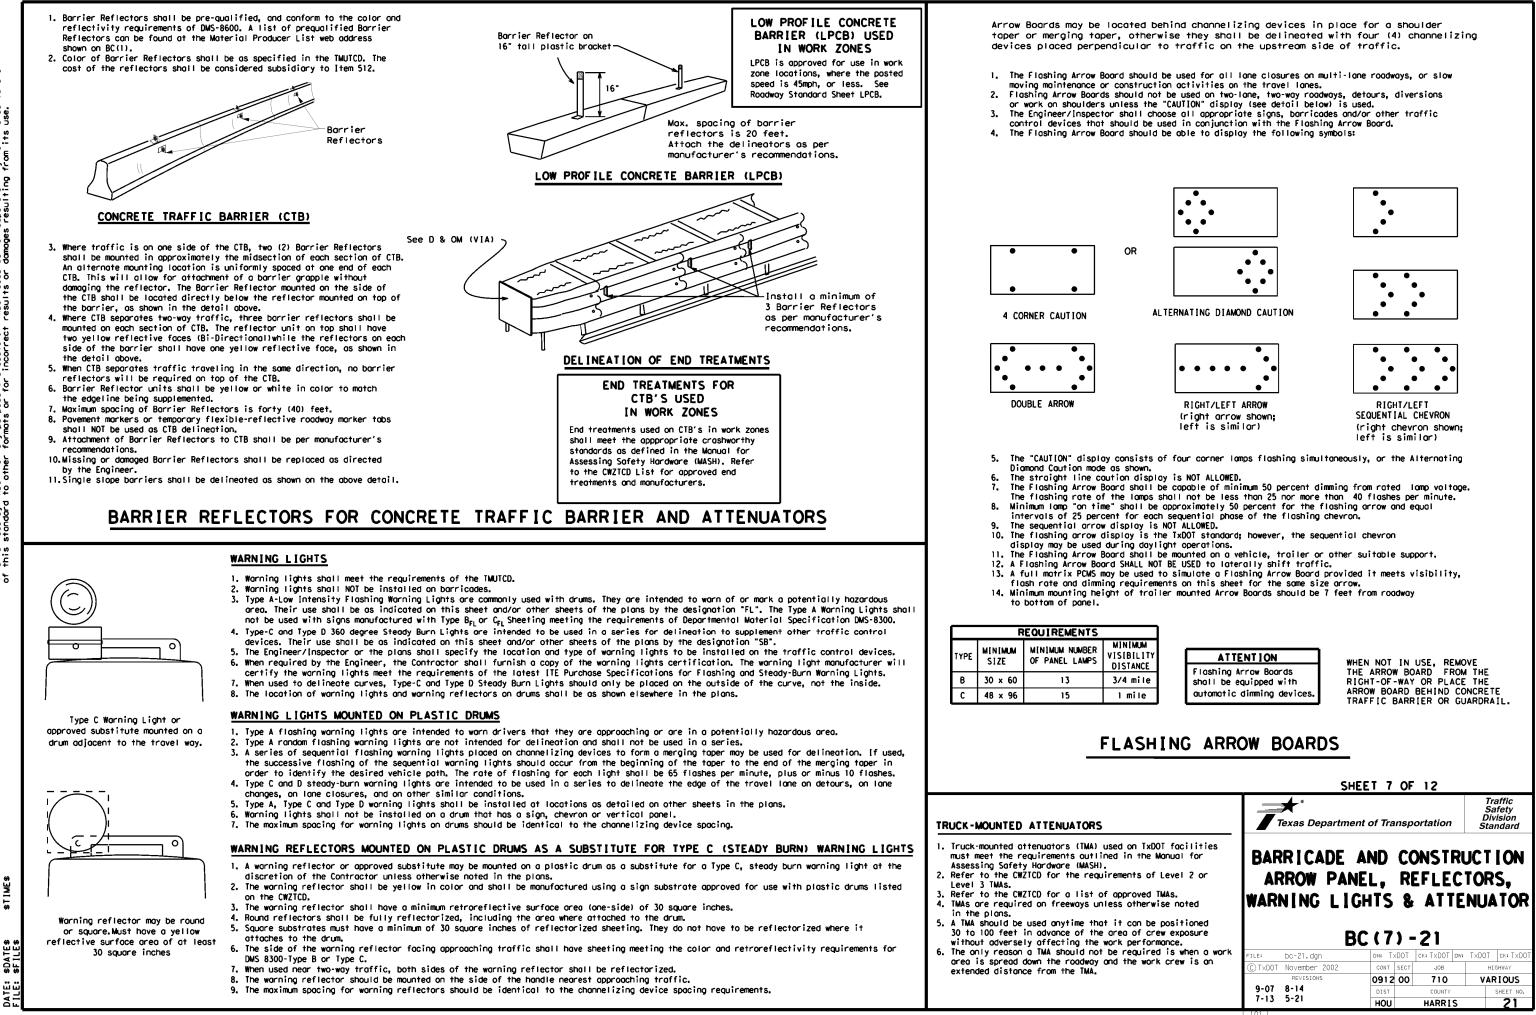
Phase 2: Possible Component Lists

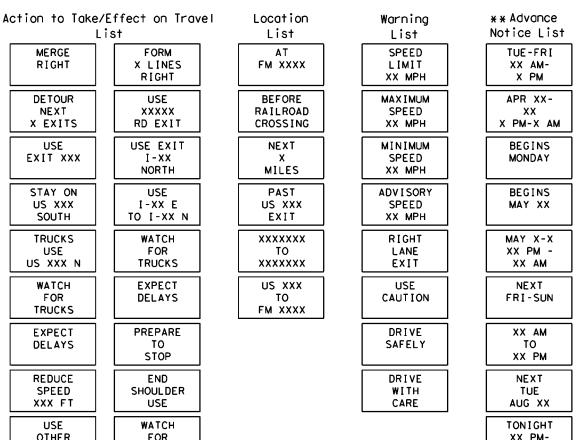


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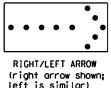
XX AM




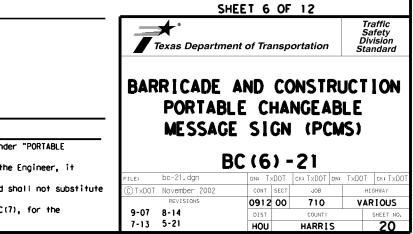



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GENERAL NOTES

- 1. For long term stationary work zones on freeways, drums shall be used as the primary channelizing device.
- 2. For intermediate term stationary work zones on freeways, drums should be used as the primary channelizing device but may be replaced in tangent sections by vertical panels, or 42° two-piece cones. In tangent sections, one-piece cones may be used with the approval of the Engineer but only if personnel are present on the project at all times to maintain the cones in proper position and location.
- 3. For short term stationary work zones on freeways, drums are the preferred channelizing device but may be replaced in tapers, transitions and tangent sections by vertical panels, two-piece cones or one-piece cones as approved by the Engineer.
- 4. Drums and all related items shall comply with the requirements of the current version of the "Texas Manual on Uniform Traffic Control Devices" (TMUTCD) and the "Compliant Work Zone Traffic Control Devices List" (CWZTCD).
- 5. Drums, bases, and related materials shall exhibit good workmanship and shall be free from objectionable marks or defects that would adversely affect their appearance or serviceability.
- 6. The Contractor shall have a maximum of 24 hours to replace any plastic drums identified for replacement by the Engineer/Inspector. The replacement device must be an approved device.

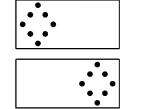GENERAL DESIGN REQUIREMENTS

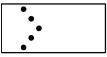
- Pre-qualified plastic drums shall meet the following requirements:
- 1. Plostic drums shall be a two-piece design; the "body" of the drum shall be the top portion and the "base" shall be the bottom.
- 2. The body and base shall lock together in such a manner that the body separates from the base when impacted by a vehicle traveling at a speed of 20 MPH or greater but prevents accidental separation due to normal handling and/or air turbulence created by passing vehicles.
- 3. Plastic drums shall be constructed of lightweight flexible, and deformable materials. The Contractor shall NOT use metal drums or single piece plastic drums as channelization devices or sign supports.
- 4. Drums shall present a profile that is a minimum of 18 inches in width at the 36 inch height when viewed from any direction. The height of drum unit (body installed on base) shall be a minimum of 36 inches and a maximum of 42 inches.
- 5. The top of the drum shall have a built-in handle for easy pickup and shall be designed to drain water and not collect debris. The handle shall have a minimum of two widely spaced 9/16 inch diameter holes to allow attachment of a warning light, warning reflector unit or approved compliant sign.
- 6. The exterior of the drum body shall have a minimum of four alternating orange and white retroreflective circumferential stripes not less than 4 inches nor greater than 8 inches in width. Any non-reflectorized space between any two adjacent stripes shall not exceed 2 inches in width,
- 7. Bases shall have a maximum width of 36 inches, a maximum height of 4 inches, and a minimum of two footholds of sufficient size to allow base to be held down while separating the drum body from the base.
- 8. Plastic drums shall be constructed of ultra-violet stabilized, orange, high-density polyethylene (HDPE) or other approved material.
- 9. Drum body shall have a maximum unballasted weight of 11 lbs.
- 10. Drum and base shall be marked with manufacturer's name and model number.

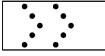
RETROREFLECTIVE SHEETING

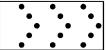- 1. The stripes used on drums shall be constructed of sheeting meeting the color and retroreflectivity requirements of Departmental Materials Specification DMS-8300, "Sign Face Materials." Type A or Type B reflective sheeting shall be supplied unless otherwise specified in the plans.
- 2. The sheeting shall be suitable for use on and shall adhere to the drum surface such that, upon vehicular impact, the sheeting shall remain adhered in-place and exhibit no delaminating, cracking, or loss of retroreflectivity other than that loss due to abrasion of the sheeting surfoce.

BALLAST

- 1. Unballasted bases shall be large enough to hold up to 50 lbs. of sand. This base, when filled with the ballast material, should weigh between 35 lbs (minimum) and 50 lbs (maximum). The ballast may be sand in one to three sandbags separate from the base, sand in a sand-filled plastic base, or other ballasting devices as approved by the Engineer. Stacking of sandbags will be allowed, however height of sandbags above pavement surface may not exceed 12 inches.
- 2. Bases with built-in ballast shall weigh between 40 lbs. and 50 lbs. Built-in ballast can be constructed of an integral crumb rubber base or a solid rubber base.
- Recycled truck tire sidewalls may be used for ballast on drums approved for this type of ballast on the CWZTCD list.
- 4. The ballast shall not be heavy objects, water, or any material that would become hazardous to motorists, pedestrians, or workers when the drum is struck by a vehicle.
- When used in regions susceptible to freezing, drums shall have drainage holes in the bottoms so that water will not collect and freeze becoming a hazard when struck by a vehicle.
- 6. Ballast shall not be placed on top of drums.
- 7. Adhesives may be used to secure base of drums to povement.

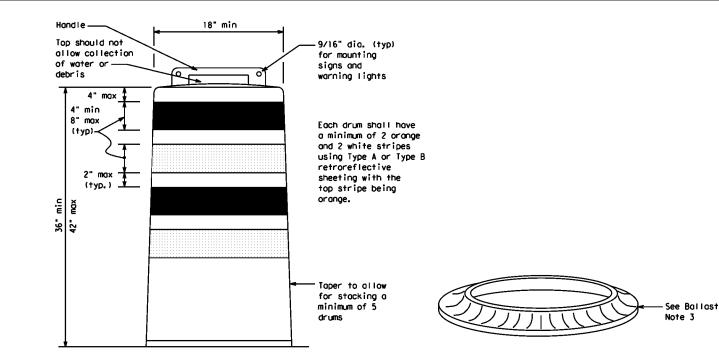

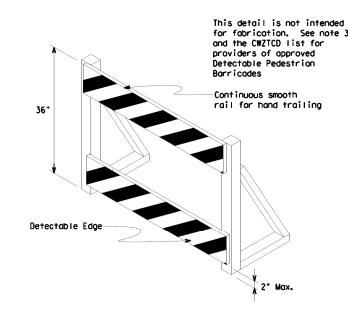


DETECTABLE PEDESTRIAN BARRICADES

- 1. When existing pedestrian facilities are disrupted, closed, or relocated in a TTC zone, the temporary facilities shall be detectable and include accessibility features consistent with the features present in the existing pedestrian facility. Refer to WZ(BTS-2) for Pedestrian Control requirements for Sidewalk Diversions, Sidewalk Detours and Crosswalk Closures. 2. Where pedestrians with visual disabilities normally use the
- closed sidewalk, a Detectable Pedestrian Barricade shall be placed across the full width of the closed sidewalk instead of a Type 3 Barricade.
- 3. Detectable pedestrian barricades similar to the one pictured above, longitudinal channelizing devices, some concrete barriers, and wood or chain link fencing with a continuous detectable edging can satisfactorily delineate a pedestrian
- 4. Tape, rope, or plastic chain strung between devices are not detectable, do not comply with the design standards in the "Americans with Disabilities Act Accessibility Guidelines (ADAAG)" and should not be used as a control for pedestrian movements.
- 5. Warning lights shall not be attached to detectable pedestrian barricades.
- 6. Detectable pedestrian barricades should use 8" nominal barricade rails as shown on BC(10) provided that the top rail provides a smooth continuous rail suitable for hand trailing with no splinters, burrs, or sharp edges.

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(Maximum Sign Dimension)

Chevron CWI-8, Opposing Traffic Lane

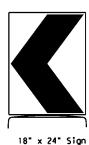Divider, Driveway sign D70a, Keep Right

R4 series or other signs as approved

by Engineer




12" x 24" Vertical Popel mount with diagonals sloping down towards travel way

Plywood, Aluminum or Metal sign substrates shall NOT be used on plastic drums

SIGNS, CHEVRONS, AND VERTICAL PANELS MOUNTED ON PLASTIC DRUMS

- 1. Signs used on plastic drums shall be manufactured using substrates listed on the CWZICD.
- 2. Chevrons and other work zone signs with an orange background shall be manufactured with Type $B_{\rm FL}$ or Type $C_{\rm FL}$ Orange sheeting meeting the color and retroreflectivity requirements of DMS-8300, "Sign Face Material," unless otherwise specified in the plans.
- 3. Vertical Panels shall be manufactured with orange and white sheeting meeting the requirements of DMS-8300 Type A or Type B. Diagonal stripes on Vertical Panels shall slope down toward the intended traveled lane.
- 4. Other sign messages (text or symbolic) may be used as approved by the Engineer. Sign dimensions shall not exceed 18 inches in width or 24 inches in height, except for the R9 series signs discussed in note 8 below.
- 5. Signs shall be installed using a 1/2 inch bolt (nominal) and nut, two washers, and one locking washer for each connection.
- 6. Mounting bolts and nuts shall be fully engaged and adequately torqued. Bolts should not extend more than 1/2 inch beyond nuts.
- 7. Chevrons may be placed on drums on the outside of curves, on merging tapers or on shifting tapers. When used in these locations, they may be placed on every drum or spaced not more than on every third drum. A minimum of three (3) should be used at each location called for in the plans.
- 8. R9-9, R9-10, R9-11 and R9-11a Sidewalk Closed signs which are 24 inches wide may be mounted on plastic drums, with approval of the Engineer.

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CHANNEL B FILE: bc-21, dgn © TXDOT November 2002	IZING BC (8) DN: TXDOT CONT SEC	- 21 - 21 CK: TXDOT JOB	I	TXDOT HI VAF	ck: TxD ghway

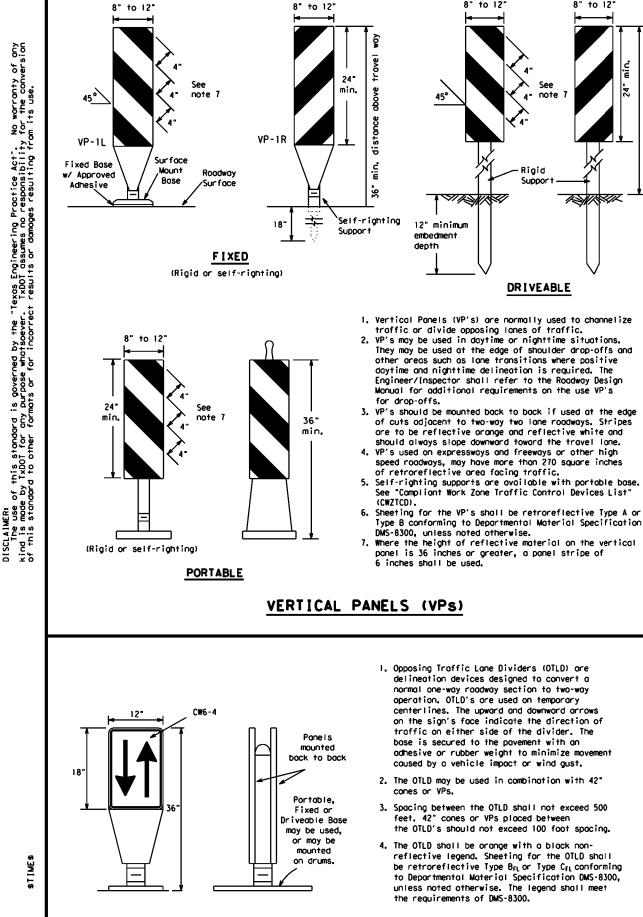

OPPOSING TRAFFIC LANE DIVIDERS (OTLD)

1. The chevron shall be a vertical rectangle with a 12* minimum size of 12 by 18 inches. 2. Chevrons are intended to give notice of a sharp change of alignment with the direction of travel and provide additional emphasis and guidance for vehicle operators with regard to changes in horizontal alignment of the roadway. Min. 3. Chevrons, when used, shall be erected on the outside of a sharp curve or turn, or on the far side of an intersection. They shall be in line with and at right angles to approaching traffic. Spacing should be such that the motorist always has three in view, until the change in alignment eliminates its need. 4. To be effective, the chevron should be visible j. for at least 500 feet. 36' 5. Chevrons shall be orange with a black nonreflective legend. Sheeting for the chevron shall be retroreflective Type BFL or Type CFL conforming to Departmental Material Specification DMS-8300, unless noted otherwise. The legend shall meet the requirements of DMS-8300. 6. For Long Term Stationary use on tapers or Fixed Bose w/ Approved Adhesive (Driveoble Base, or Flexible transitions on freeways and divided highways, Support can be used) self-righting chevrons may be used to supplement plastic drums but not to replace plastic drums. CHEVRONS 90 ' 9 9 LONGITUDINAL CHANNELIZING DEVICES (LCD) 1. LCDs are crashworthy, lightweight, deformable devices that are highly visible, have good target value and can be connected together. They are not designed to contain or redirect a vehicle on impact. 2. LCDs may be used instead of a line of cones or drums. 3. LCDs shall be placed in accordance to application and installation requirements specific to the device, and used only when shown on the CWZTCD list. 4. LCDs should not be used to provide positive protection for obstacles, pedestrians or workers. 5. LCDs shall be supplemented with retroreflective delineation as required for temporary barriers on BC(7) when placed roughly parallel to the travel lanes. 6. LCDs used as barricades placed perpendicular to traffic should have at least one row of reflective sheeting meeting the requirements for barricade rails as shown on BC(10). Place reflective sheeting near the top of the LCD along the full length of the device. WATER BALLASTED SYSTEMS USED AS BARRIERS Water ballasted systems used as barriers shall not be used solely to channelize road users, but also to protect the work space per the appropriate Manual for Assessing Safety Hardware (MASH) crashworthiness requirements based on roadway speed and barrier application. Water ballasted systems used to channelize vehicular traffic shall be supplemented with retroreflective delineation or channelizing devices to improve daytime/nighttime visibility. They may also be supplemented with pavement markings. 3. Water ballasted systems used as barriers shall be placed in accordance to application and installation requirements specific to the device, and used only when shown on the CWZTCD list. Water ballasted systems used as barriers should not be used for a merging taper except in low speed (less than 45 MPH) urban areas. When used on a taper in a low speed urban area, the taper shall be delineated and the taper length should be designed to optimize road user operations considering the available geometric conditions. When water ballasted systems used as barriers have blunt ends exposed to traffic, they should be attenuated as per manufacturer recommendations or flared to a point outside the clear zone. If used to channelize pedestrians, longitudinal channelizing devices or water ballasted systems must have a continuous detectable bottom for users of long canes and the top of the unit shall not be less than 32 inches in height. HOLLOW OR WATER BALLASTED SYSTEMS USED AS LONGITUDINAL CHANNELIZING DEVICES OR BARRIERS

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GENERAL NOTES

- 1. Work Zone channelizing devices illustrated on this sheet may be installed in close proximity to traffic and are suitable for use on high or low speed roadways. The Engineer/inspector shall ensure that spacing and placement is uniform and in accordance with the "Texas Manual on Uniform Traffic Control Devices" (TMUTCD).
- 2. Channelizing devices shown on this sheet may have a driveable, fixed or portable base. The requirement for self-righting channelizing devices must be specified in the General Notes or other plan sheets.
- 3. Channelizing devices on self-righting supports should be used in work zone areas where channelizing devices are frequently impacted by errant vehicles or vehicle related wind gusts making alignment of the channelizing devices difficult to maintain. Locations of these devices shall be detailed elsewhere in the plans. These devices shall conform to the TMUTCD and the "Compliant Work Zone Traffic Control Devices List" (CWZTCD).
- 4. The Contractor shall maintain devices in a clean condition and replace damaged, nonreflective, faded, or broken devices and bases as required by the Engineer/Inspector. The Contractor shall be required to maintain proper device spacing and alignment.
- 5. Portable bases shall be fabricated from virgin and/or recycled rubber. The portable bases shall weigh a minimum of 30 lbs.
- Pavement surfaces shall be prepared in a manner that ensures proper bonding between the adhesives, the fixed mount bases and the pavement surface. Adhesives shall be prepared and applied according to the manufacturer's recommendations.
- 7. The installation and removal of channelizing devices shall not cause detrimental effects to the final pavement surfaces, including pavement surface discoloration or surface integrity. Driveable bases shall not be permitted on final pavement surfaces. The Engineer/Inspector shall approve all application and removal procedures of fixed bases.


Posted Speed	Formula	Minimum Desirable Taper Lengths X X			Suggested Maximum Spacing of Channelizing Devices		
		10' Offset	11' Offset	12' Offset	0∩ a Taper	On a Tangent	
30	2	150'	1651	180'	30'	60 <i>'</i>	
35	$L = \frac{WS^2}{60}$	205'	225'	245'	35'	70′	
40	60	265'	295′	320'	40′	80 <i>'</i>	
45		450 <i>′</i>	495′	540'	45′	90′	
50		500'	550'	600ʻ	50 <i>'</i>	100'	
55	L=WS	550'	605 <i>'</i>	660´	55 <i>'</i>	110'	
60	L - W J	600'	660'	720'	60′	120'	
65		650'	7151	780 <i>'</i>	65′	130'	
70		700'	770'	840'	70′	140'	
75		750'	825'	900'	75'	150′	
80		8001	8801	960'	80'	160'	

★★Taper lengths have been rounded off. L=Length of Taper (FT.) W=Width of Offset (FT.) S=Posted Speed (MPH)

SUGGESTED MAXIMUM SPACING OF CHANNELIZING DEVICES AND MINIMUM DESIRABLE TAPER LENGTHS

SHEET 9 OF 12	
Texas Department of Transportation	Traffic Safety Division Standard
BARRICADE AND CONSTRUCT CHANNELIZING DEVIC	

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© TxDOT	November 2002	CONT	SECT	JOB		HIC	GHWAY
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WORK ZONE PAVEMENT MARKINGS

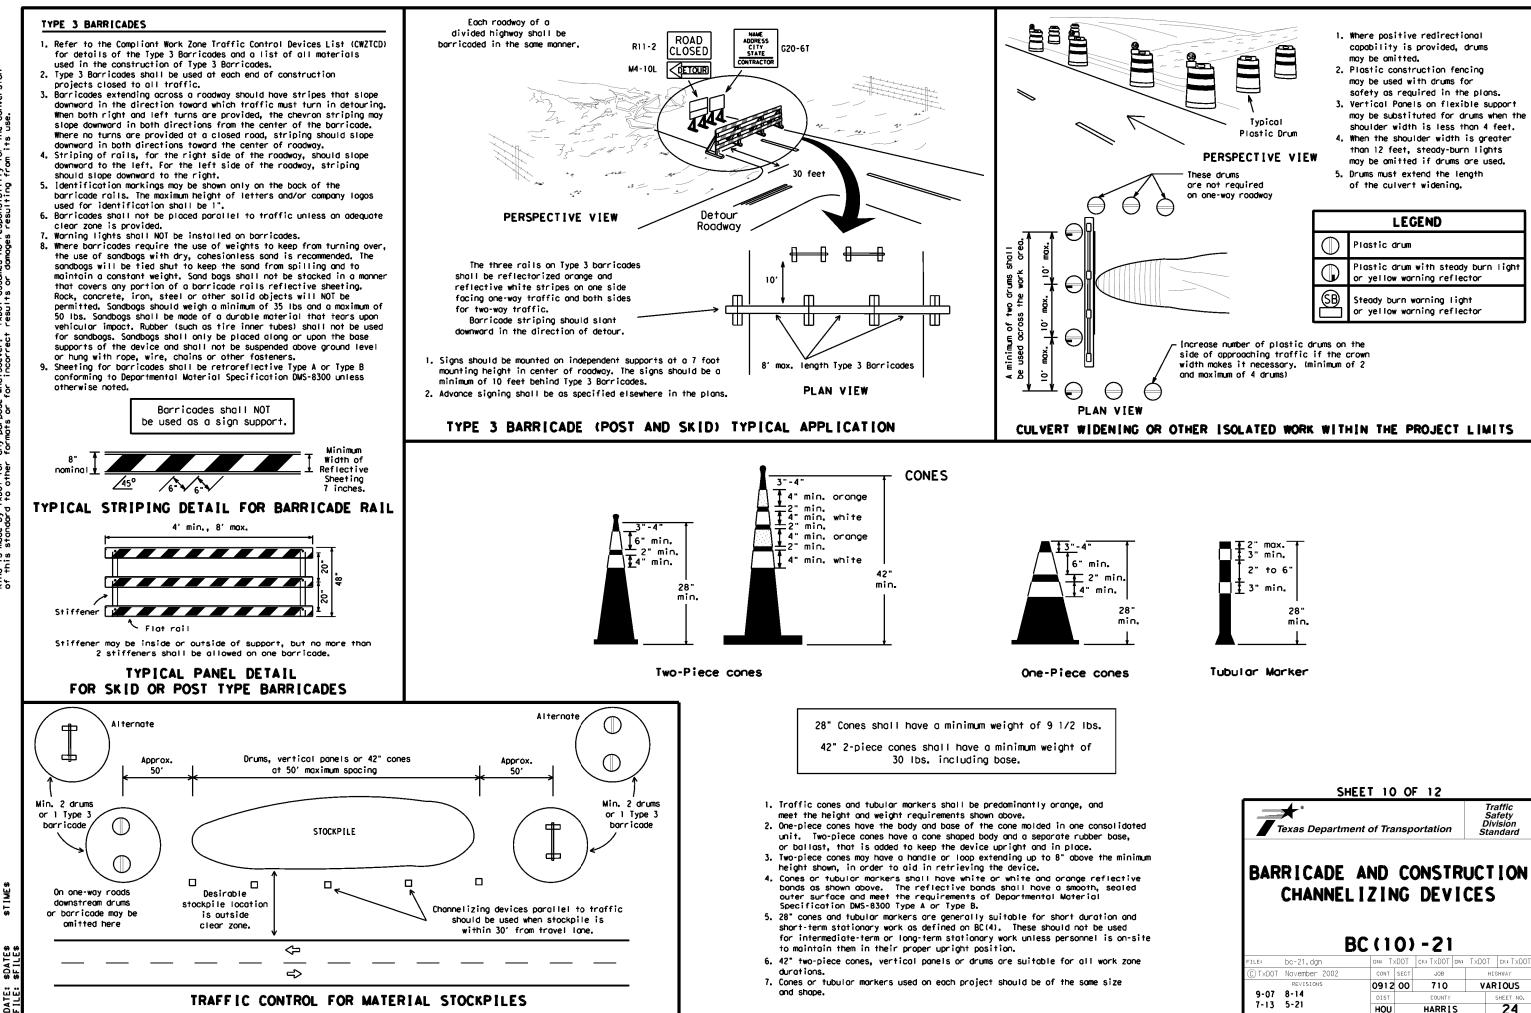GENERAL

- 1. The Contractor shall be responsible for maintaining work zone and existing pavement markings, in accordance with the standard specifications and special provisions, on all roadways open to traffic within the CSJ limits unless otherwise stated in the plans.
- 2. Color, patterns and dimensions shall be in conformance with the "Texas Manual on Uniform Traffic Control Devices" (TMUTCD).
- 3. Additional supplemental pavement marking details may be found in the plans or specifications.
- 4. Povement markings shall be installed in accordance with the TMUTCD and as shown on the plans.
- 5. When short term markings are required on the plans, short term markings shall conform with the TMUTCD, the plans and details as shown on the Standard Plan Sheet WZ(STPM).
- 6. When standard pavement markings are not in place and the roadway is opened to traffic, DO NOT PASS signs shall be erected to mark the beginning of the sections where passing is prohibited and PASS WITH CARE signs at the beginning of sections where passing is permitted.
- 7. All work zone pavement markings shall be installed in accordance with 1tem 662, "Work Zone Pavement Markings."

RAISED PAVEMENT MARKERS

- 1. Raised pavement markers are to be placed according to the patterns on BC(12).
- 2. All raised pavement markers used for work zone markings shall meet the requirements of Item 672, "RAISED PAVEMENT MARKERS" and Departmental Material Specification DMS-4200 or DMS-4300.

PREFABRICATED PAVEMENT MARKINGS

- 1. Removable prefabricated pavement markings shall meet the requirements of DMS-8241.
- 2. Non-removable prefabricated pavement markings (foil back) shall meet the requirements of DMS-8240.


MAINTAINING WORK ZONE PAVEMENT MARKINGS

- 1. The Contractor will be responsible for maintaining work zone pavement markings within the work limits.
- 2. Work zone pavement markings shall be inspected in accordance with the frequency and reporting requirements of work zone traffic control device inspections as required by Form 599.
- 3. The markings should provide a visible reference for a minimum distance of 300 feet during normal daylight hours and 160 feet when illuminated by automobile low-beam headlights at night, unless sight distance is restricted by roadway geometrics.
- 4. Markings failing to meet this criteria within the first 30 days after placement shall be replaced at the expense of the Contractor as per Specification Item 662.

REMOVAL OF PAVEMENT MARKINGS

- 1. Pavement markings that are no longer applicable, could create confusion or direct a motorist toward or into the closed portion of the roadway shall be removed or obliterated before the roadway is opened to traffic.
- 2. The above shall not apply to detours in place for less than three days, where flaggers and/or sufficient channelizing devices are used in lieu of markings to outline the detour route.
- 3. Pavement markings shall be removed to the fullest extent possible, so as not to leave a discernable marking. This shall be by any method approved by TxDOT Specification Item 677 for "Eliminating Existing Povement Morkings and Markers".
- 4. The removal of pavement markings may require resurfacing or seal coating portions of the roadway as described in Item 677.
- 5. Subject to the approval of the Engineer, any method that proves to be successful on a particular type pavement may be used.
- 6. Blast cleaning may be used but will not be required unless specifically shown in the plans.
- 7. Over-painting of the markings SHALL NOT BE permitted.
- 8. Removal of raised pavement markers shall be as directed by the Engineer.
- 9. Removal of existing pavement markings and markers will be paid for directly in accordance with Item 677, "ELIMINATING EXISTING PAVEMENT MARKINGS AND MARKERS, " unless otherwise stated in the plans.
- 10.Black-out marking tape may be used to cover conflicting existing markings for periods less than two weeks when approved by the Engineer.

Temporary Flexible-Reflective Roadway Marker Tabs

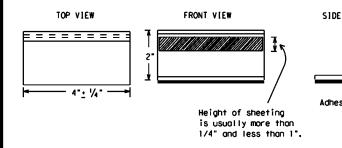

STAPLES OR NAILS SHALL NOT BE USED TO SECUR TEMPORARY FLEXIBLE-REFLECTIVE ROADWAY MARK TABS TO THE PAVEMENT SURFACE

- 1. Temporary flexible-reflective roadway marker tabs used as guidem sholl meet the requirements of DMS-8242.
- 2. Tabs detailed on this sheet are to be inspected and accepted by Engineer or designated representative. Sampling and testing is n normally required, however at the option of the Engineer, either or "B" below may be imposed to assure quality before placement or roadway.
 - A. Select five (5) or more tabs at random from each lot or sh and submit to the Construction Division, Materials and Pave Section to determine specification compliance.
 - B. Select five (5) tabs and perform the following test. Affix (5) tabs at 24 inch intervals on an asphaltic pavement in straight line. Using a medium size passenger vehicle or pic run over the markers with the front and rear tires at a spe of 35 to 40 miles per hour, four (4) times in each direction more than one (1) out of the five (5) reflective surfaces be lost or displaced as a result of this test.
- 3. Small design variances may be noted between tab manufacturers.
- 4. See Standard Sheet WZ(STPM) for tab placement on new pavements. Standard Sheet TCP(7-1) for tab placement on seal coat work,

RAISED PAVEMENT MARKERS USED AS GUIDEMARKS


- 1. Roised pavement markers used as guidemarks shall be from the ap product list, and meet the requirements of DMS-4200.
- 2. All temporary construction raised pavement markers provided on project shall be of the same manufacturer.
- Adhesive for quidemarks shall be bituminous material hot applie butyl rubber pad for all surfaces, or thermoplastic for concretsurfaces.


Guidemarks shall be designated as:

YELLOW - (two amber reflective surfaces with yellow body). WHITE - (one silver reflective surface with white body).

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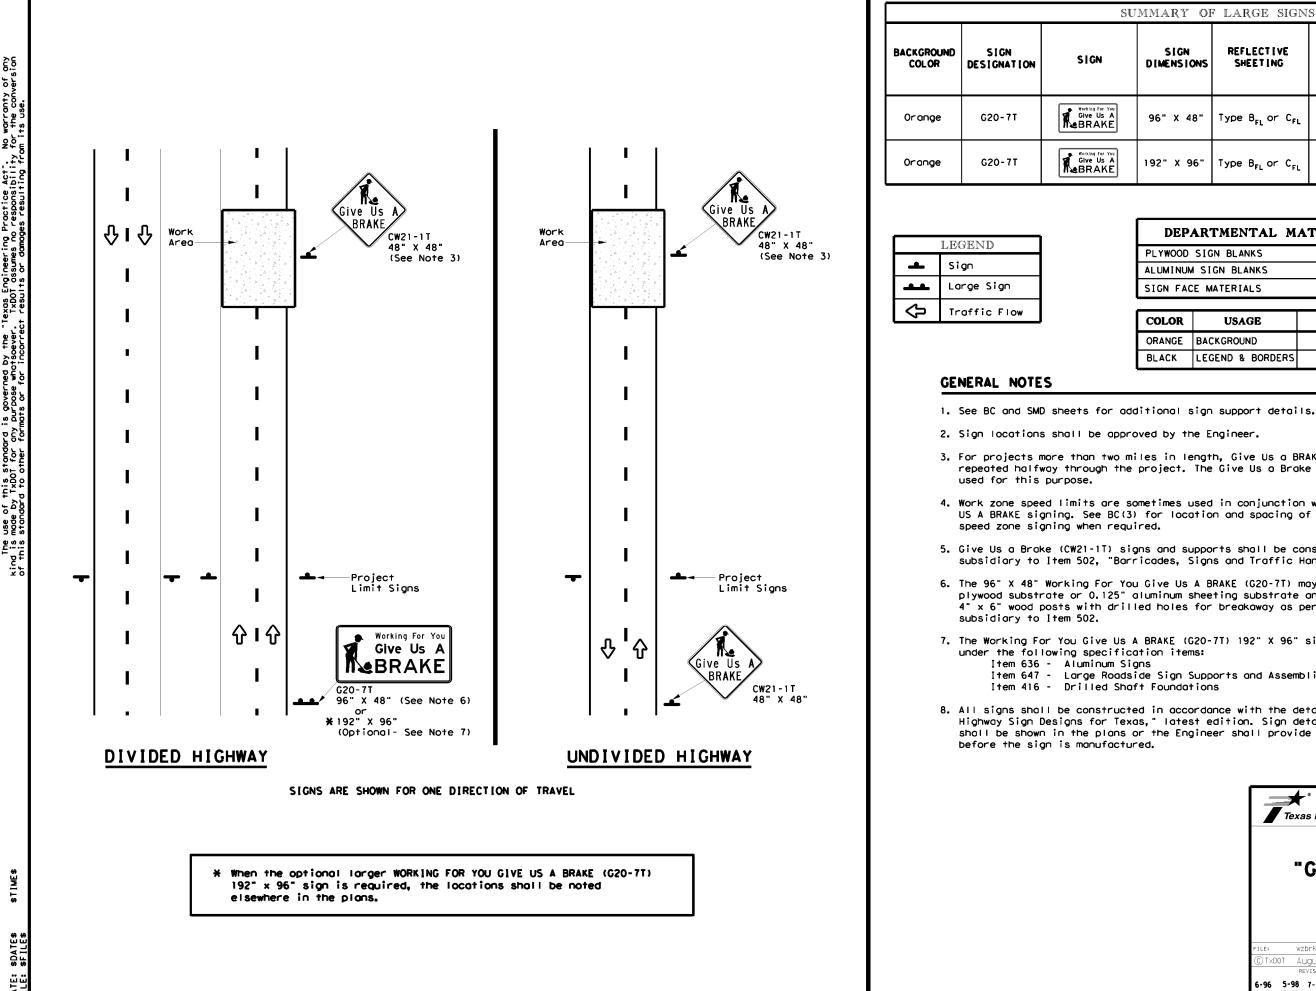
	DEPARTMENTAL MATERIAL SPECIFICA	LONS
	PAVEMENT MARKERS (REFLECTORIZED)	DMS-4200
	TRAFFIC BUTTONS	DMS-4300
	EPOXY AND ADHESIVES	DMS-6100
VIEW	BITUMINOUS ADHESIVE FOR PAVEMENT MARKERS	DMS-6130
ר T	PERMANENT PREFABRICATED PAVEMENT MARKINGS	DMS-8240
	TEMPORARY REMOVABLE, PREFABRICATED PAVEMENT MARKINGS	DMS-8241
	TEMPORARY FLEXIBLE, REFLECTIVE ROADWAY MARKER TABS	DMS-8242
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	A list of prequalified reflective raised pavemen non-reflective traffic buttons, roadway marker pavement markings can be found at the Material F web address shown on BC(1).	tabs and other
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		Traffic
	Texas Department of Transportation	Safety Division Standard
		Standard
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	PAVEMENT MARKIN	NGS
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	LEGEND	
	Type 3 Barricade	
• • •	Channelizing Devices	
Ē	Trailer Mounted Flashing Arrow Board	1
<u> </u>	Sign	
~~~	Safety glare screen	
-	TMENTAL MATERIAL SPECIFIC	
SIGN FACE I	MATERIALS	DMS-830
DELINEATOR	S AND OBJECT MARKERS	DMS-860
MODULAR GL	ARE SCREENS FOR HEADLIGHT BARRIER	DMS-861
the Compl CWZTCD) de	re-qualified products shall be used. iant Work Zone Traffic Control Device scribes pre-qualified products and th e found at the following web address:	es List" neir source
апа тау р		
	//www.txdot.gov/business/resources/producer-list	t.html

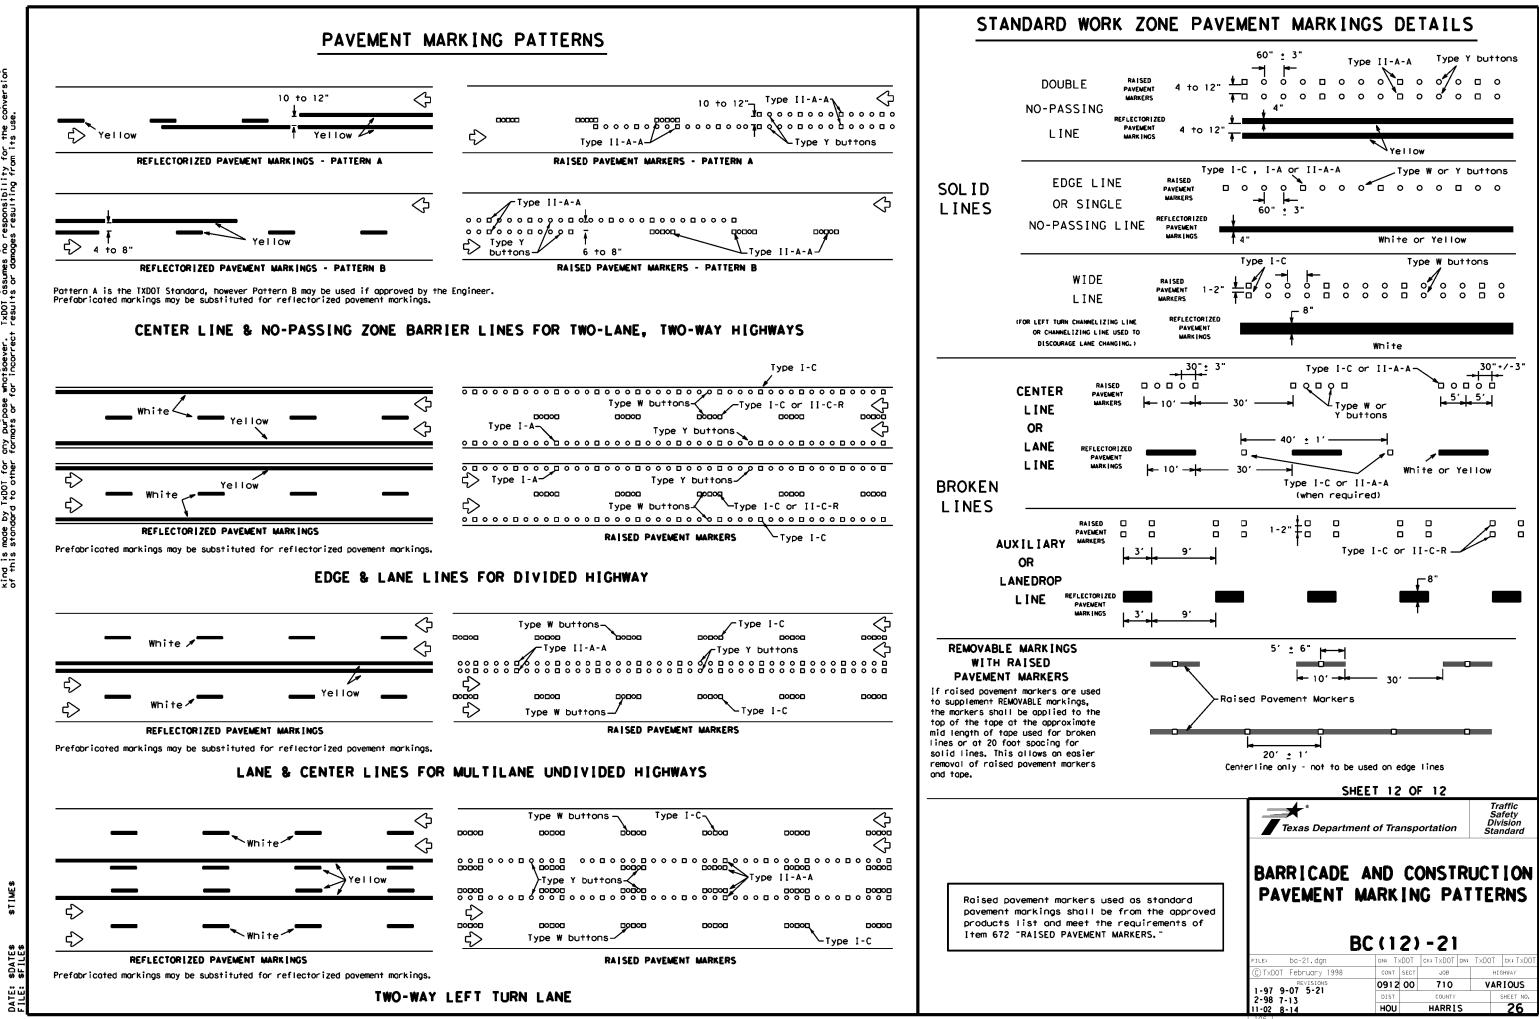

U	UMMARY OF LARGE SIGNS						
	SIGN DIMENSIONS	REFLECT I VE SHEET I NG	SQ FT	GALVA Struc St			DRILLED SHAFT
	DIMENSIONS	5.22.1146		Size	ч О	F) @	24" DIA. (LF)
	96" X 48"	Type B _{FL} or C _{FL}	32				•
	192" X 96"	Type B _{FL} or C _{FL}	128	₩8×18	16	17	12

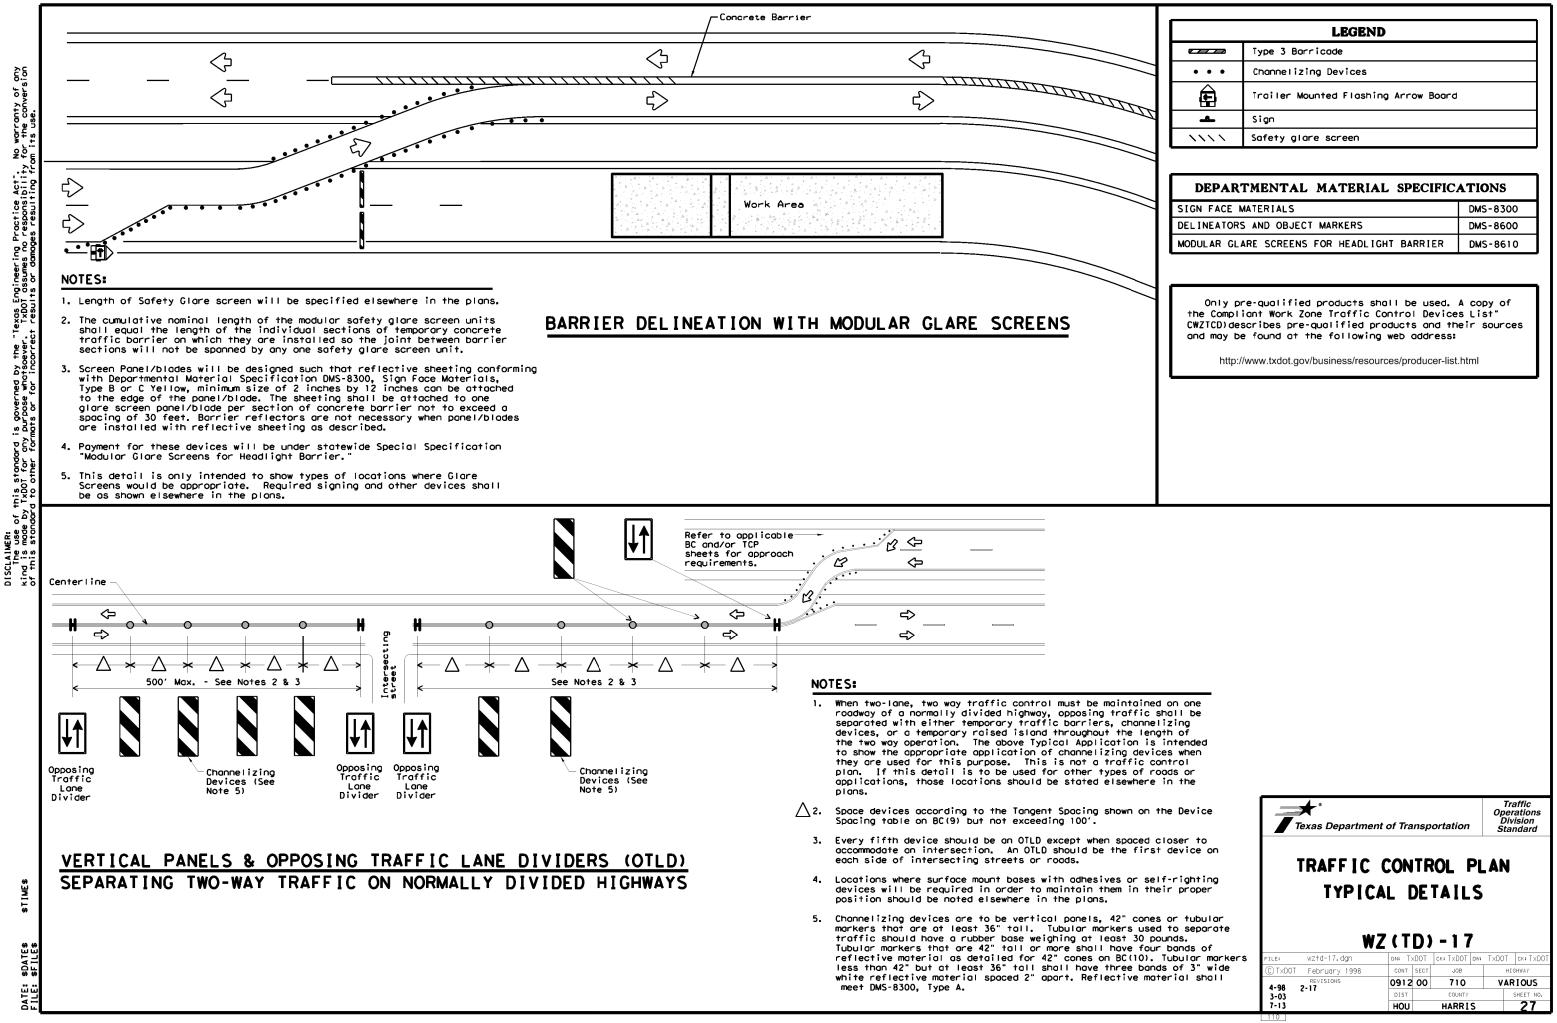▲ See Note 6 Below

DEPARTMENTAL MATERIAL SPEC	IFICATIONS
PLYWOOD SIGN BLANKS	DMS-7100
ALUMINUM SIGN BLANKS	DMS-7110
SIGN FACE MATERIALS	DMS-8300

COLOR	USAGE	SHEETING MATERIAL		
ORANGE	BACKGROUND	TYPE B _{FL} OR TYPE C _{FL}		
BLACK	LEGEND & BORDERS	NON-REFLECTIVE ACRYLIC FILM		

3. For projects more than two miles in length, Give Us a BRAKE signs should be repeated halfway through the project. The Give Us a Brake (CW21-1T) may be

4. Work zone speed limits are sometimes used in conjunction with GIVE US A BRAKE signing. See BC(3) for location and spacing of construction


5. Give Us a Brake (CW21-1T) signs and supports shall be considered subsidiary to Item 502, "Barricades, Signs and Traffic Handling."

6. The 96" X 48" Working For You Give Us A BRAKE (G20-7T) may use a 1/2" or 5/8" plywood substrate or 0.125" aluminum sheeting substrate and may be supported by two 4" x 6" wood posts with drilled holes for breakaway as per BC(5) and will be

7. The Working For You Give Us A BRAKE (G20-7T) 192" X 96" sign shall be paid for Item 647 - Large Roadside Sign Supports and Assemblies.

8. All signs shall be constructed in accordance with the details found in the "Standard Highway Sign Designs for Texas," latest edition. Sign details not shown in this manual shall be shown in the plans or the Engineer shall provide a detail to the Contractor

**	ent of Trans	portation	Traffic Operations Division Standard				
WORK ZONE "GIVE US A BRAKE" SIGNS							
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FILE: wzbrk-13, dan	NZ (BR	K) - 13	-				
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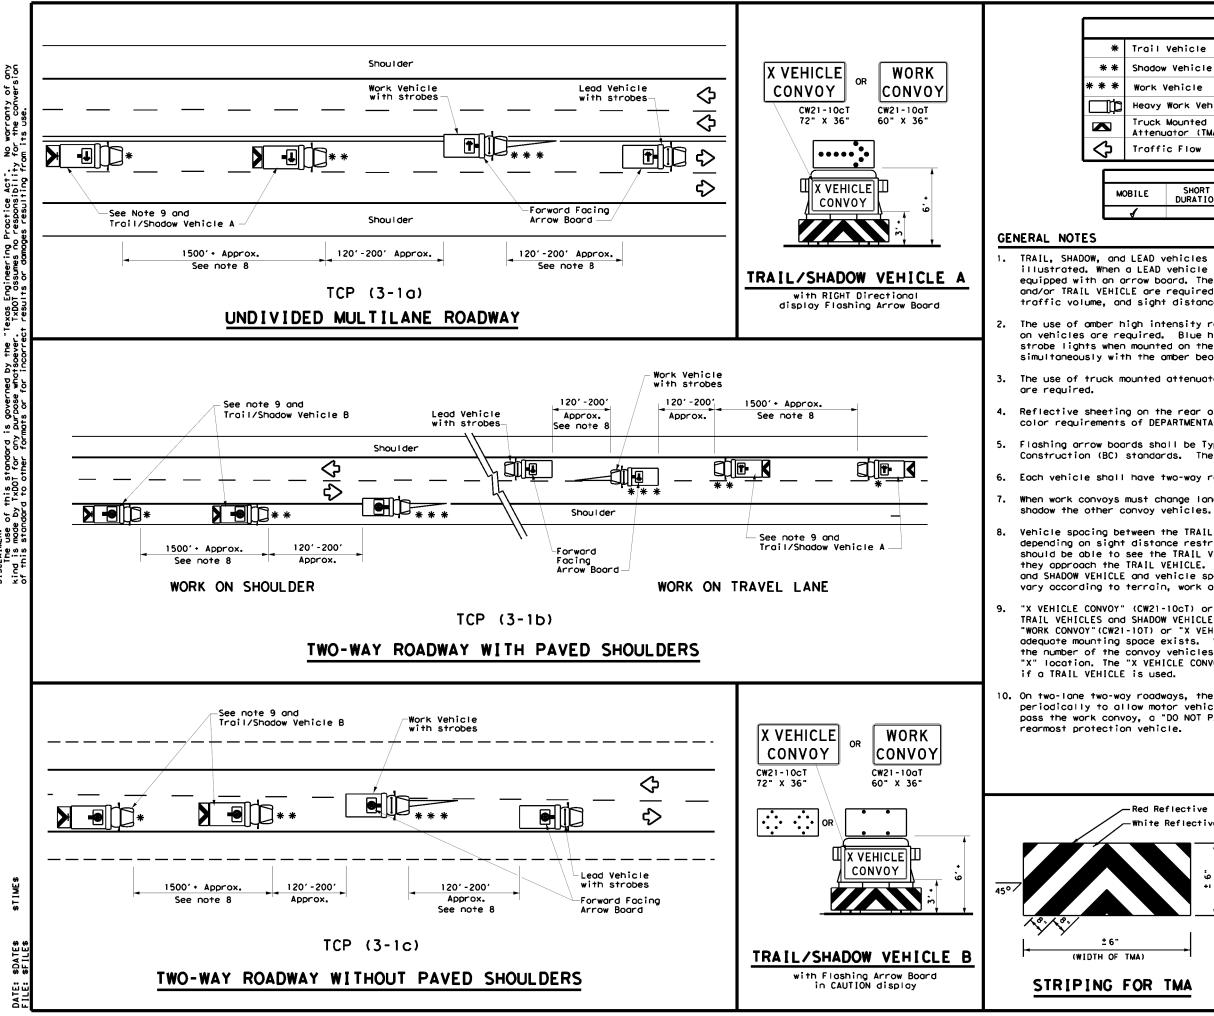

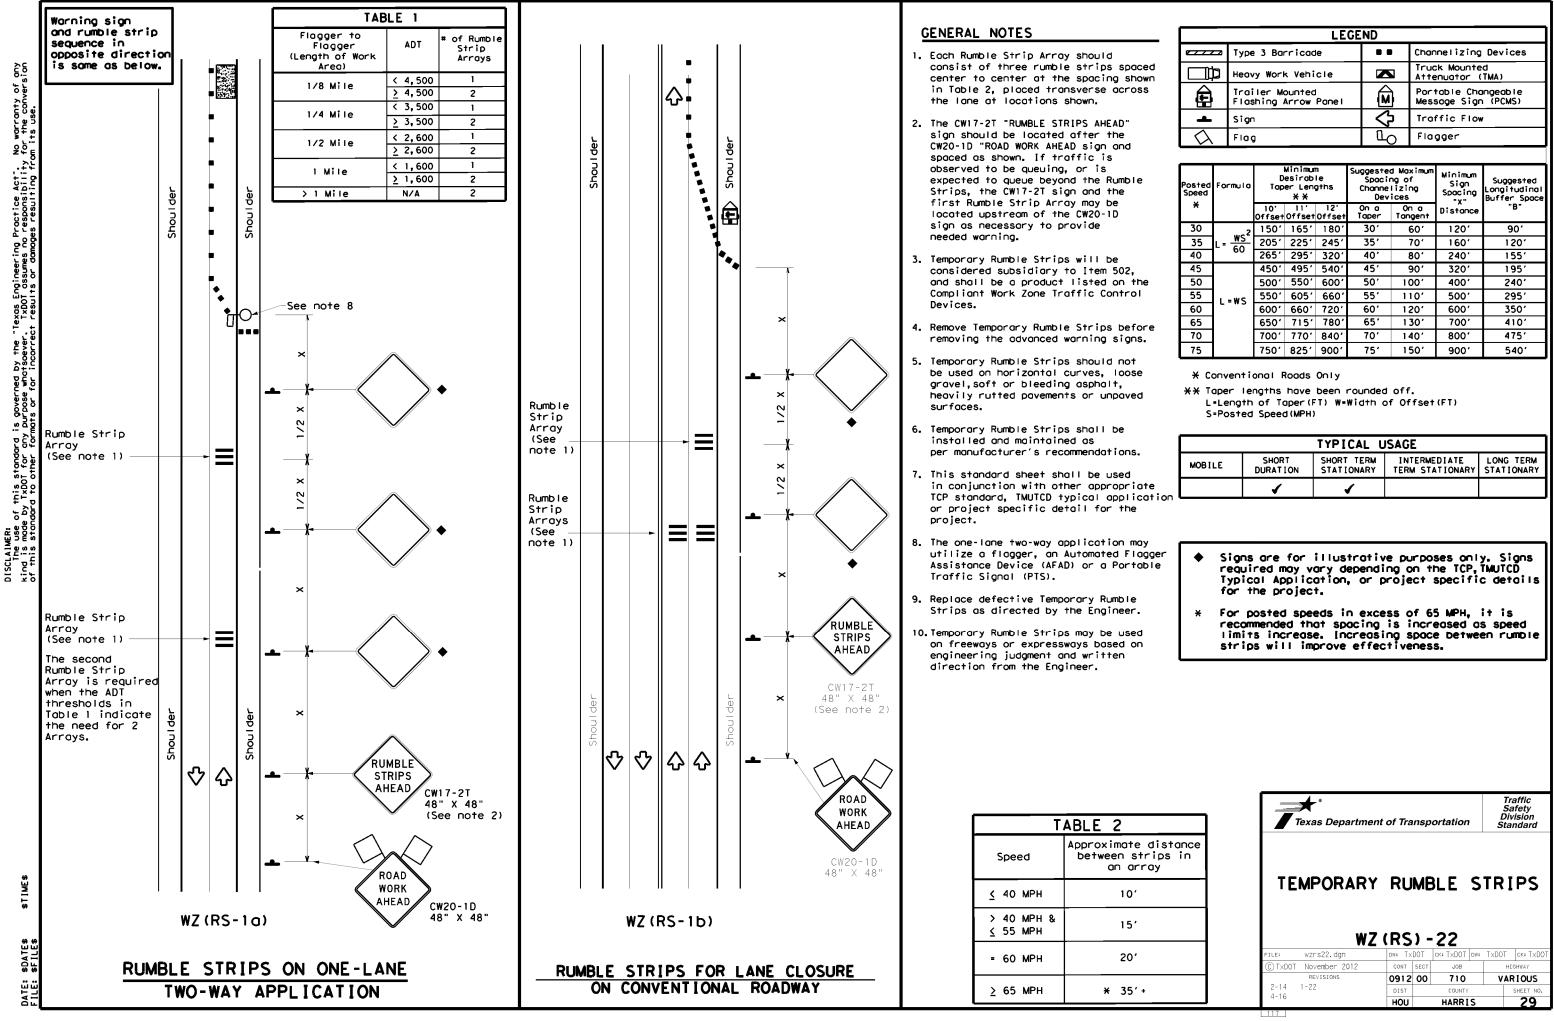
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LEGEND						
<u></u>	Type 3 Barricade		Channelizing Devices			
	Heavy Work Vehicle	K	Truck Mounted Attenuator (TMA)			
Ð	Trailer Mounted Flashing Arrow Panel		Portable Changeable Message Sign (PCMS)			
-	Sign	$\Diamond$	Traffic Flow			
$\Diamond$	Flog	٩	Flagger			

Speed	Formula	D	esirob er Lend X X	le	Spacin Channe		Minimum Sign Spacing "x"	Suggested Longitudinal Buffer Space
*		10' Offset	11' Offset	12' Offset	On a Taper	On a Tangent	Distance	"B"
30	ws ²	150'	165'	180'	30′	60′	120'	901
35	$L = \frac{WS^{-1}}{60}$	2051	2251	2451	35′	70'	1601	120'
40	60	2651	295'	320'	40'	80'	240'	155'
45		450'	495′	540'	45′	90'	320'	1951
50		500'	550'	600 <i>'</i>	50 <i>'</i>	100'	400'	240′
55	L=WS	550'	605′	660'	55 <i>'</i>	110'	500 <i>'</i>	295′
60	C - 11 S	600'	660'	720'	60'	120'	6001	350'
65		650'	715'	780'	65'	130'	700'	410′
70		700'	770'	840'	70'	140'	800'	475′
75		750′	825′	900′	75'	150'	900'	540'

			TYPICAL U	ISAGE	
	MOBILE	SHORT DURATION	SHORT TERM STATIONARY	INTERMEDIATE TERM STATIONARY	LONG TERM STATIONARY
ion		4	<b>√</b>		



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		LE	GEND		
Trail	Vehicle			ARROW BOARD D	
Shadow	Vehicle			ARROW BOARD DI	SPLAT
Work \	/ehicle		•	RIGHT Directio	onal
Heavy	Work Vehic	le	÷	LEFT Direction	וסר
	Mounted Jator (TMA)		<b>↔</b>	Double Arrow	
Troffi	C Flow			CAUTION (Alter Diamond or 4 (	
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ILE	SHORT DURATION			INTERMEDIATE TERM STATIONARY	LONG TERM STATIONARY
1					

TRAIL, SHADOW, and LEAD vehicles shall be equipped with arrow boards as illustrated, When a LEAD vehicle is not used the WORK vehicle must be equipped with an arrow board. The Engineer will determine if the LEAD VEHICLE and/or TRAIL VEHICLE are required based on prevailing roadway conditions, traffic volume, and sight distance restrictions.

2. The use of omber high intensity rotating, flashing, oscillating, or strobe lights on vehicles are required. Blue high intensity rotating, flashing, oscillating or strobe lights when mounted on the driver's side of the vehicle may be operated simultaneously with the amber beacons or strobe lights.

3. The use of truck mounted attenuators (TMA) on the SHADOW VEHICLE and TRAIL VEHICLE

Reflective sheeting on the rear of the TMA shall meet or exceed the reflectivity and color requirements of DEPARTMENTAL MATERIAL SPECIFICATION DMS 8300, Type A.

Flashing arrow boards shall be Type B or Type C as per the Barricade and Construction (BC) standards. The board shall be controlled from inside the vehicle.

Each vehicle shall have two-way radio communication capability.


When work convoys must change lanes, the TRAIL VEHICLE should change lanes first to

Vehicle spacing between the TRAIL VEHICLE and the SHADOW VEHICLE will vary depending on sight distance restrictions. Motorists approaching the work convoy should be able to see the TRAIL VEHICLE in time to slow down and/or change lanes as they approach the TRAIL VEHICLE. Vehicle spacing between the WORK VEHICLE and SHADOW VEHICLE and vehicle spacing between WORK VEHICLE and LEAD VEHICLE may vary according to terrain, work activity and other factors.

"X VEHICLE CONVOY" (CW21-10cT) or "WORK CONVOY" (CW21-10aT) signs shall be used on TRAIL VEHICLES and SHADOW VEHICLES as shown. As an option 48" X 48" diamond shaped "WORK CONVOY" (CW21-10T) or "X VEHICLE CONVOY" (CW21-10bT) signs may be used where adequate mounting space exists. When used, the X VEHICLE CONVOY sign shall have the number of the convoy vehicles displayed on the sign in the number designation "X" location. The "X VEHICLE CONVOY" sign shall not be used on the SHADOW VEHICLE

10. On two-lane two-way roadways, the work and protection vehicles should pull over periodically to allow motor vehicle traffic to pass. If motorists are not allowed to pass the work convoy, a "DO NOT PASS" (R4-1) sign should be placed on the back of the

Red Reflective White Reflective	Texas Department	nt of Transp	ortation	Oper Div	affic rations /ision ndard
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AA) OR TMA	FILE: tcp3-1.dgn © TxDOT December 1985	CP ( 3 - DN: T×DOT CONT SECT	- <b>1 ) - 1</b> ск: Тхрот ож: јов	3 T×DOT HI VAF	GHWAY

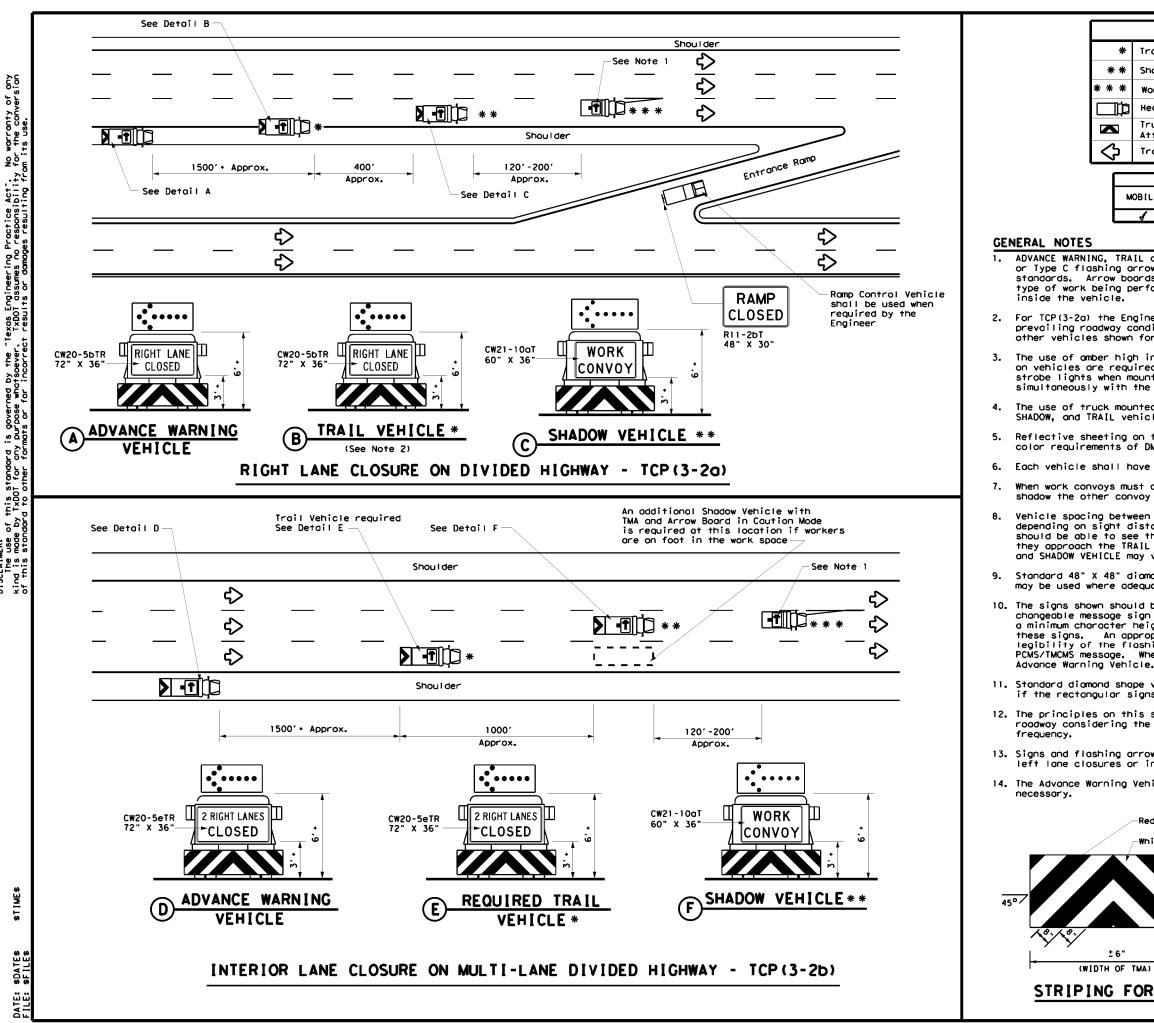

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LEGEND								
Trail Vehicle			ARROW BOARD DISPLAY					
Shadow	Shadow Vehicle		ARROW BOARD DISPLAT					
Work Vehicle			<b>•</b>	RIGHT Directional				
Heavy Work Vehicle			ŧ	LEFT Directional				
Truck Mounted Attenuator (TMA)			÷	Double Arrow				
Traffic Flow							rnating Corner Fl	ash)
TYPICAL USAGE								
OBILE	SHORT DURATION		T TERM			IATE	LONG TE STATIONA	

ADVANCE WARNING, TRAIL and SHADOW vehicles shall be equipped with Type B or Type C flashing arrow boards as per the Barricade and Construction (BC) standards. Arrow boards on WORK vehicles will be optional based on the type of work being performed. The arrow boards shall be operated from

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2. For TCP(3-2a) the Engineer will determine if the TRAIL VEHICLE is required based on prevailing roadway conditions, traffic volume, and sight distance restrictions. All other vehicles shown for both TCP(3-2a) and TCP(3-2b) are required.

The use of omber high intensity rotating, flashing, oscillating, or strobe lights on vehicles are required. Blue high intensity rotating, flashing, oscillating or strobe lights when mounted on the driver's side of the vehicle may be operated simultaneously with the amber beacons or strobe lights.

The use of truck mounted attenuators (TMA) on the ADVANCE WARNING, SHADOW, and TRAIL vehicles are required.

Reflective sheeting on the rear of the TMA shall meet or exceed the reflectivity and color requirements of DMS 8300, Type A.

Each vehicle shall have two-way radio communication capability.

When work convoys must change lanes, the TRAIL VEHICLE should change lanes first to shadow the other convoy vehicles.

Vehicle spacing between the TRAIL VEHICLE and the SHADOW VEHICLE will vary depending on sight distance restrictions. Motorists approaching the work convoy should be able to see the TRAIL VEHICLE in time to slow down and/or change lanes as they approach the TRAIL VEHICLE. Vehicle spacing between the WORK VEHICLE and SHADOW VEHICLE may vary according to terrain, work activity and other factors.

Standard 48" X 48" diamond shaped warning signs with the same message as those shown may be used where adequate mounting space exists.


10. The signs shown should be used on the Advance Warning Vehicle. As an option, a portable changeable message sign (PCMS) or a truck mounted changeable message sign (TMCMS) with a minimum character height of 12", and displaying the same legend may be substituted for these signs. An appropriate directional arrow display, simulating the size and legibility of the flashing arrow board, must be used in the second phase of the PCMS/IMCMS message. When this is done, the arrow board will not be required on the


11. Standard diamond shape versions of the CW20-5 series signs may be used as an option if the rectangular signs shown are not available.

12. The principles on this sheet may be used to close lanes from the left side of the roadway considering the number of lanes, shoulder width, sight distance, and ramp

13. Signs and flashing arrow board modes shall be appropriately altered when implementing left lane closures or interior closures which close the left lanes.

14. The Advance Warning Vehicle may straddle the edgeline when shoulder width makes it

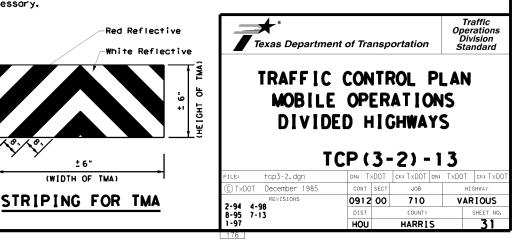

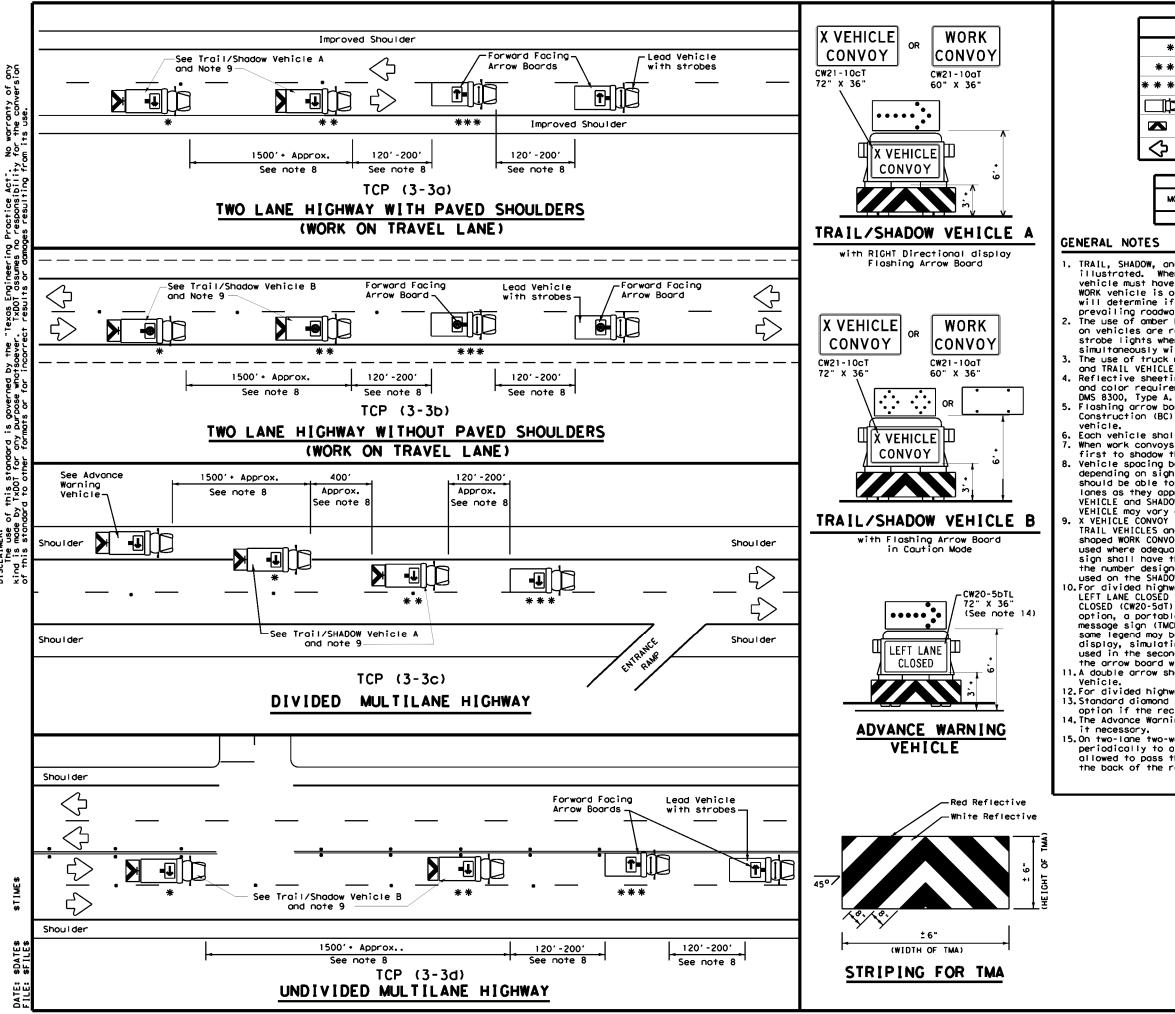

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LEGEND							
*	Trail Vehicle		ARROW BOARD DISPLAY				
* *	Shadow Vehicle	ARROW BUARD DISPLAT					
* * *	Work Vehicle		RIGHT Directional				
□¤	Heavy Work Vehicle		LEFT Directional				
N	Truck Mounted Attenuator (TMA)	<b>₽</b>	Double Arrow				
$\diamond$	Traffic Flow		CAUTION (Alternating Diamond or 4 Corner Flash)				

TYPICAL USAGE								
MOBILE	SHORT DURATION		INTERMEDIATE TERM STATIONARY	LONG TERM STATIONARY				
4								

1. TRAIL, SHADOW, and LEAD vehicles shall be equipped with arrow boards as

illustrated. When a LEAD vehicle is not used on two way roads the WORK vehicle must have an arrow board. For divided roadways, the arrow board on the WORK vehicle is optional based on the type of work being performed. The Engineer will determine if the LEAD vehicle and/or TRAIL vehicle are required based on prevailing roadway conditions, traffic volume, and sight distance restrictions. The use of amber high intensity rotating, flashing, oscillating, or strobe lights on vehicles are required. Blue high intensity rotating, flashing, oscillating, or strobe lights when mounted on the driver's side of the vehicle may be operated simultaneously with the amber beacons or strobe lights. The use of truck mounted attenuators (TMA) on the SHADOW VEHICLE, ADVANCE WARNING

and TRAIL VEHICLE are required. Reflective sheeting on the rear of the TMA shall meet or exceed the reflectivity and color requirements of DEPARTMENTAL MATERIAL SPECIFICATION

Flashing arrow boards shall be Type B or Type C as per the Barricade and Construction (BC) standards. The board shall be controlled from inside the

Each vehicle shall have two-way radio communication capability. When work convoys must change lanes, the TRAIL VEHICLE should change lanes first to shadow the other convoy vehicles. Vehicle spacing between the TRAIL VEHICLE and the SHADOW VEHICLE will vary depending on sight distance restrictions. Motorists approaching the convoy should be able to see the TRAIL VEHICLE in time to slow down and/or change lange as they approach the TRAIL VEHICLE in time to slow down and/or change lanes as they approach the TRAIL VEHICLE. Vehicle spacing between the WORK VEHICLE and SHADOW VEHICLE and vehicle spacing between WORK VEHICLE and LEAD VEHICLE may vary according to terrain, work activity and other factors. X VEHICLE CONVOY (CW21-10cT) or WORK CONVOY (CW21-10aT) signs shall be used on TRAIL VEHICLES and SHADOW VEHICLES as shown. As an option 48" x 48" diamond shaped WORK CONVOY (CW21-10T) or X VEHICLE CONVOY (CW21-10bT) signs may be used where adequate mounting space exists. When used, the X VEHICLE CONVOY sign shall have the number of the convoy vehicles displayed on the sign in the number designation "X" location. The X VEHICLE CONVOY sign shall not be used on the SHADOW VEHICLE if a TRAIL VEHICLE is used. 0.For divided highways with two or three lances in one direction, the appropriate LEFT LANE CLOSED (CW20-5bTL), RIGHT LANE CLOSED (CW20-5bTR), or CENTER LANE CLOSED (CW20-5dT) sign should be used on the Advance Warning Vehicle. As an


option, a portable changeable message sign (PCMS) or truck mounted changeable message sign (TMCMS) with a minimum character height of 12", and displaying the same legend may be substituted for these signs. An appropriate directional arrow display, simulating the size and legibility of the flashing arrow board may be used in the second phase of the PCMS/TMCMS message. When this is done, the arrow board will not be required on the Advance Warning Vehicle.

11.A double arrow shall not be displayed on the arrow board on the Advance Warning

12.For divided highways with three or four lanes in each direction, use TCP(3-2). 13. Standard diamond shape versions of the CW20-5 series signs may be used as an option if the rectangular signs shown are not available. 14. The Advance Warning Vehicle may straddle the edgeline when Shoulder width makes

15.0n two-lane two-way roadways, the work and protection vehicles should pull over periodically to allow motor vehicle traffic to pass. If motorists are not allowed to pass the work convoy, a DO NOT PASS (R4-1) sign should be placed on the back of the rearmost protection vehicle.

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HOU	HARRIS		32
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LEGEND					
il Vehicle		ARROW BOARD DISPLAY			
Jow Vehicle		ARROW BOARD DISPLAT			
k Vehicle	•	RIGHT Directional			
vy Work Vehicle	-	LEFT Directional			
ck Mounted enuator (TMA)	<b>+</b>	Double Arrow			
ffic Flow		Channelizing Devices			

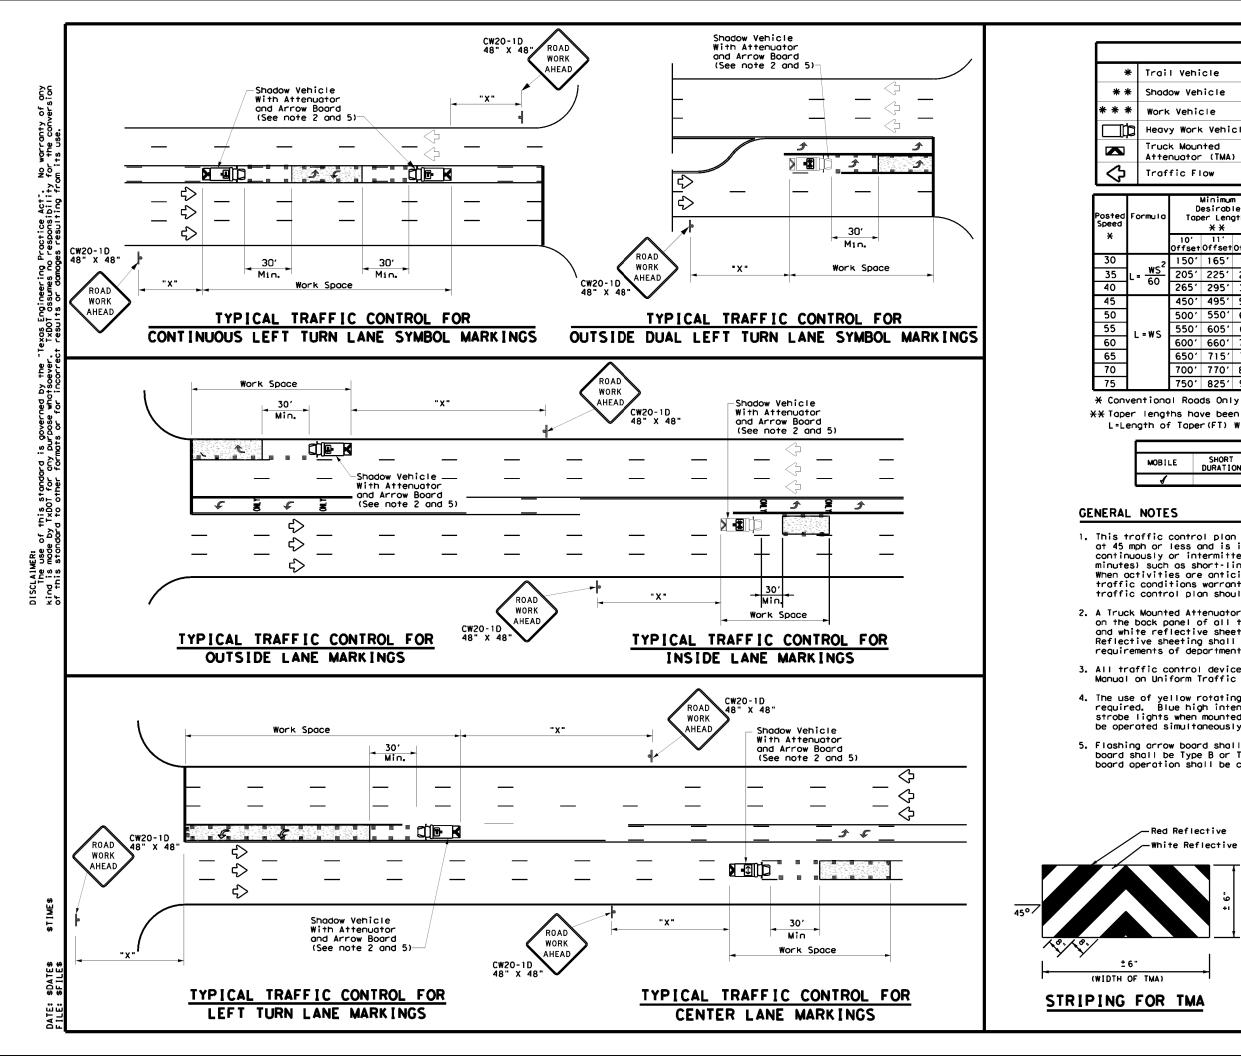_	D	Minimur esirab er Lena X X	le	Spacir Channe		Minimum Sign Spacing "x"	Suggested Longitudinal Buffer Space
	10' Offset	11' Offset	12' Offset	On a Taper	On a Tangent	Distance	-B.,
	150'	165'	180'	30'	60 <i>'</i>	1201	90'
	205'	225'	245'	35′	70 <i>'</i>	1601	120'
	265 <i>'</i>	295'	320'	40'	80'	240'	1551
	450'	4951	540'	45′	90'	320'	1951
	500'	550'	600 <i>'</i>	50'	100'	400'	240'
	550'	605 <i>'</i>	660'	55 <i>'</i>	110'	500'	295′
	600 <i>'</i>	660'	720'	60′	120'	600 <i>'</i>	350′
	650 <i>'</i>	715′	780'	65′	130'	700'	410′
	700'	770′	840′	70'	140′	800'	475′
	750'	8251	900'	75'	150'	900'	540'

XX Taper lengths have been rounded off.

L=Length of Taper(FT) W=Width of Offset(FT) S=Posted Speed(MPH)

		TYPICAL U	ISAGE	
LE	SHORT DURATION		INTERMEDIATE TERM STATIONARY	LONG TERM STATIONARY
,				

1. This traffic control plan is for use on conventional roads posted at 45 mph or less and is intended for mobile operations that move continuously or intermittently (stopping up to approximately 15 minutes) such as short-line striping and in-lane rumble strips. When activities are anticipated to take longer amounts of time or traffic conditions warrant, a short duration or short-term stationary traffic control plan should be used.


2. A Truck Mounted Attenuator shall be used on Shadow Vehicle. Striping and white reflective sheeting placed in an inverted "V" design. Reflective sheeting shall meet or exceed the reflectivity and color requirements of departmental material specification DMS-8300, Type A.


3. All traffic control devices shall be in accordance with the "Texas Monual on Uniform Traffic Control Devices" (TMUTCD), latest edition.


4. The use of yellow rotating beacons or strobe lights on vehicles are required. Blue high intensity rotating, flashing, oscillating or strobe lights when mounted on the drivers side of the vehicle may be operated simultaneously with the amber beacons or strobe lights.


5. Flashing arrow board shall be used on Shadow Vehicle. Flashing arrow board shall be Type B or Type C as per BC Standards. The arrow board operation shall be controlled from inside the truck.


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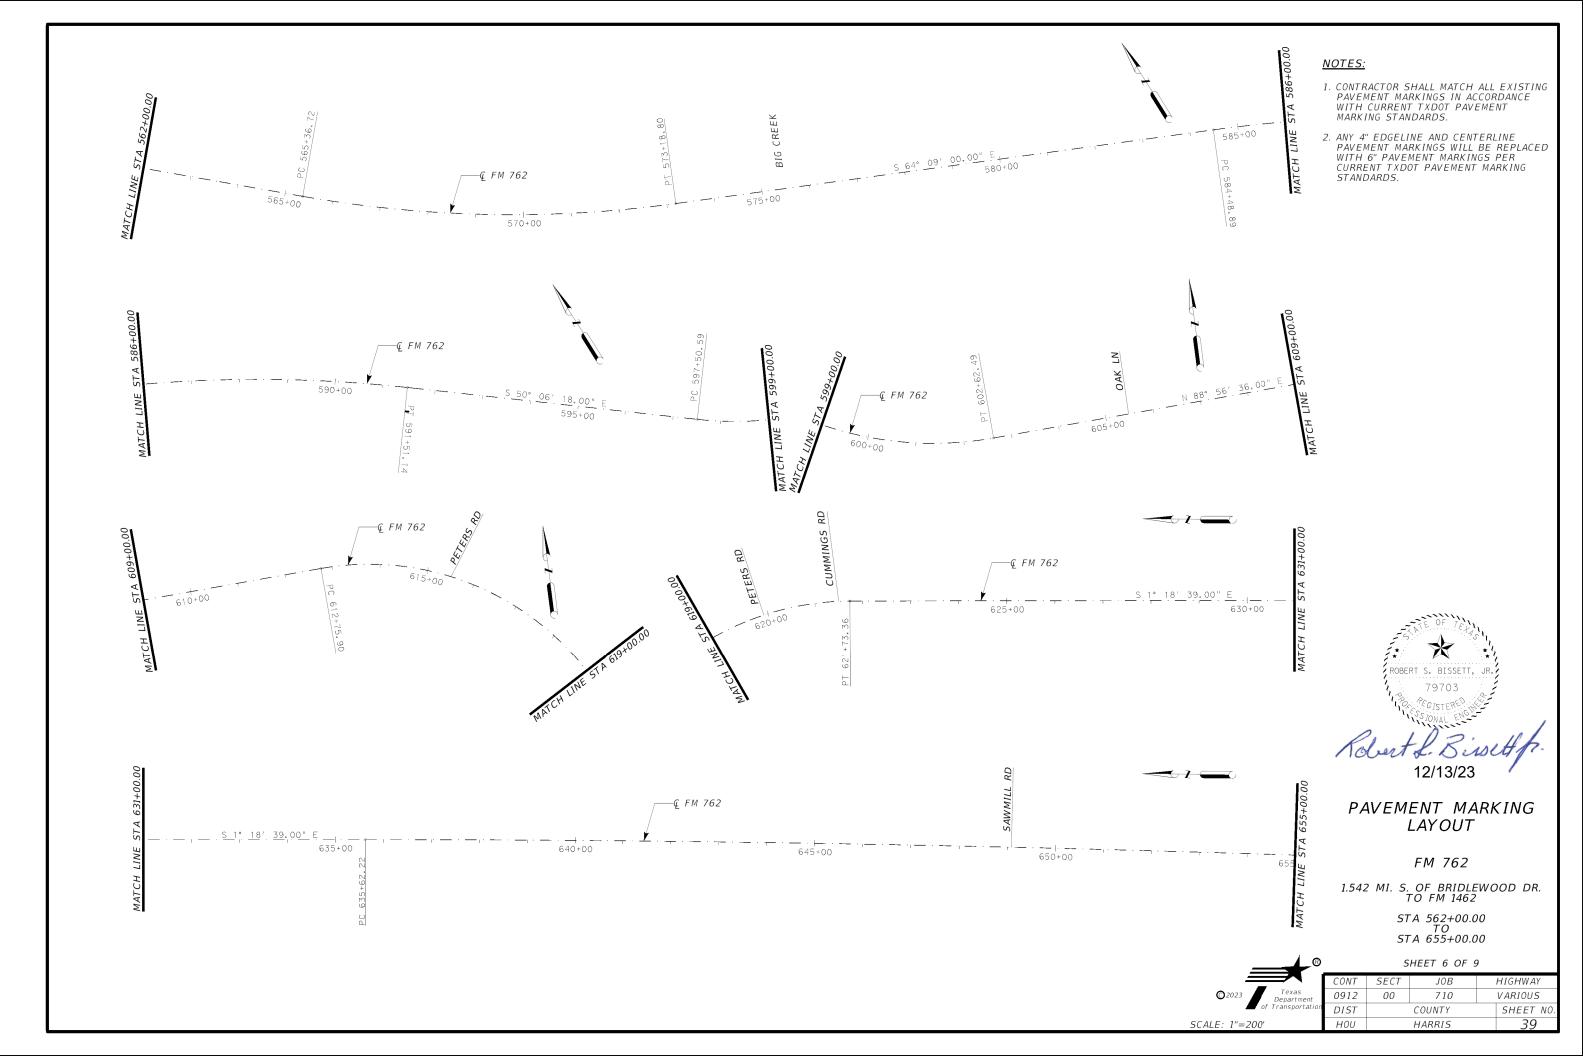


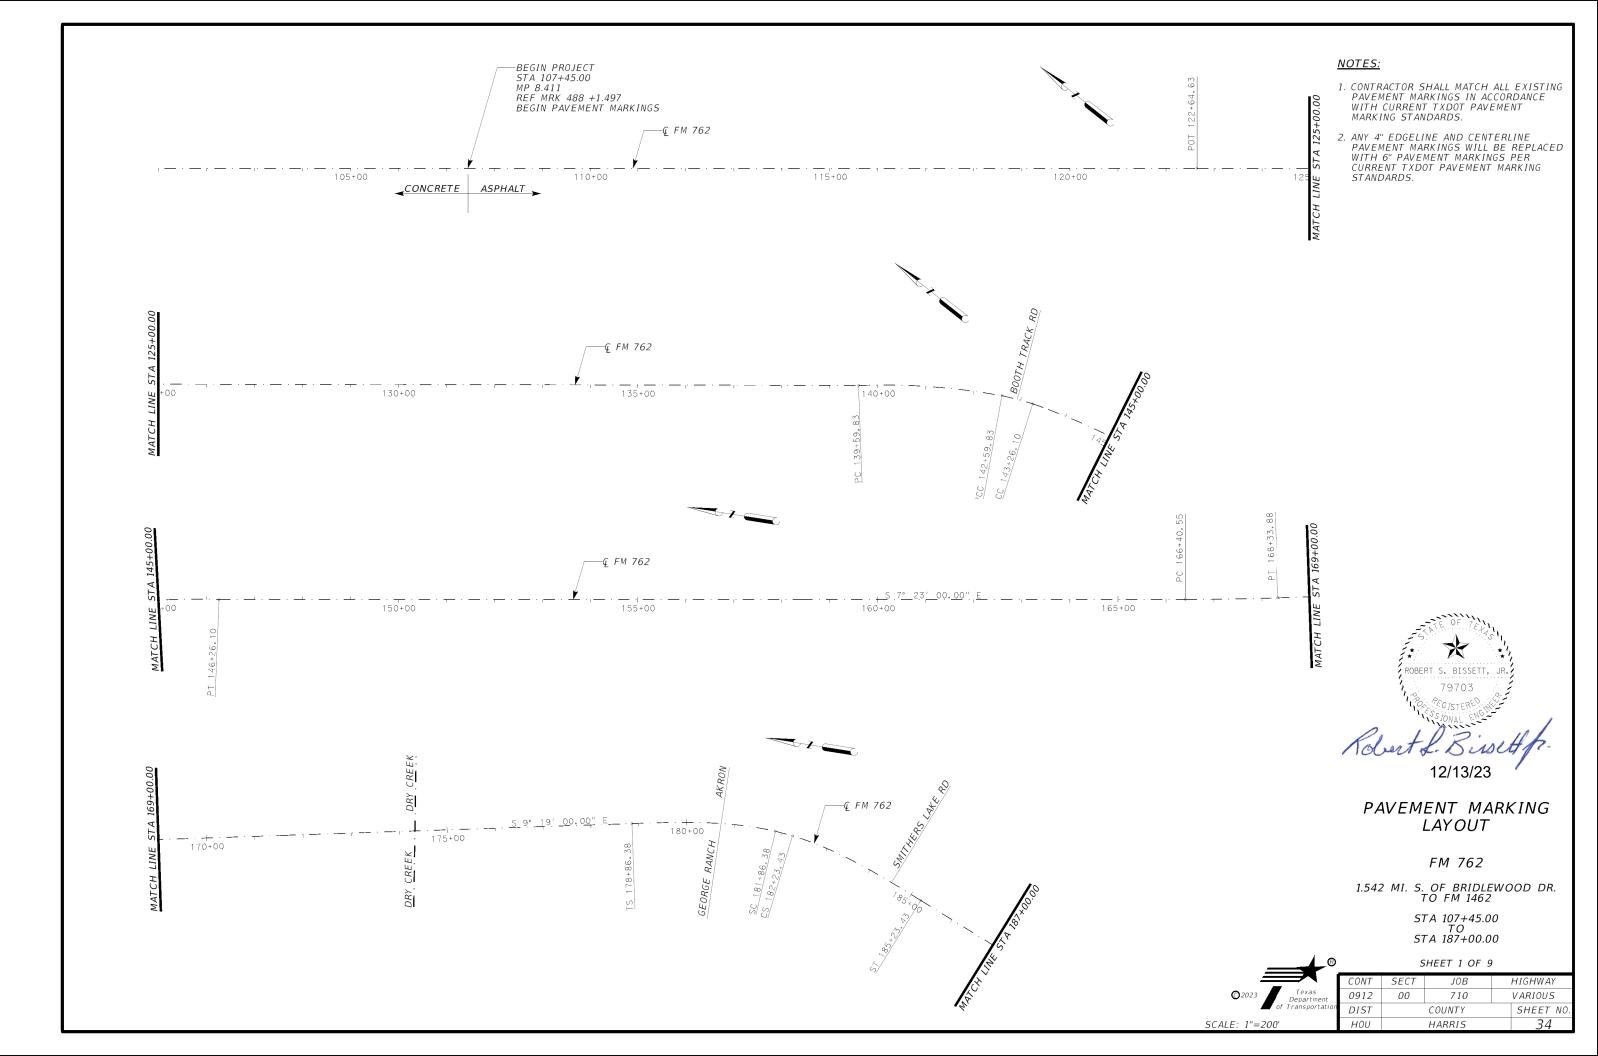


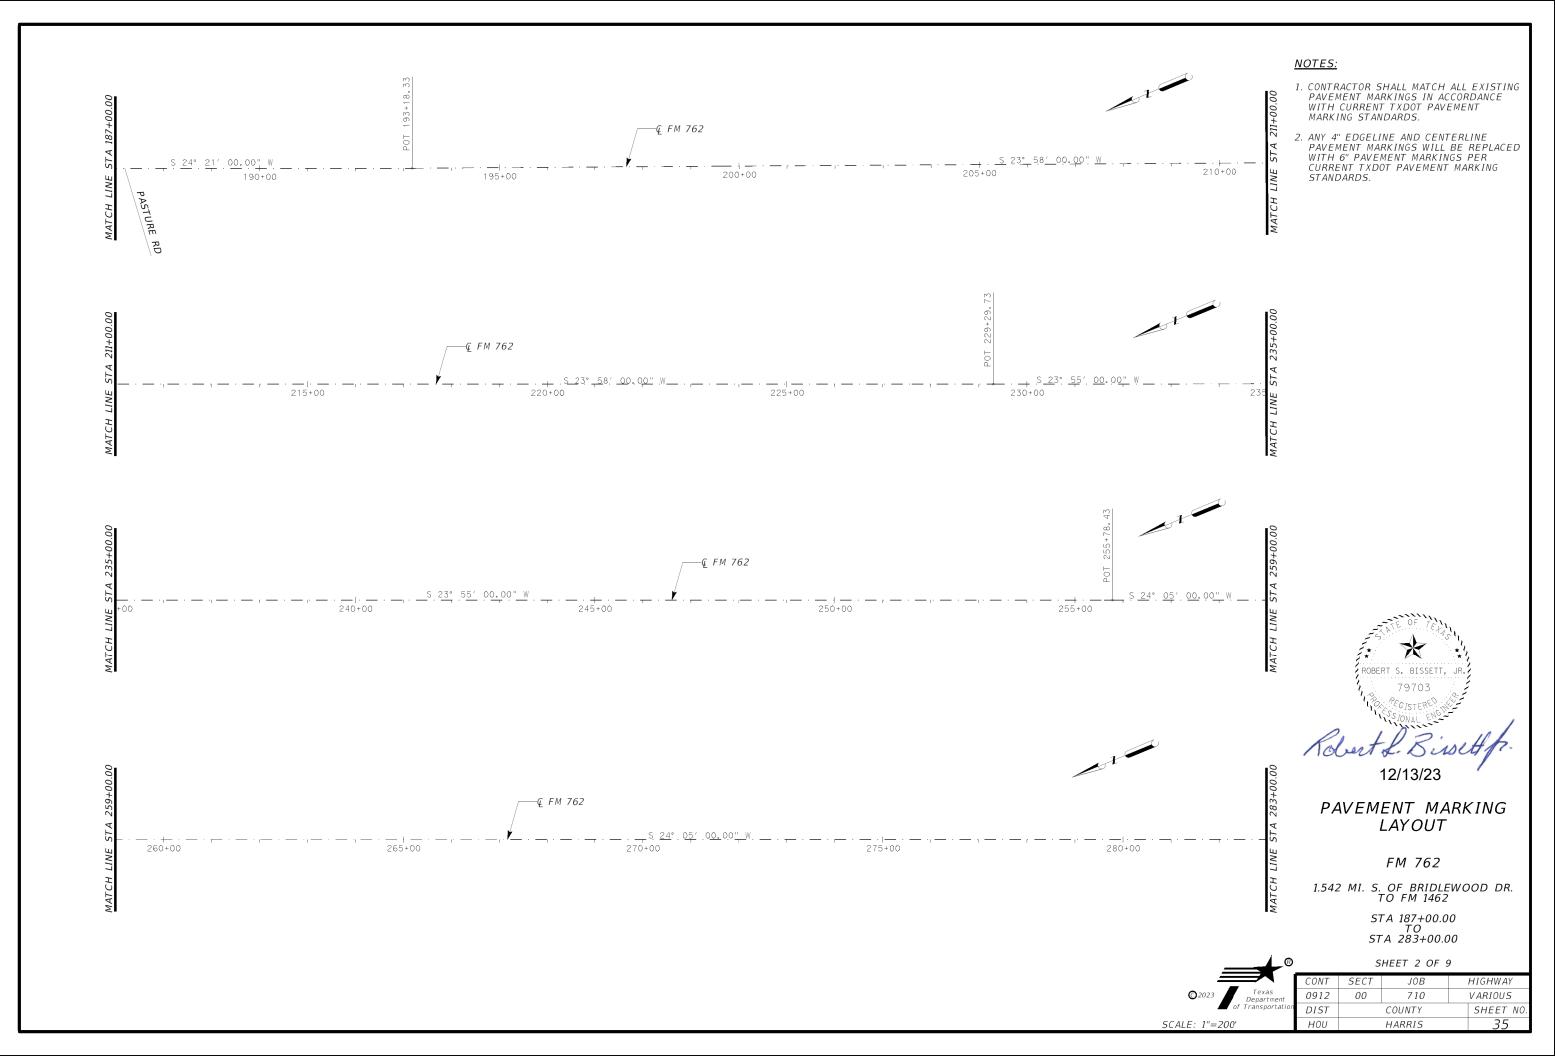


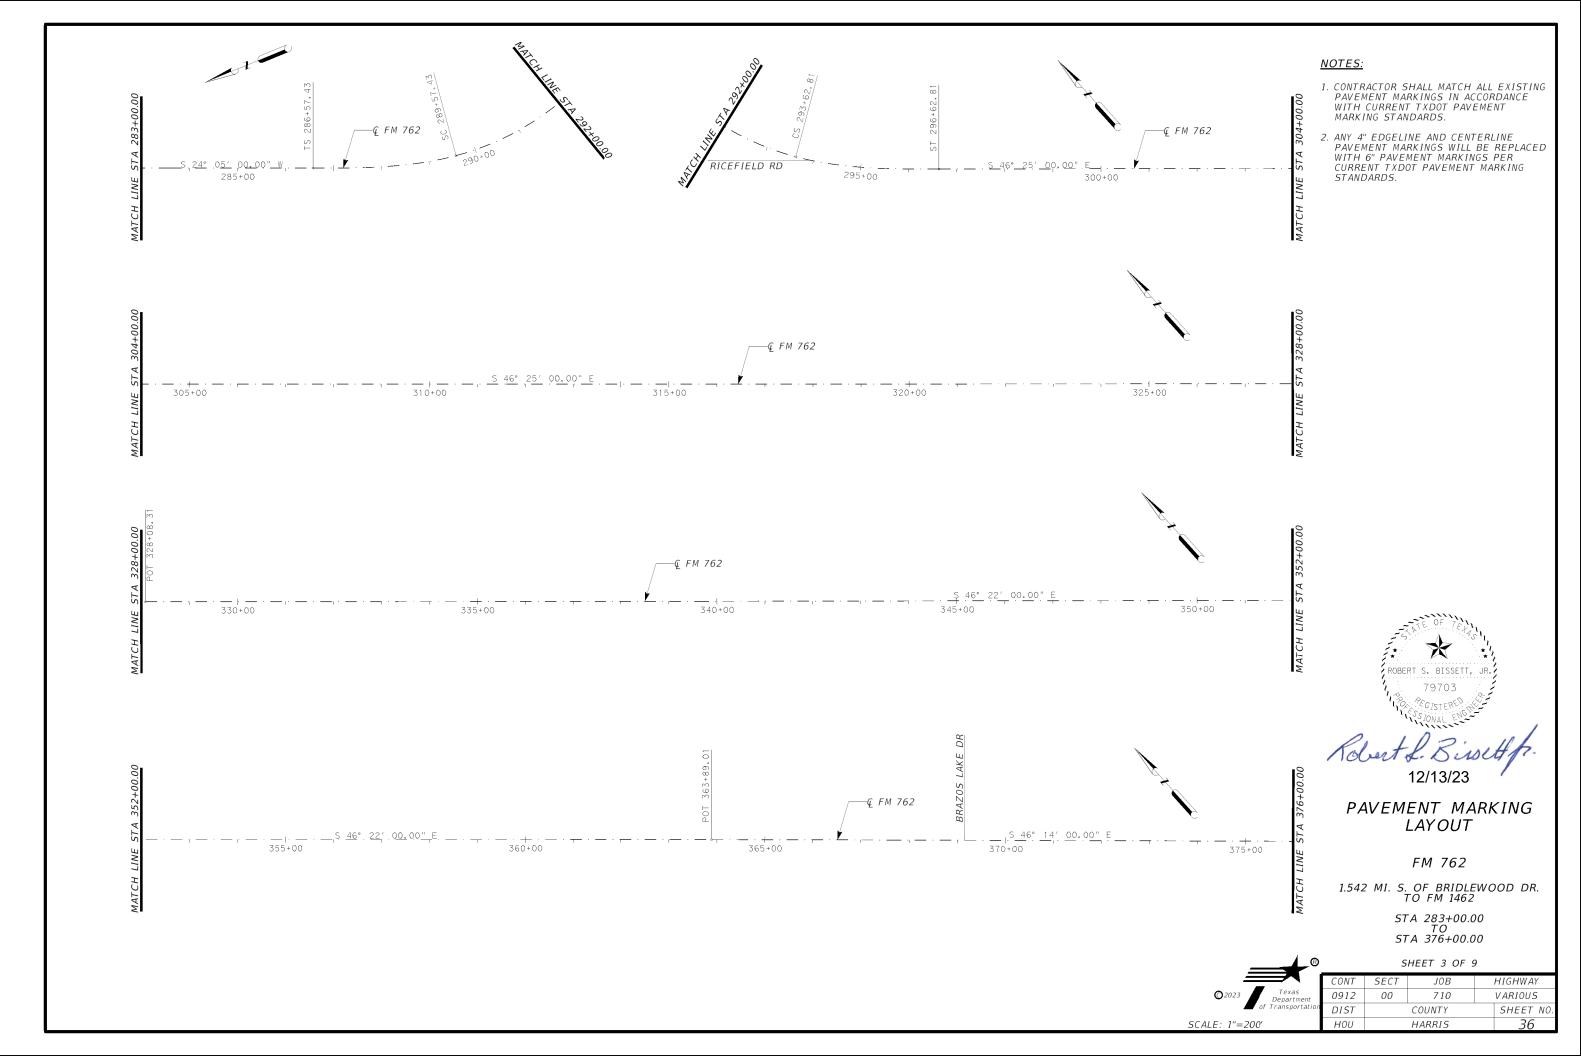


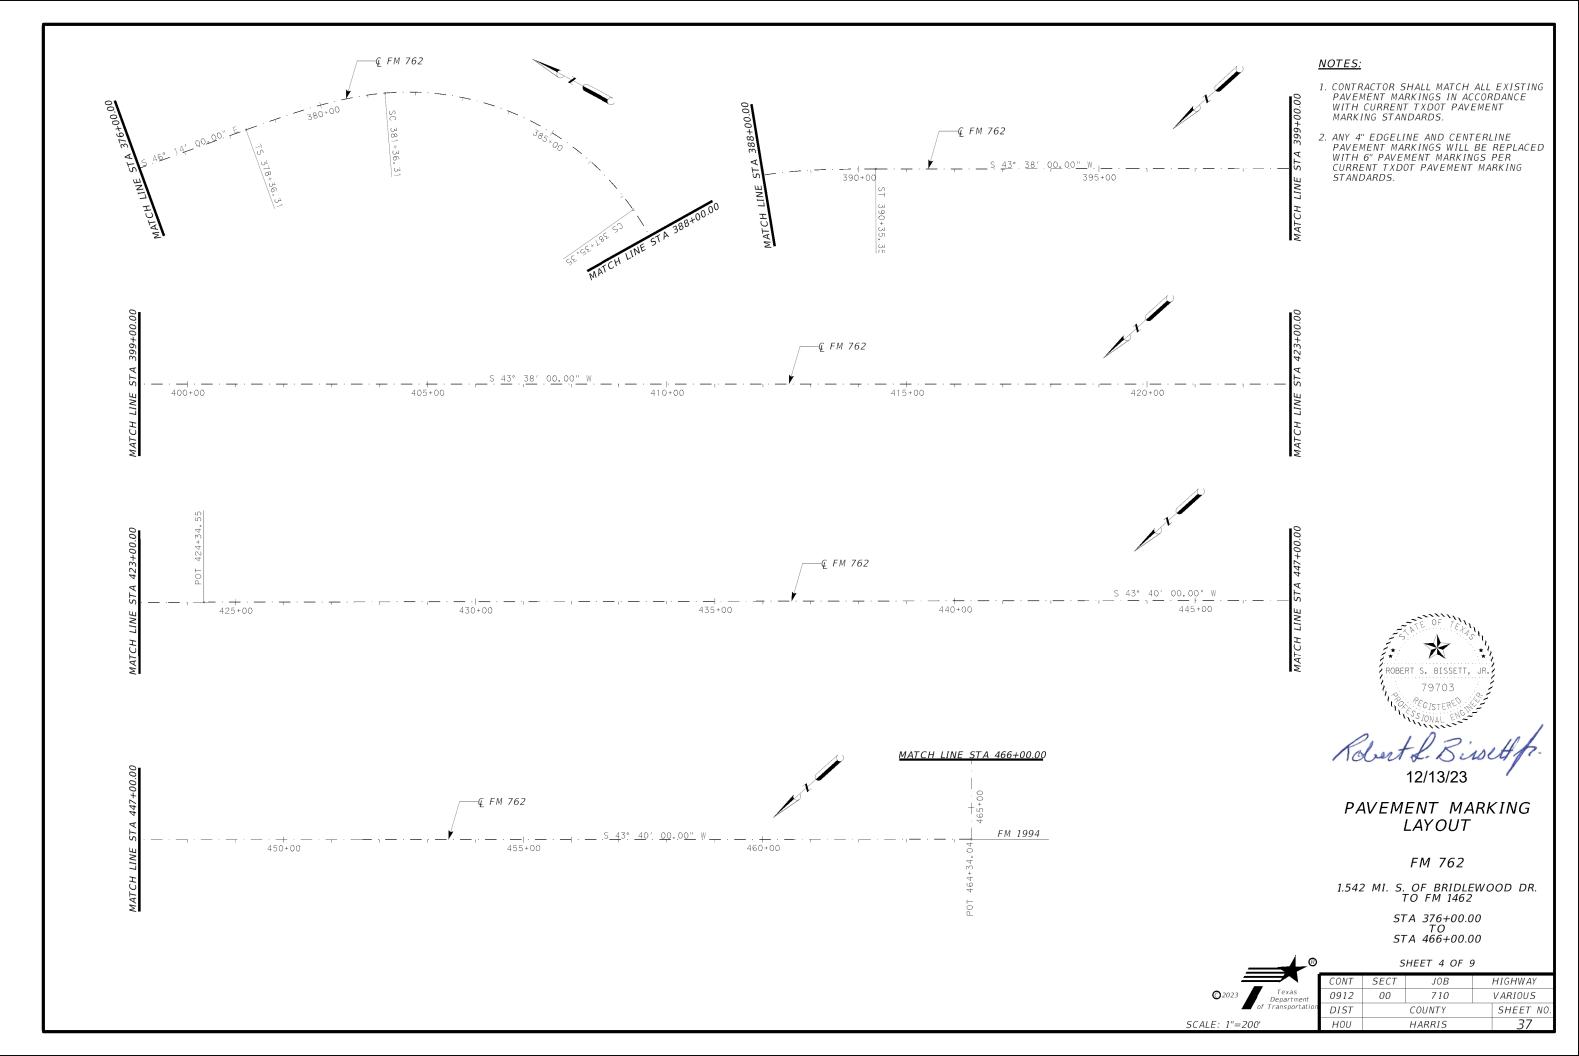


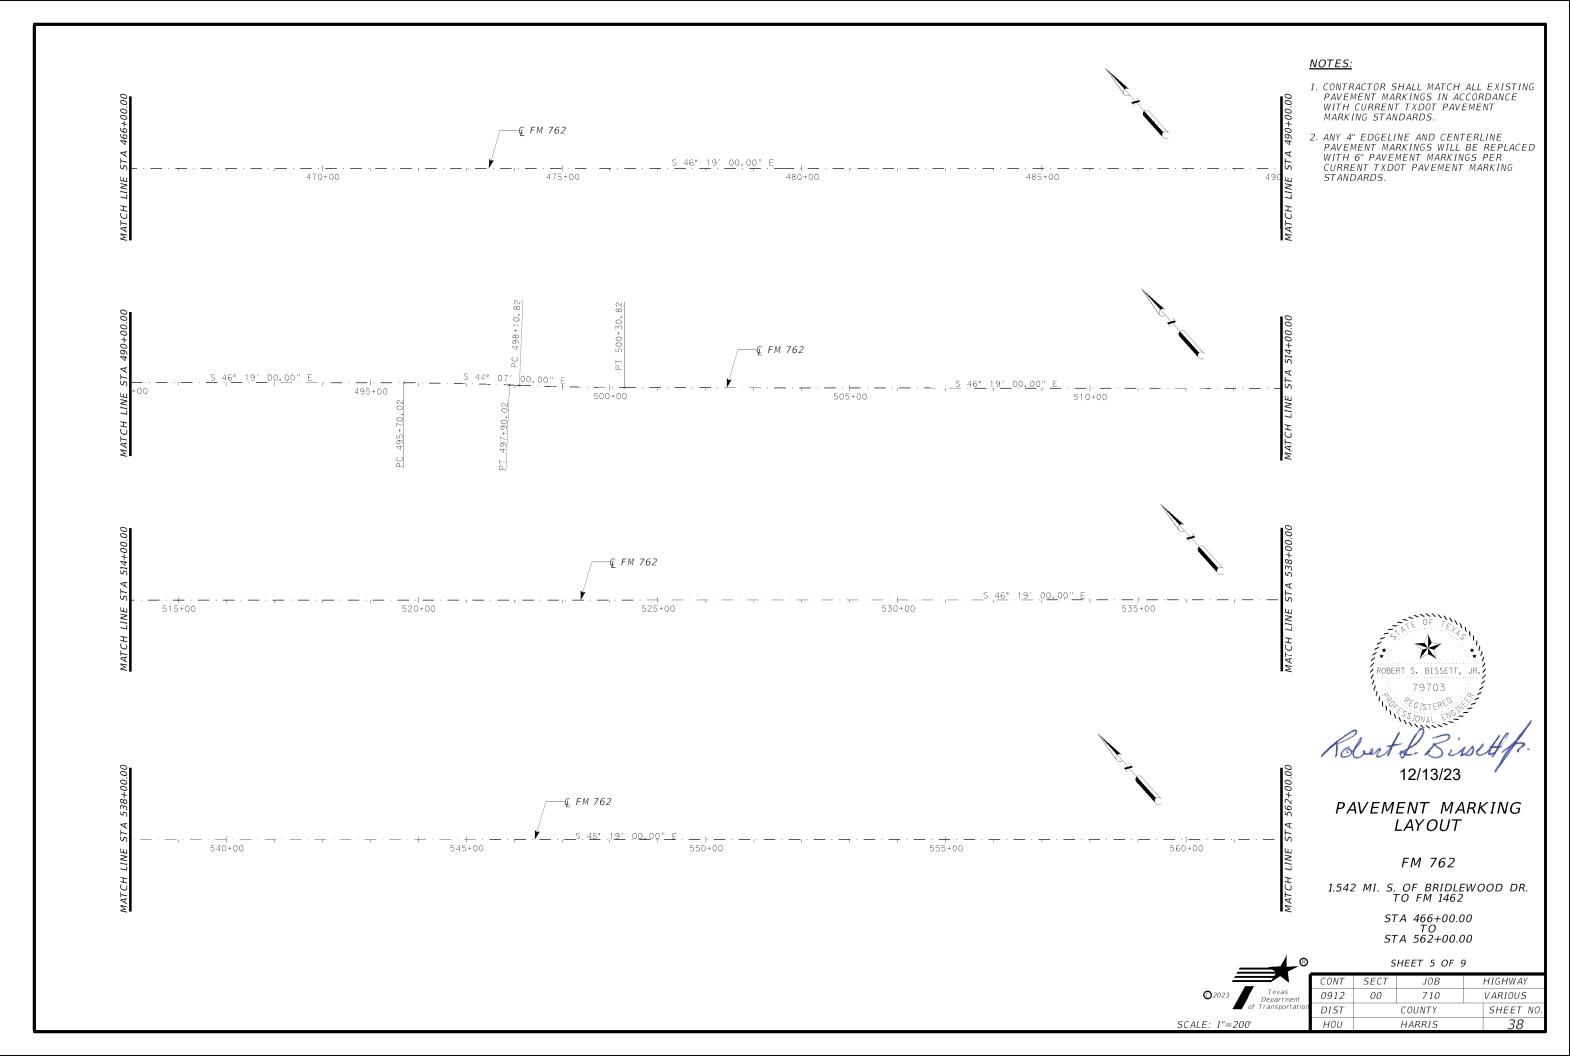


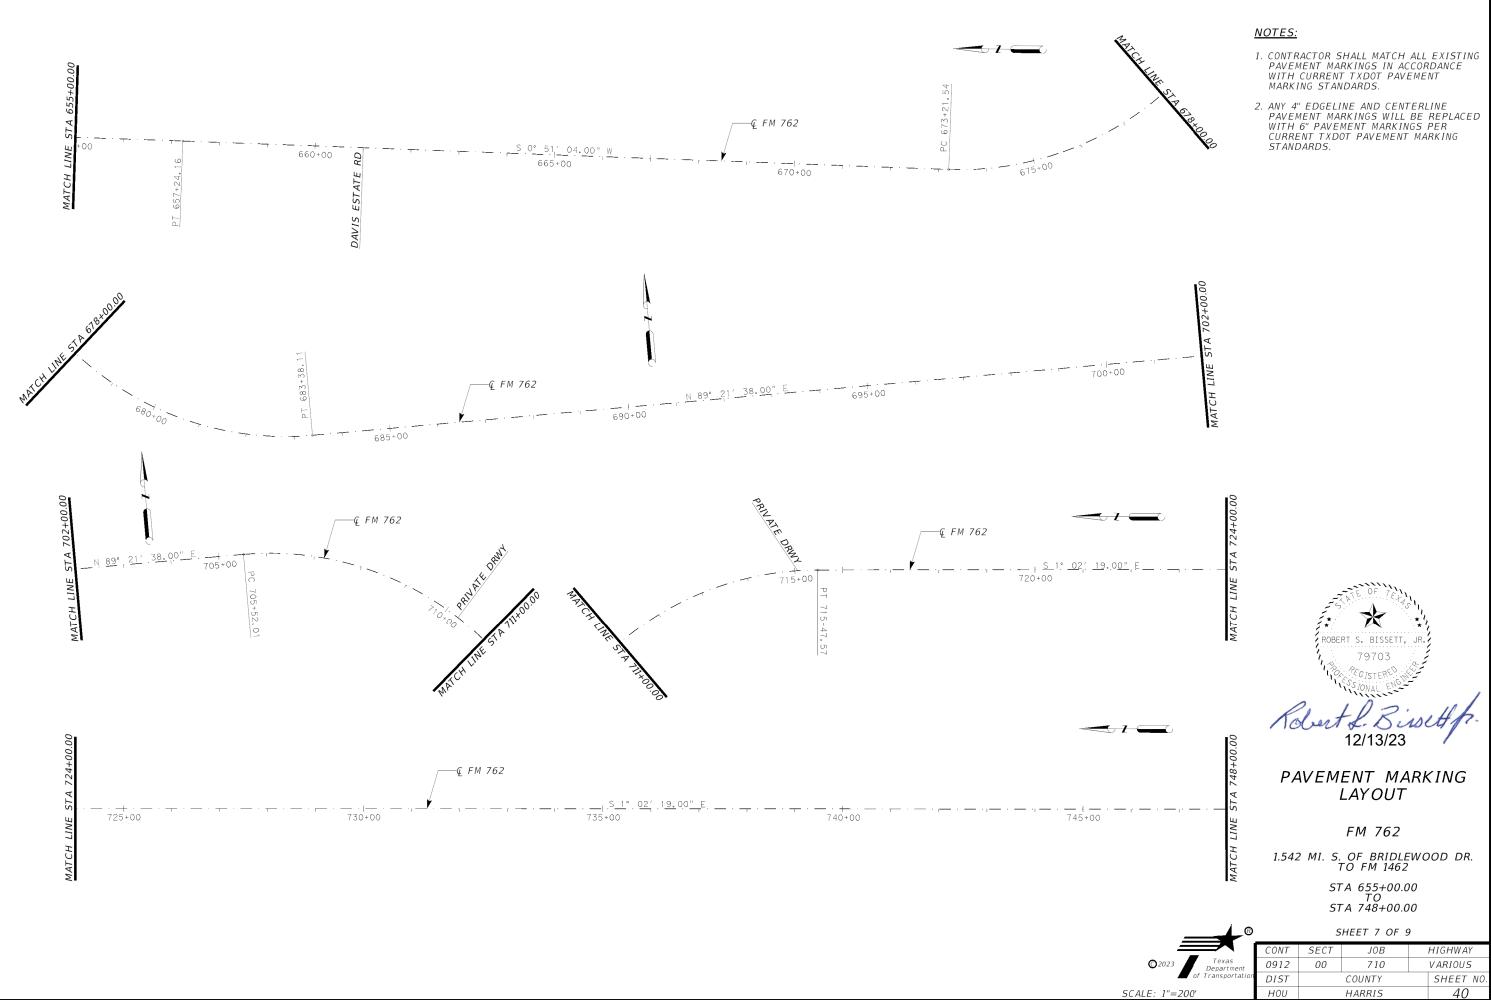


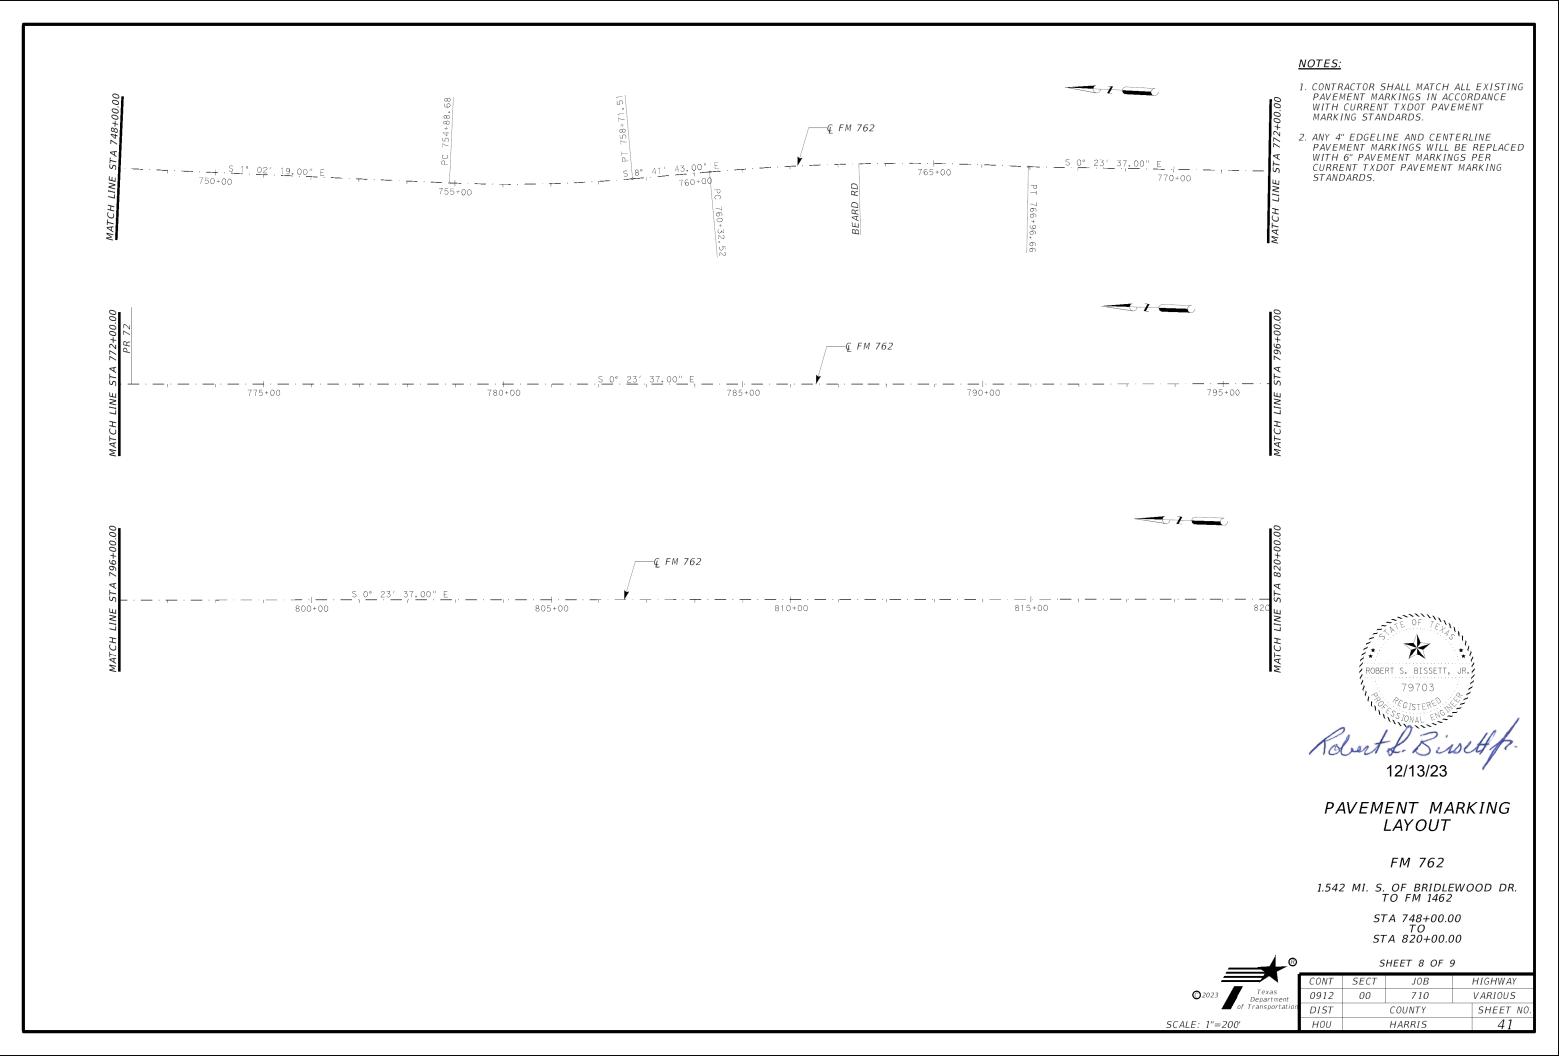


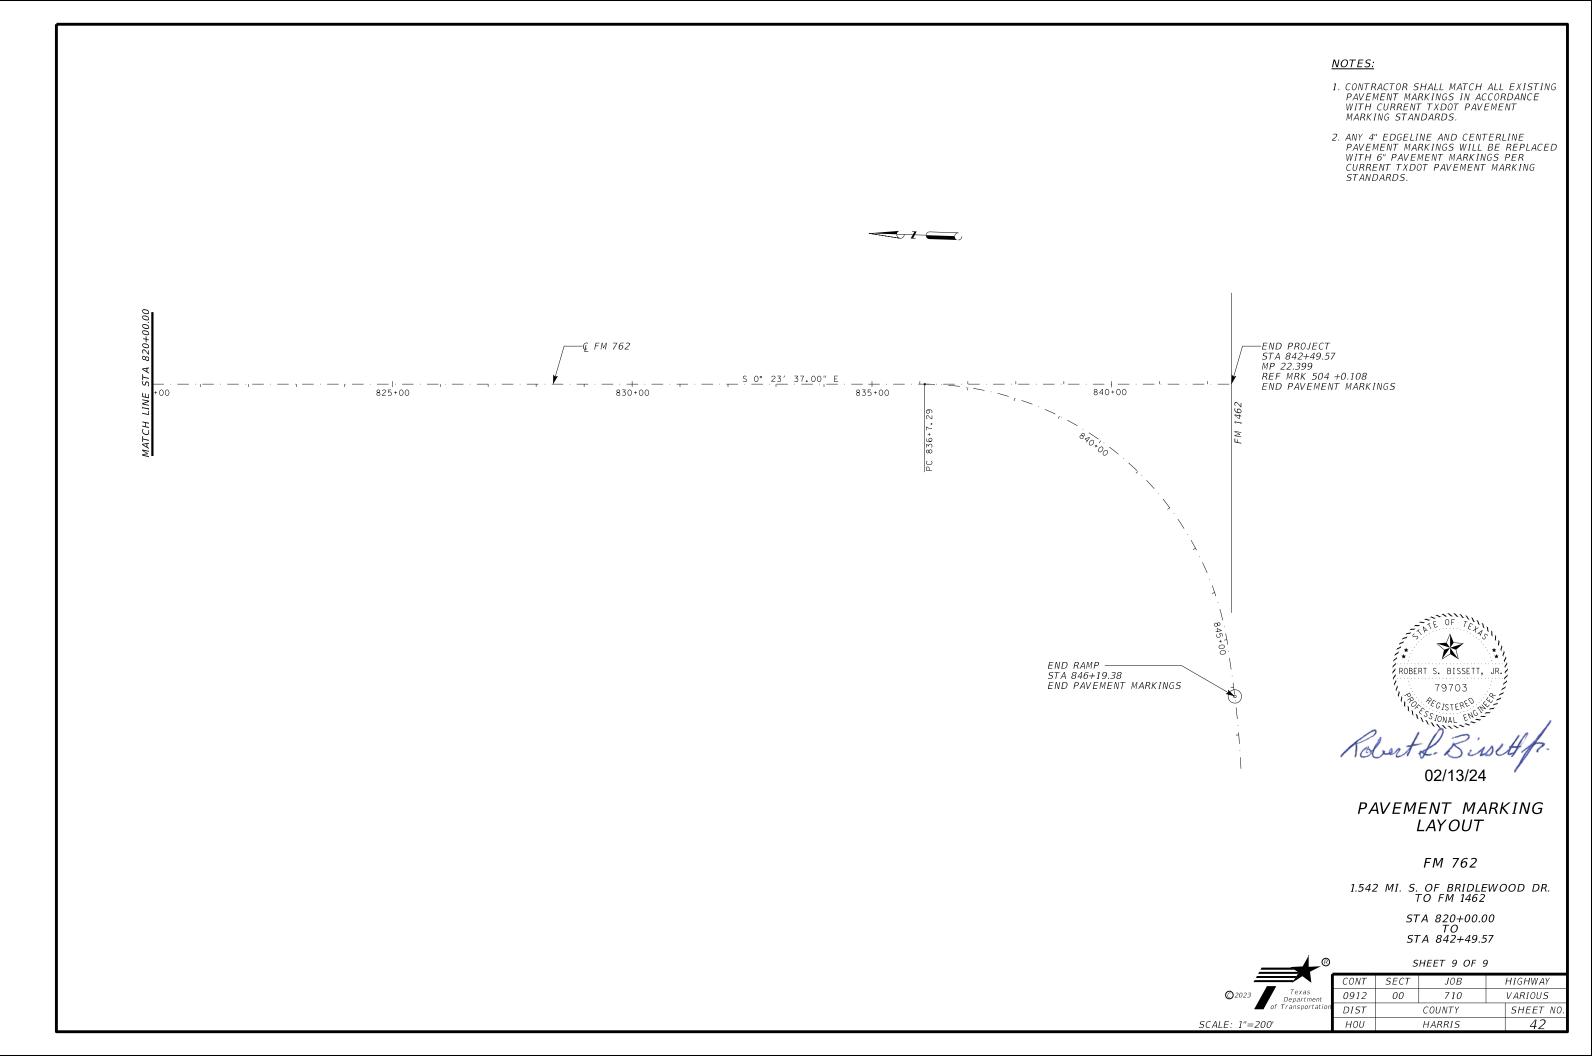

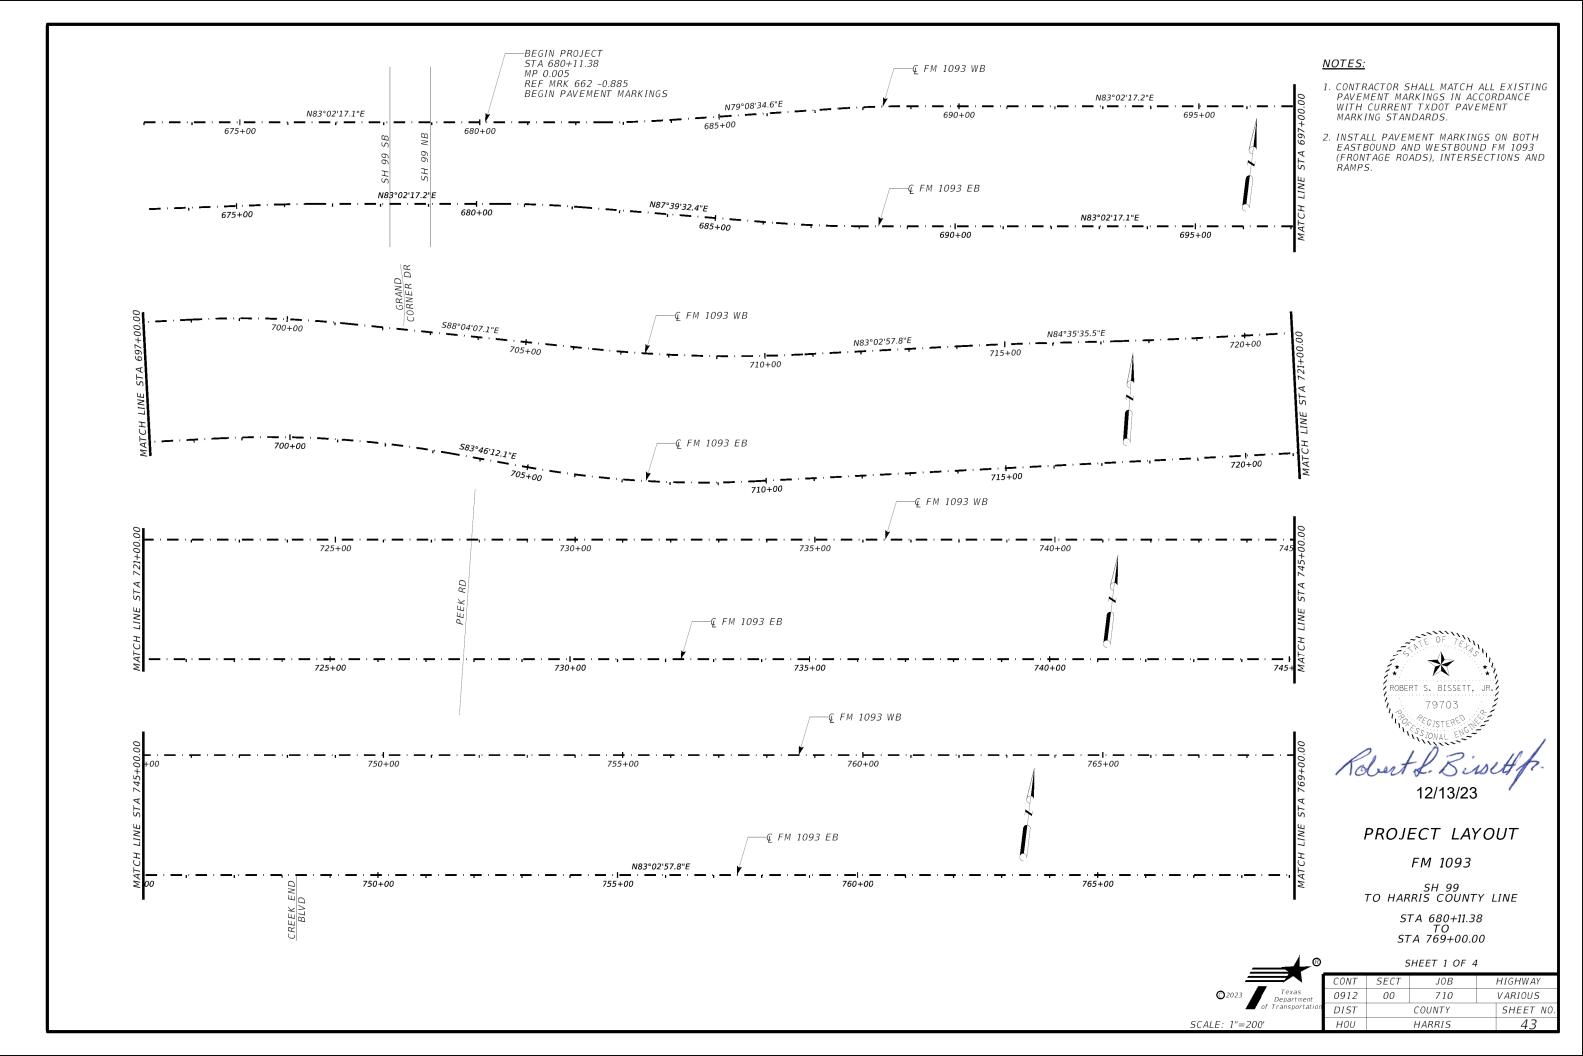

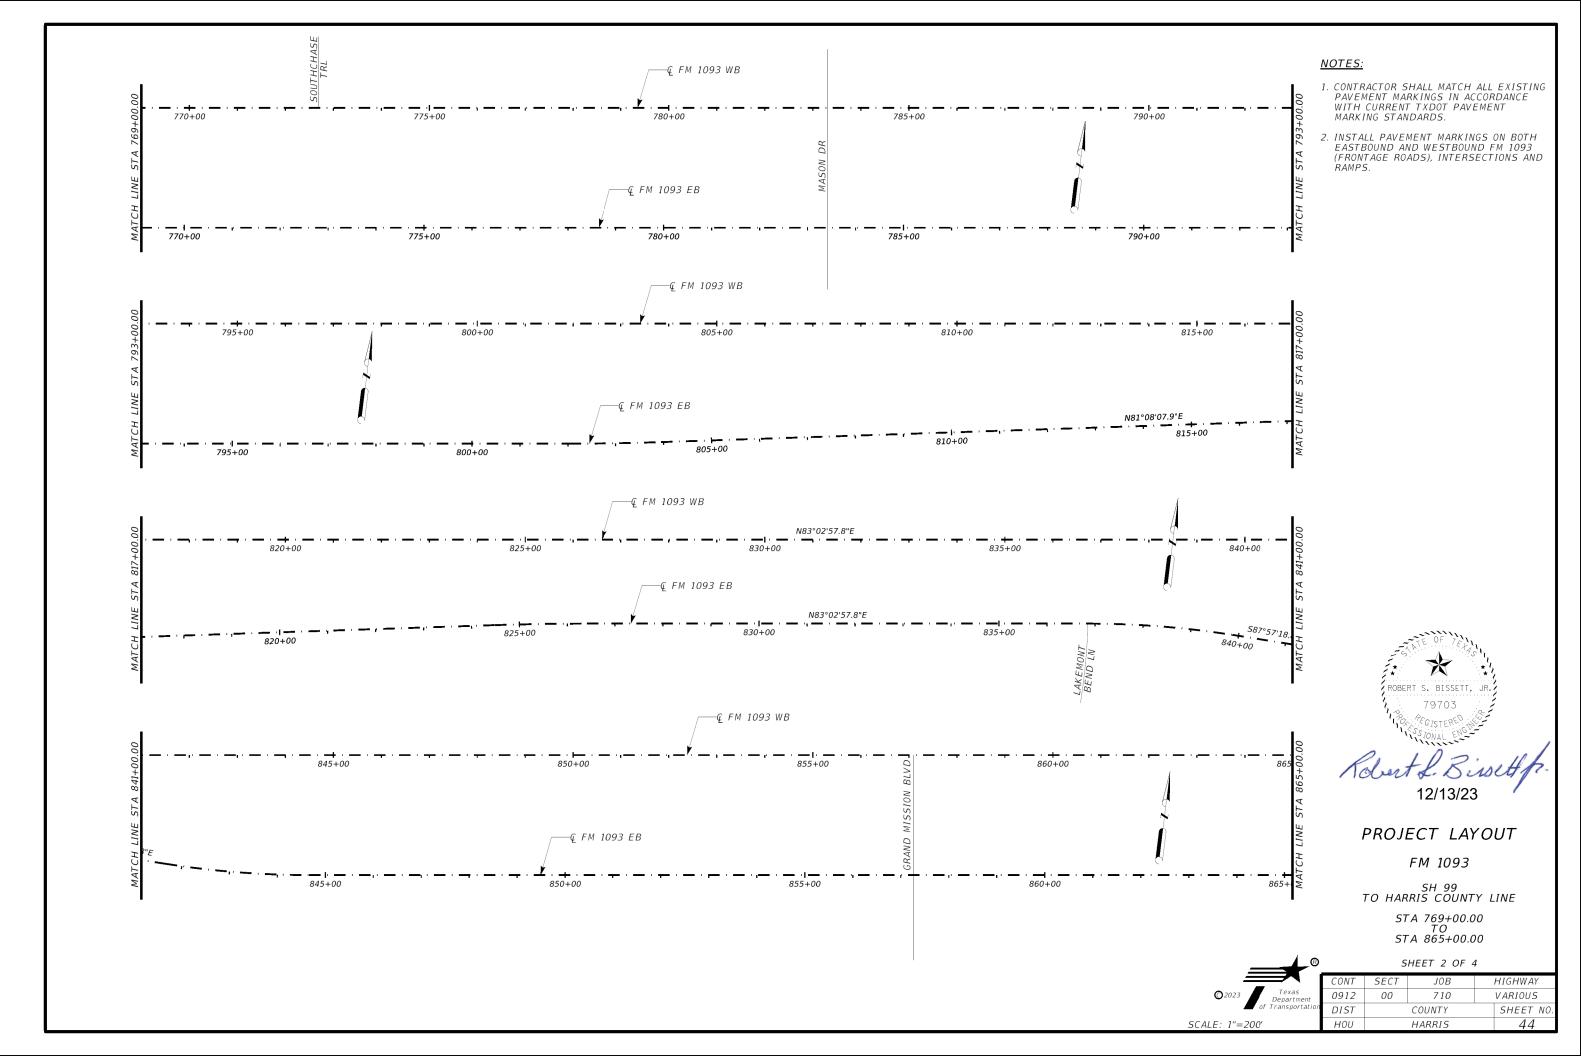


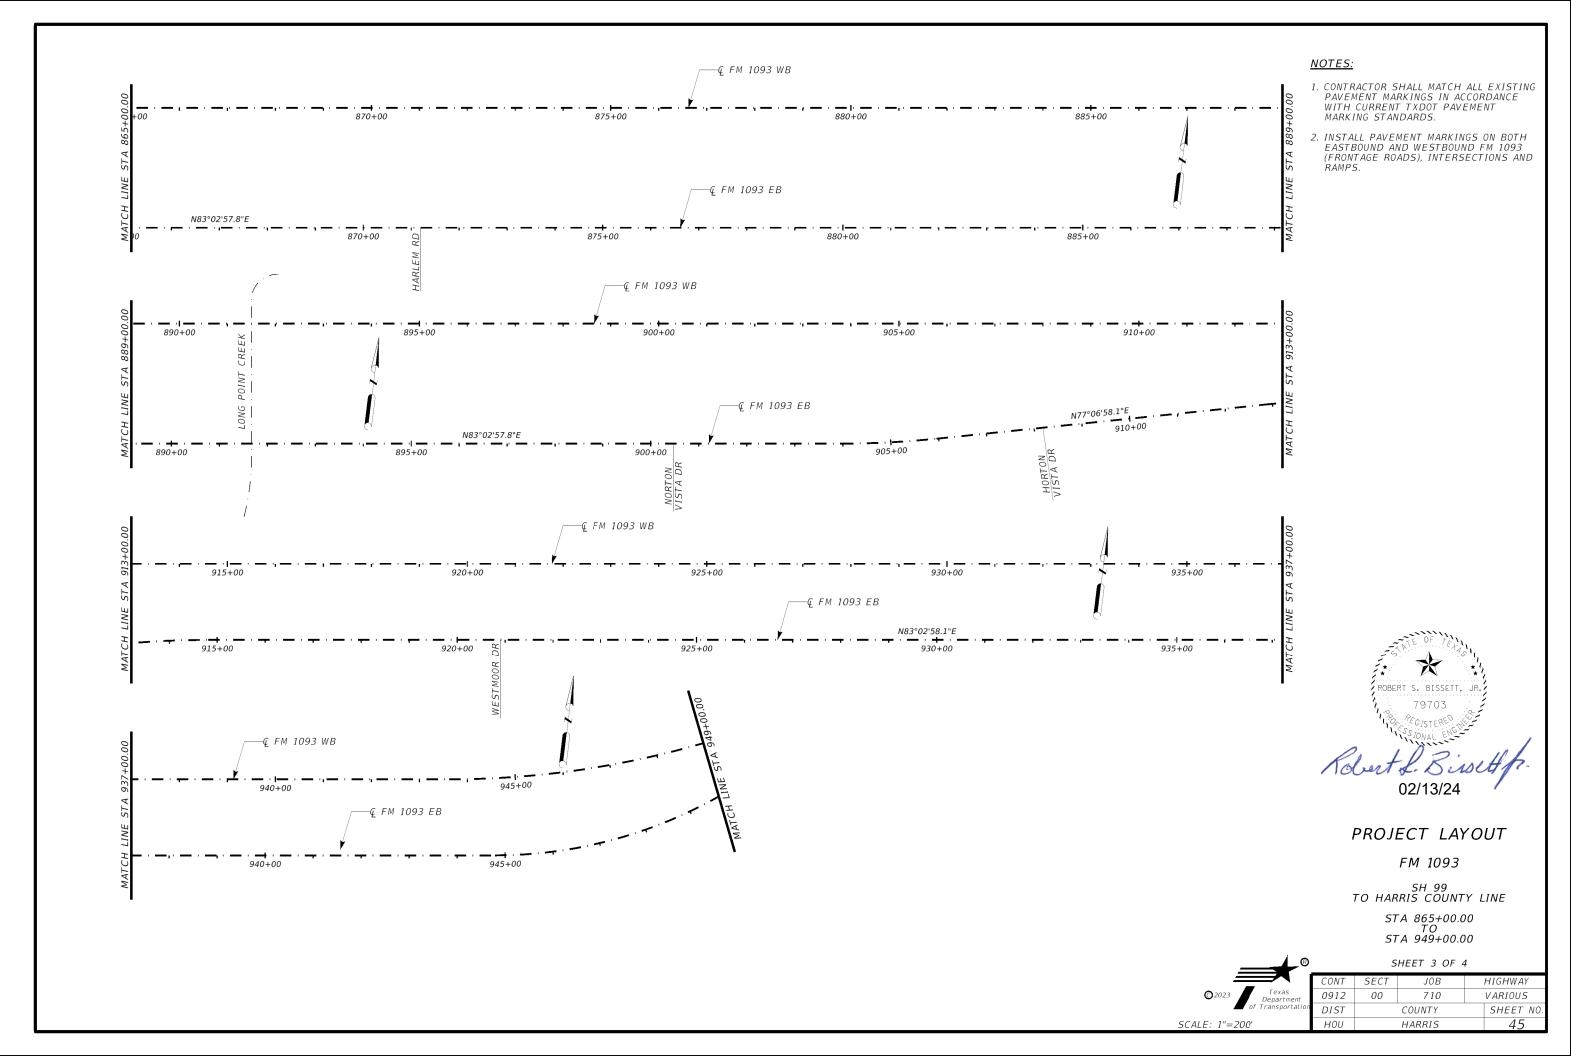

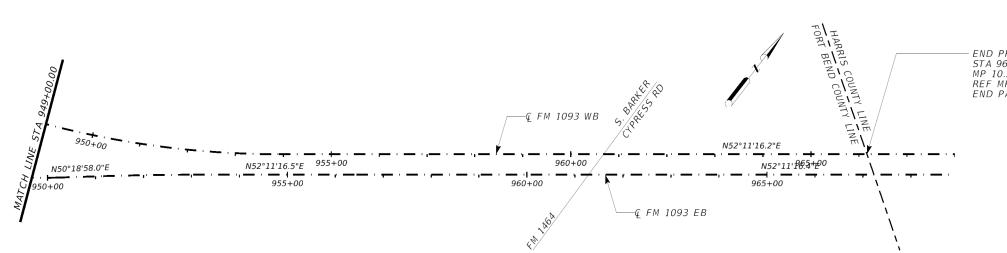

- 1. CONTRACTOR SHALL MATCH ALL EXISTING PAVEMENT MARKINGS IN ACCORDANCE WITH CURRENT TXDOT PAVEMENT MARKING STANDARDS.
- 2. INSTALL PAVEMENT MARKINGS ON BOTH EASTBOUND AND WESTBOUND FM 1093 (FRONTAGE ROADS), INTERSECTIONS AND RAMPS.

– END PROJECT STA 966+16.82 MP 10.399 REF MRK 668 -0.026 END PAVEMENT MARKINGS

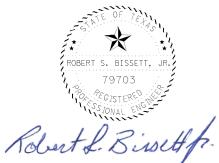


12/13/23


## PROJECT LAYOUT


### FM 1093


SH 99 TO HARRIS COUNTY LINE SSTA 949+00.00 TO STA 966+16.82

		S	HEET 4 OF 4	1	
	CONT	SECT	JOB		HIGHWAY
© 2023 Texas Department of Transportation	0912	00	710		VARIOUS
of Transportation	DIST		COUNTY		SHEET NO.
SCALE: 1"=200'	HOU		HARRIS		46

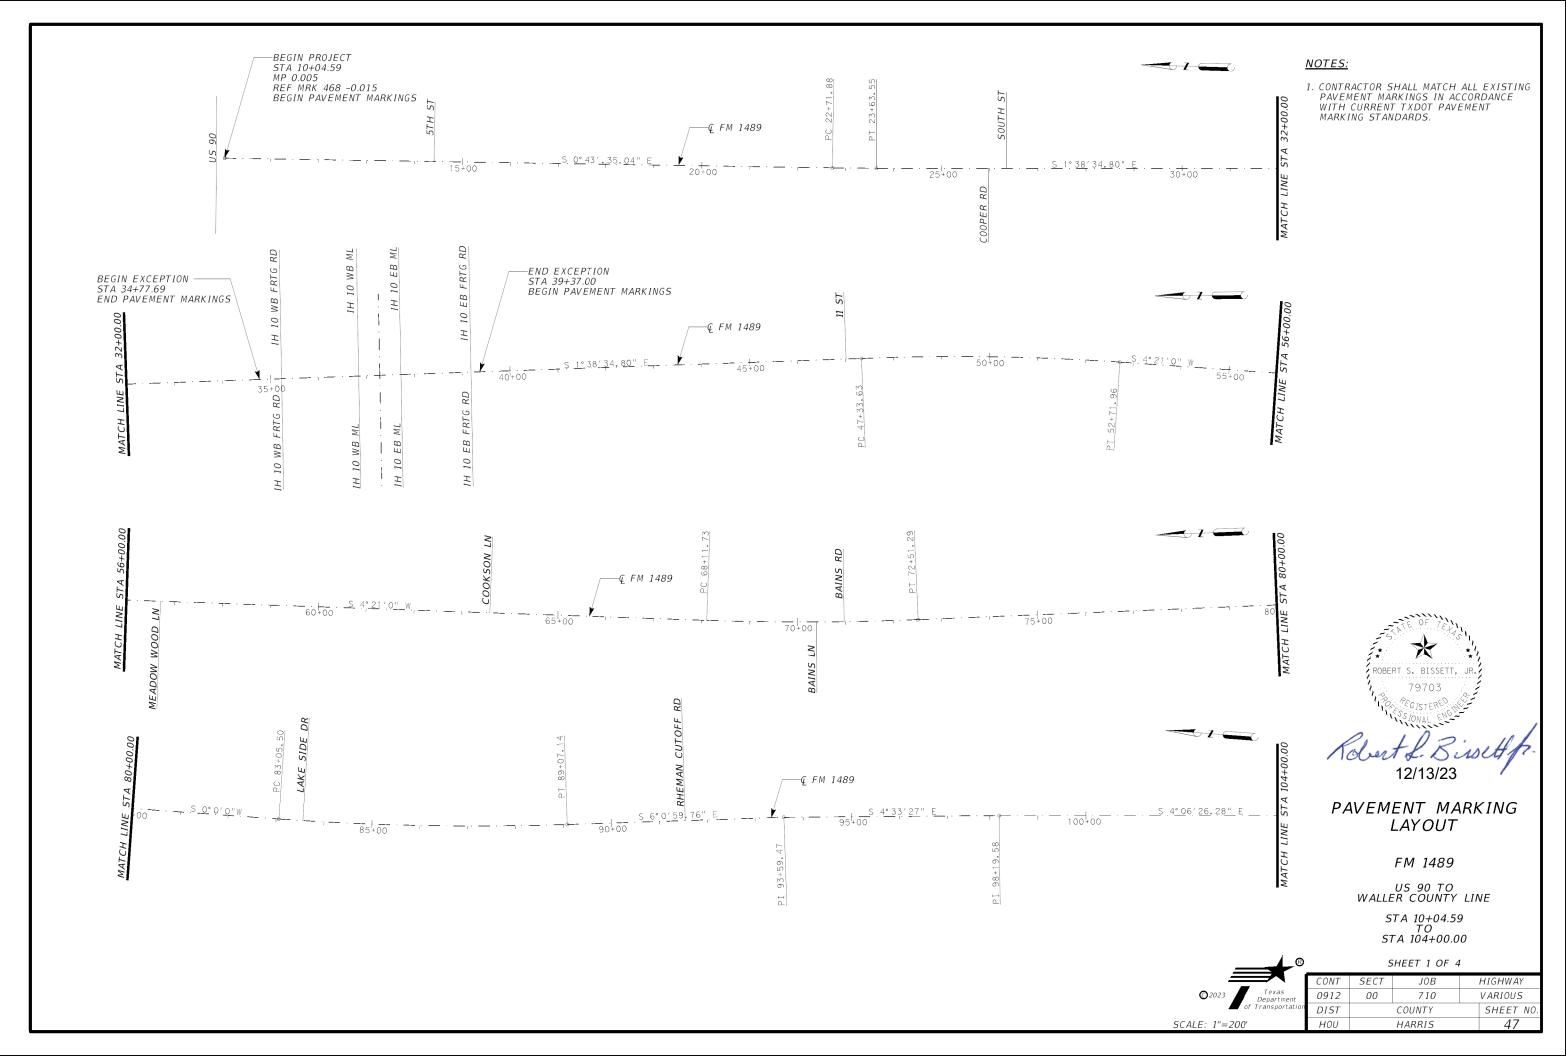


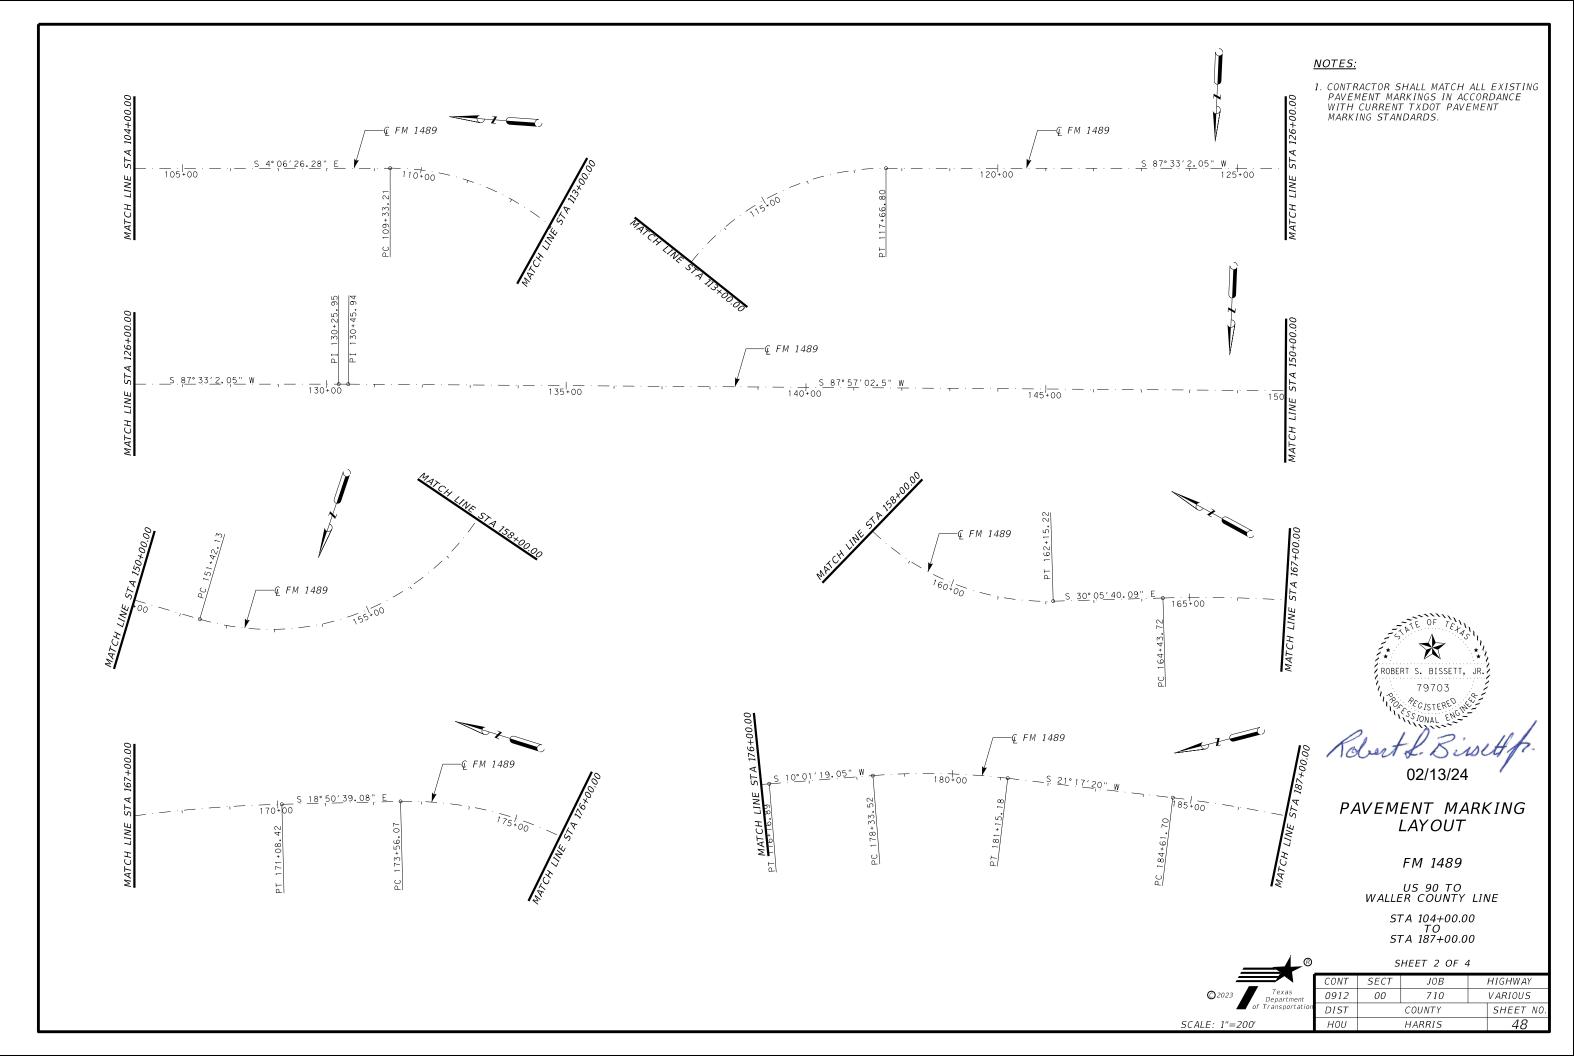

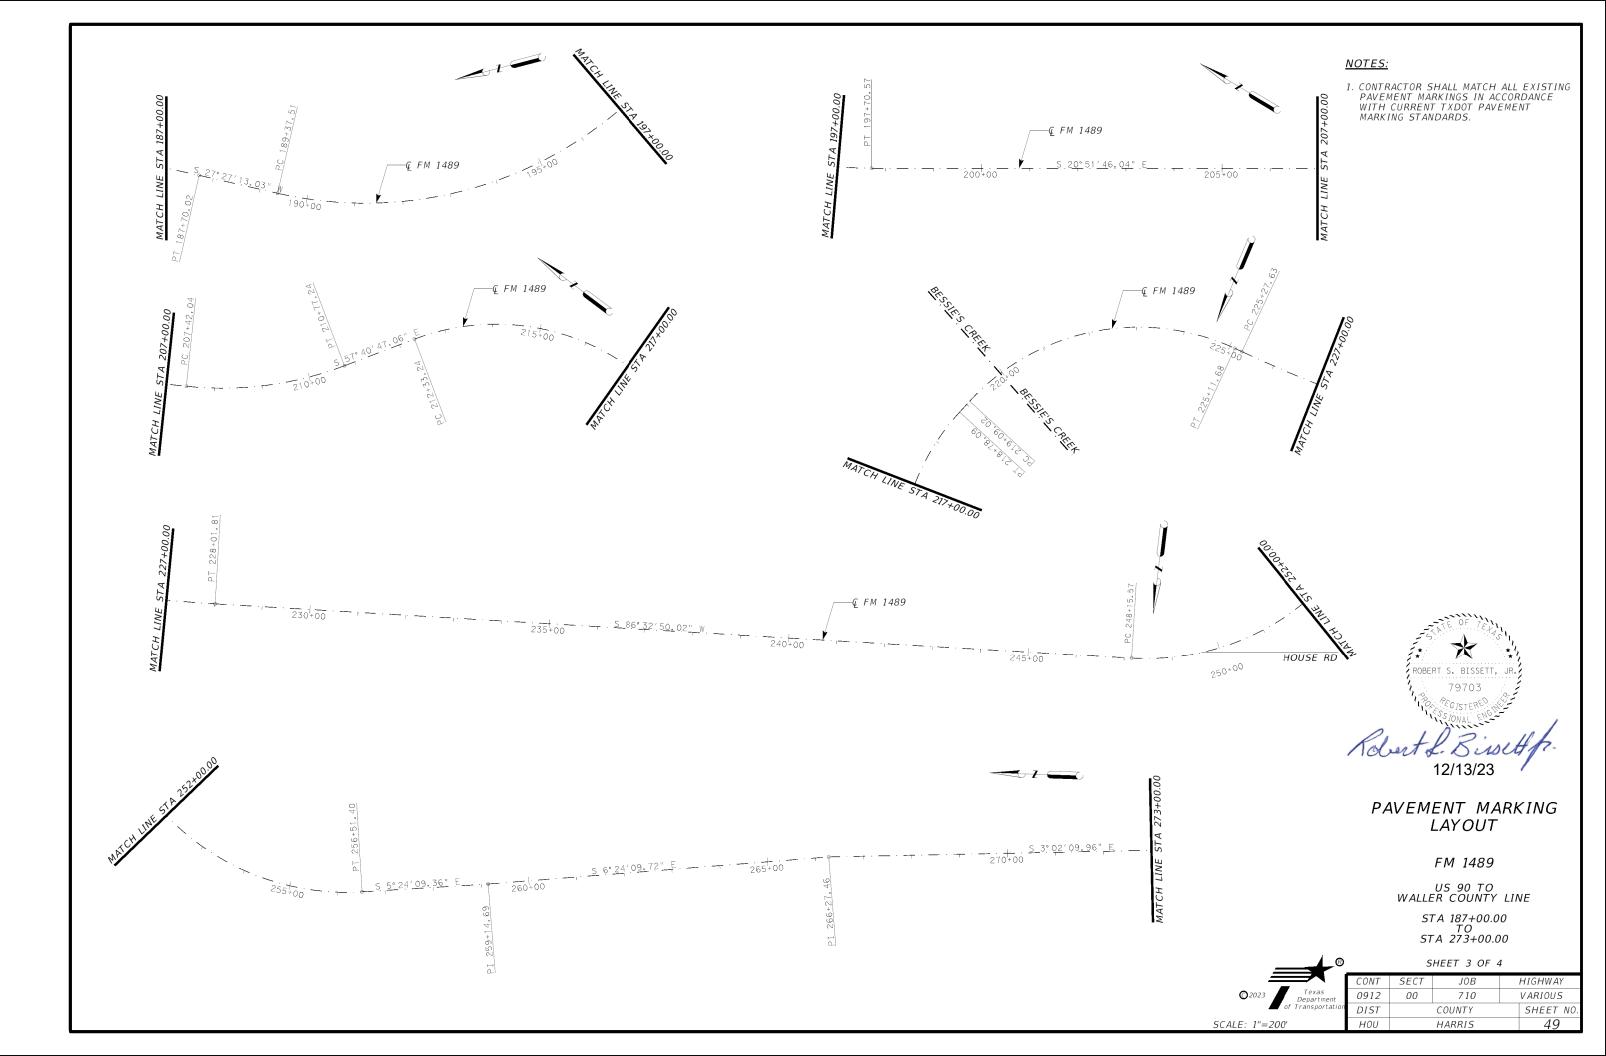

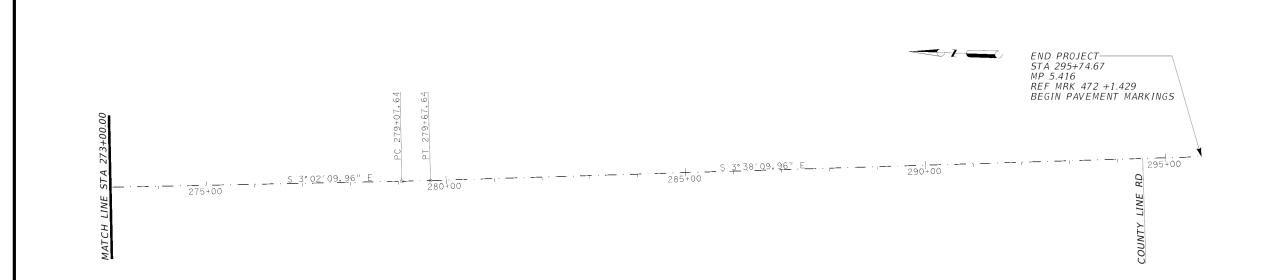

1. CONTRACTOR SHALL MATCH ALL EXISTING PAVEMENT MARKINGS IN ACCORDANCE WITH CURRENT TXDOT PAVEMENT MARKING STANDARDS.

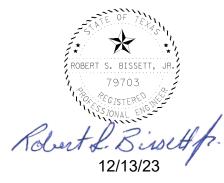



PAVEMENT MARKING LAYOUT


FM 1489


US 90 TO WALLER COUNTY LINE STA 273+00.00 TO STA 295+74.67


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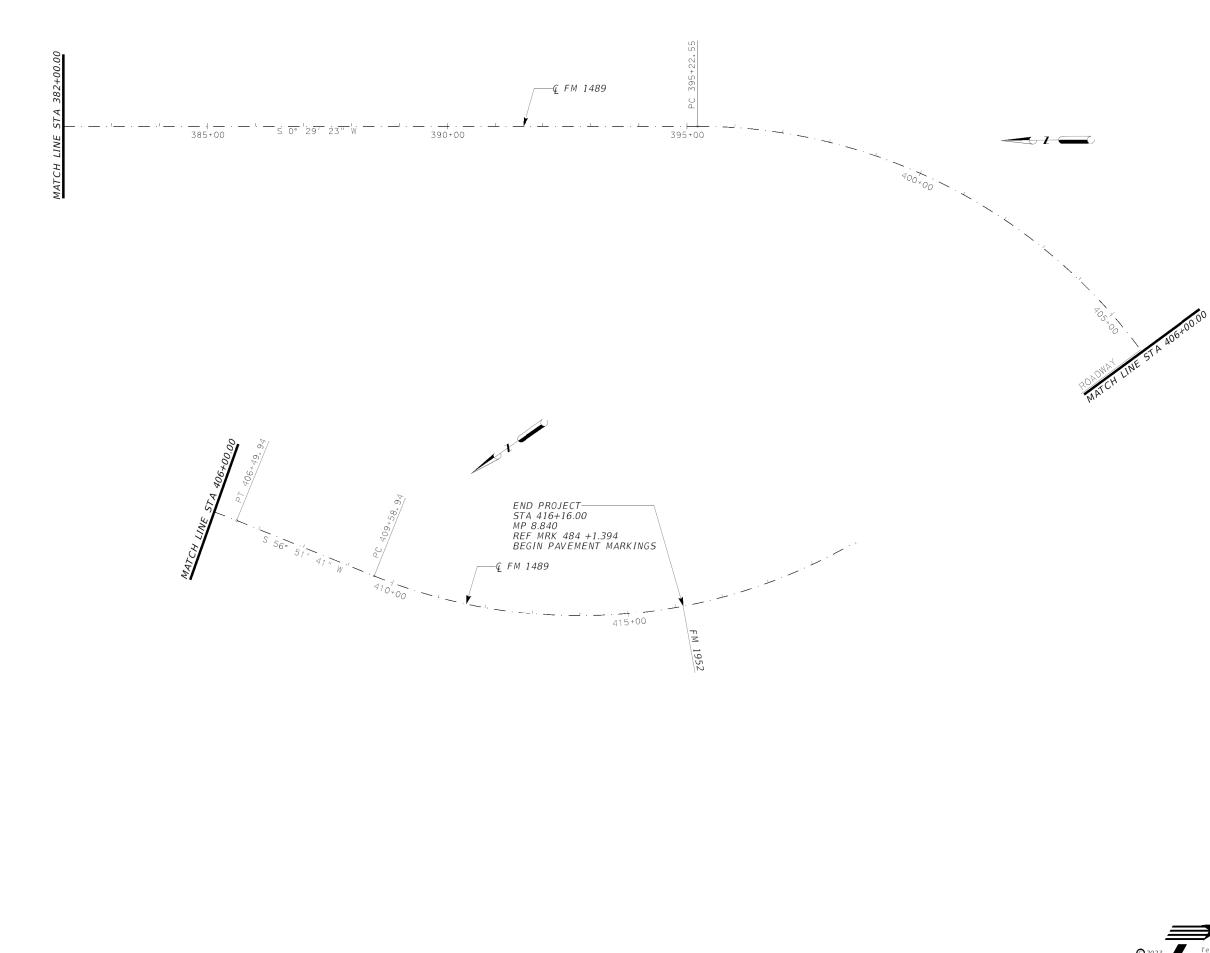


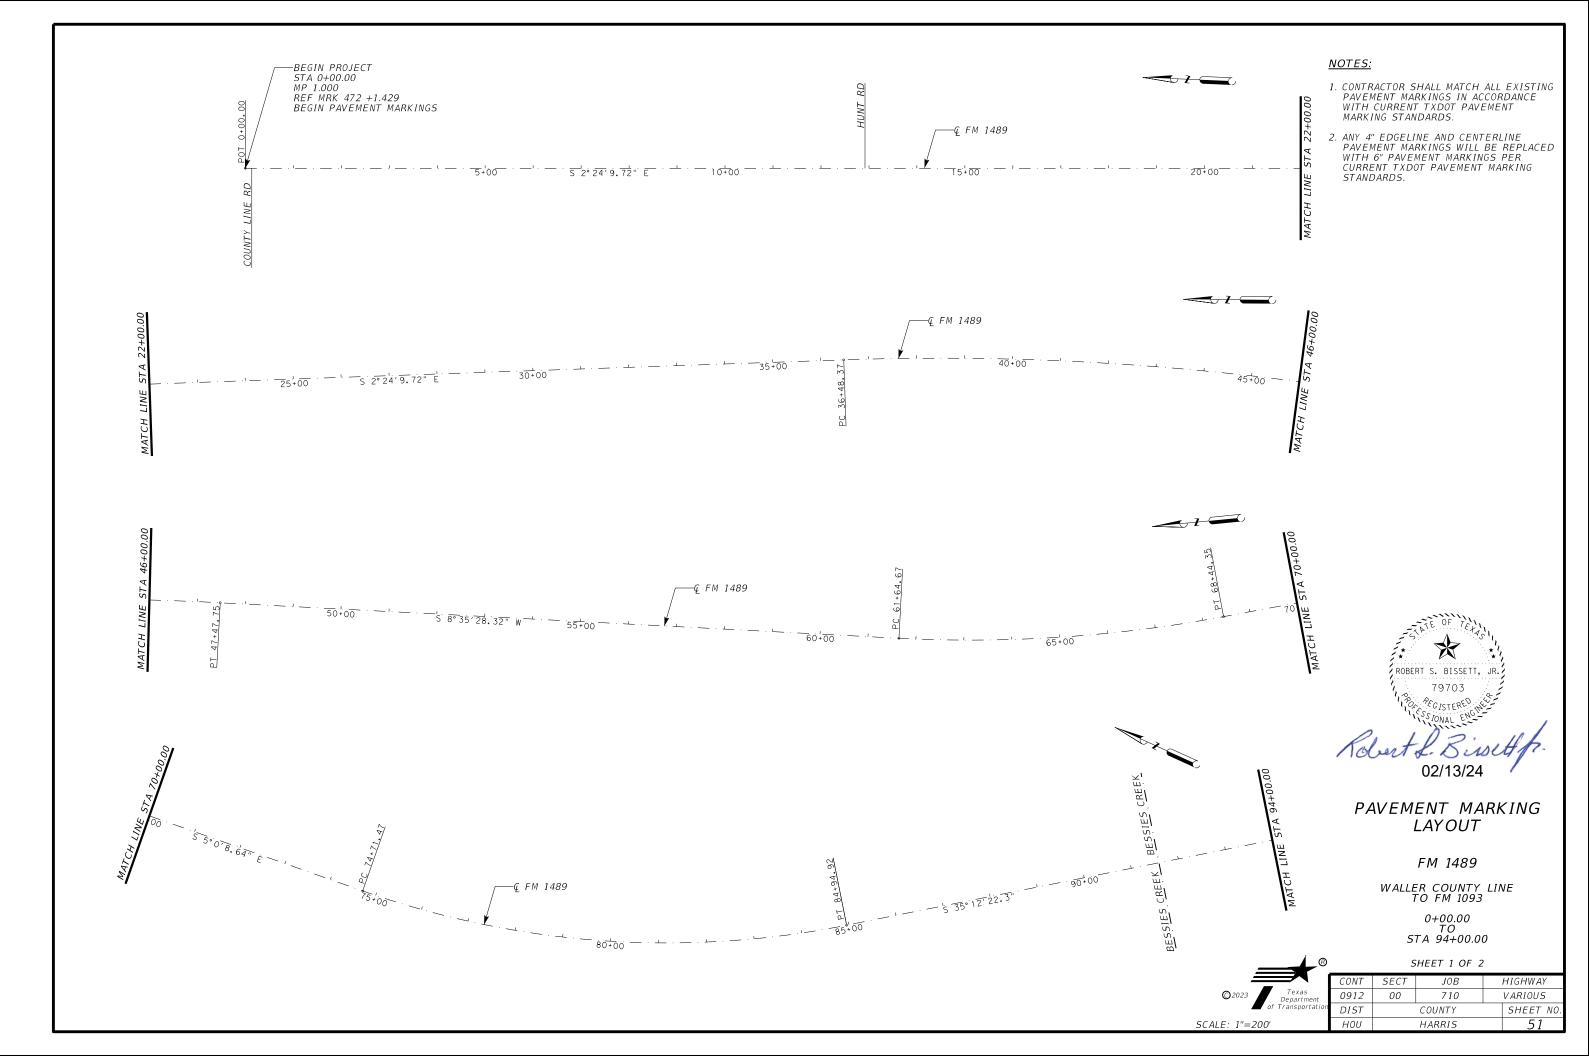

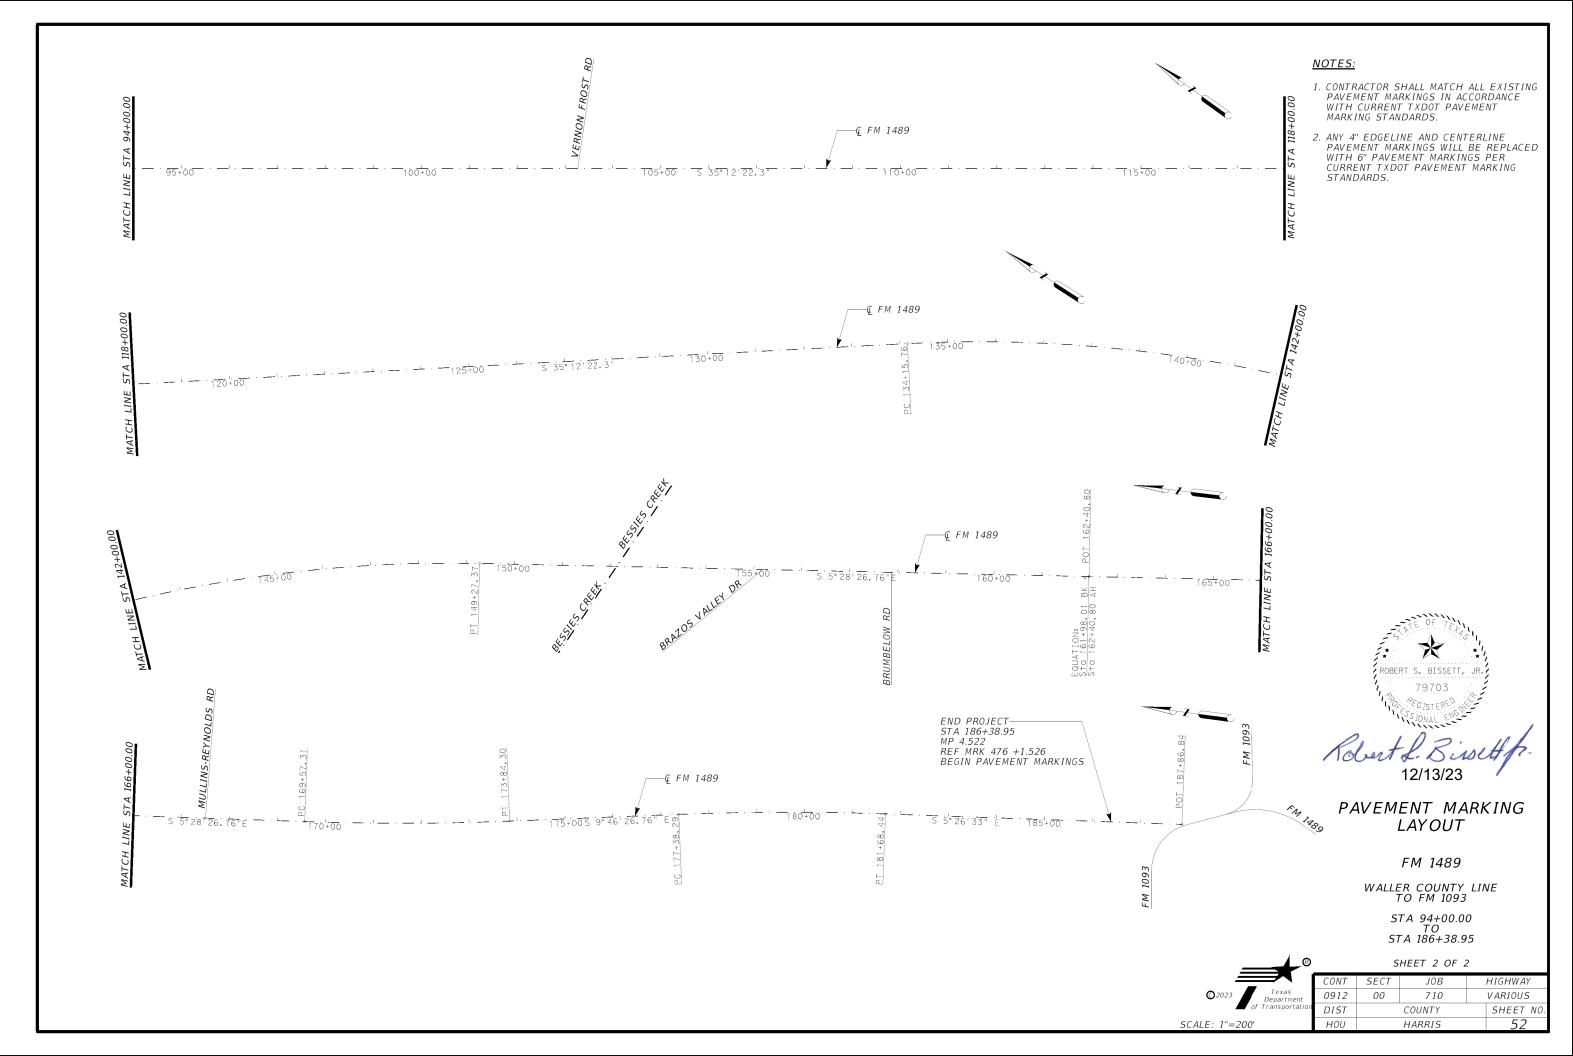

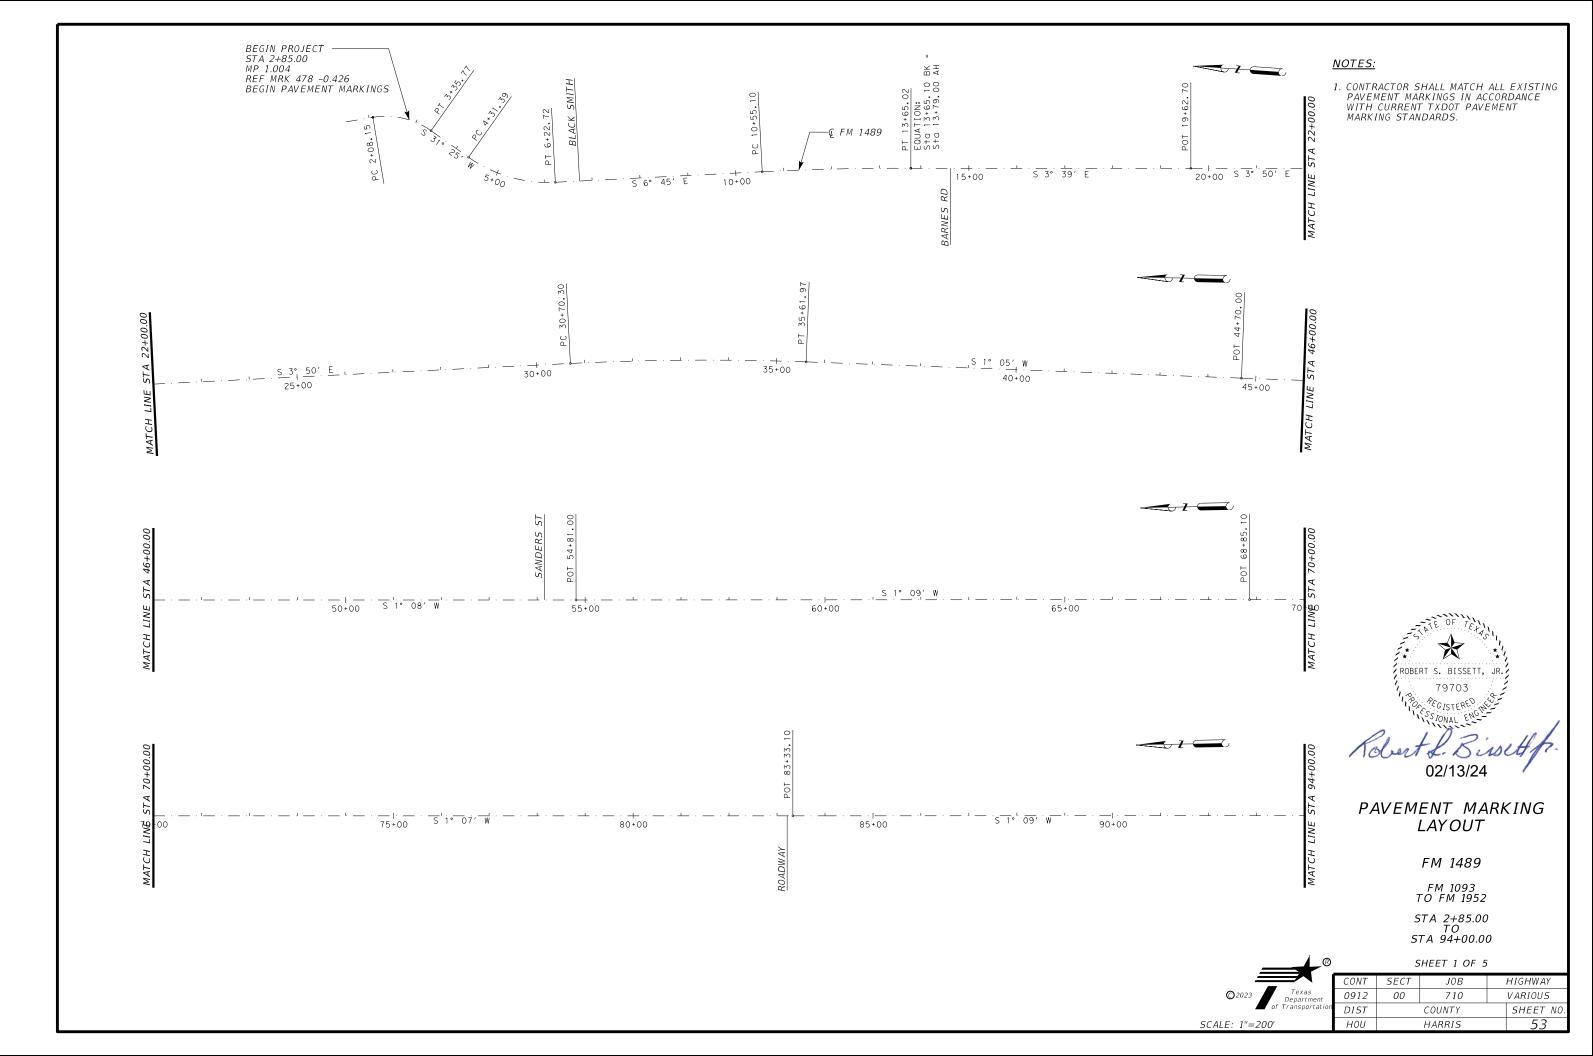

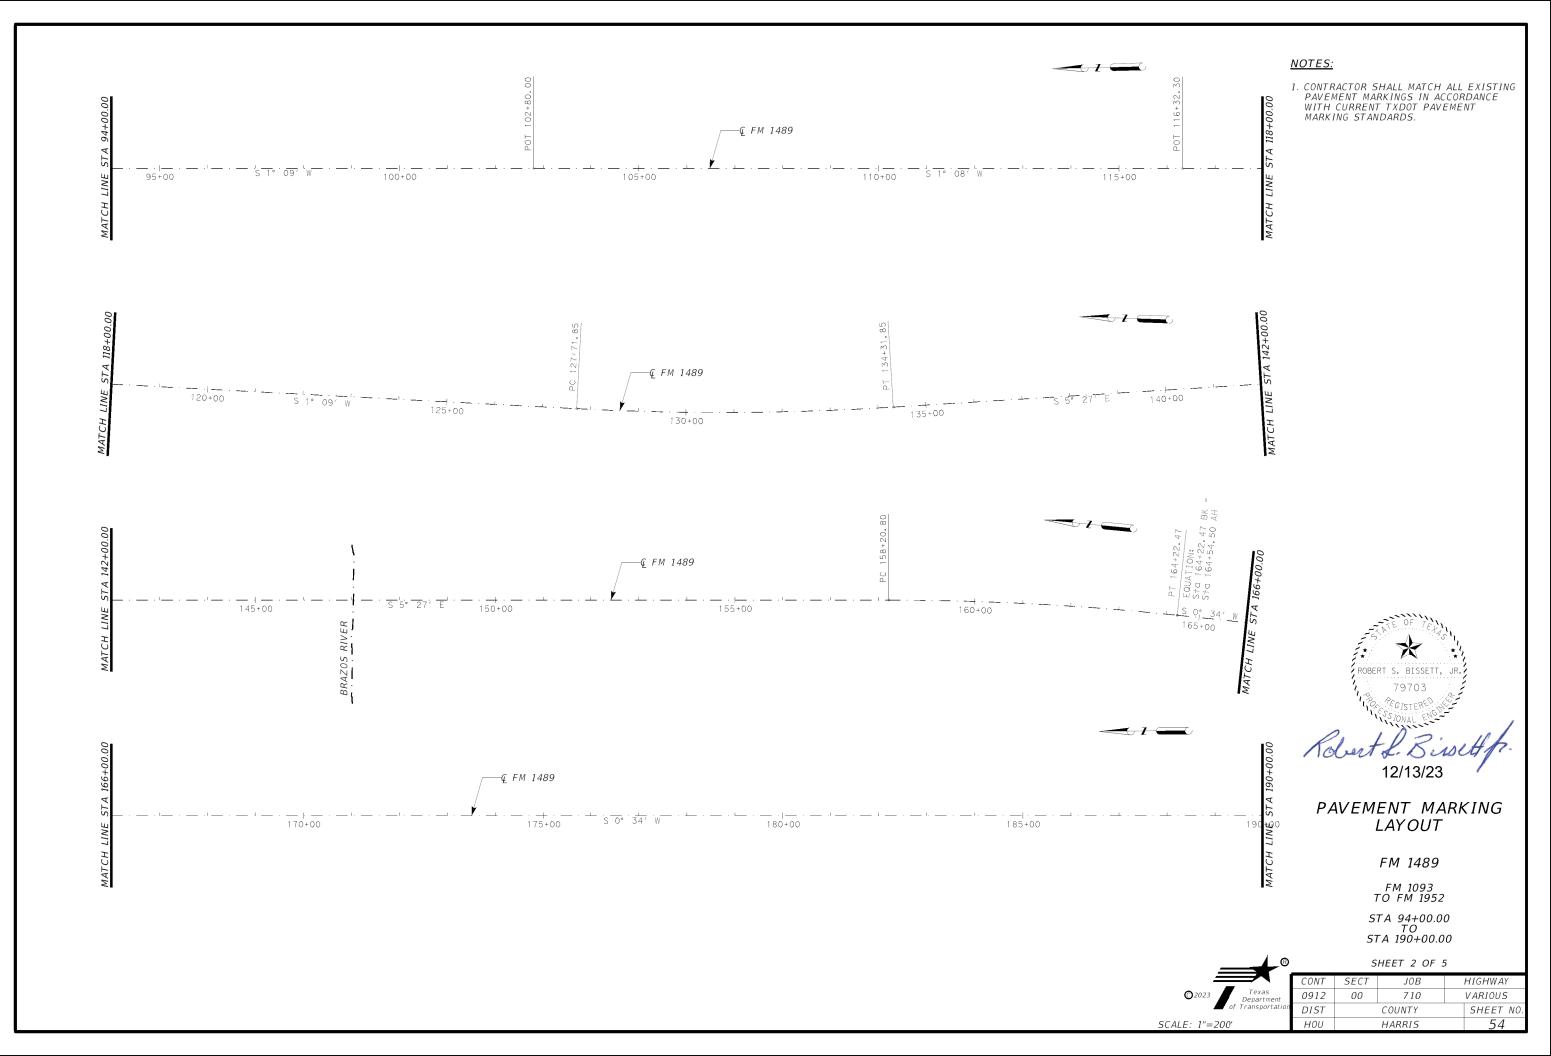

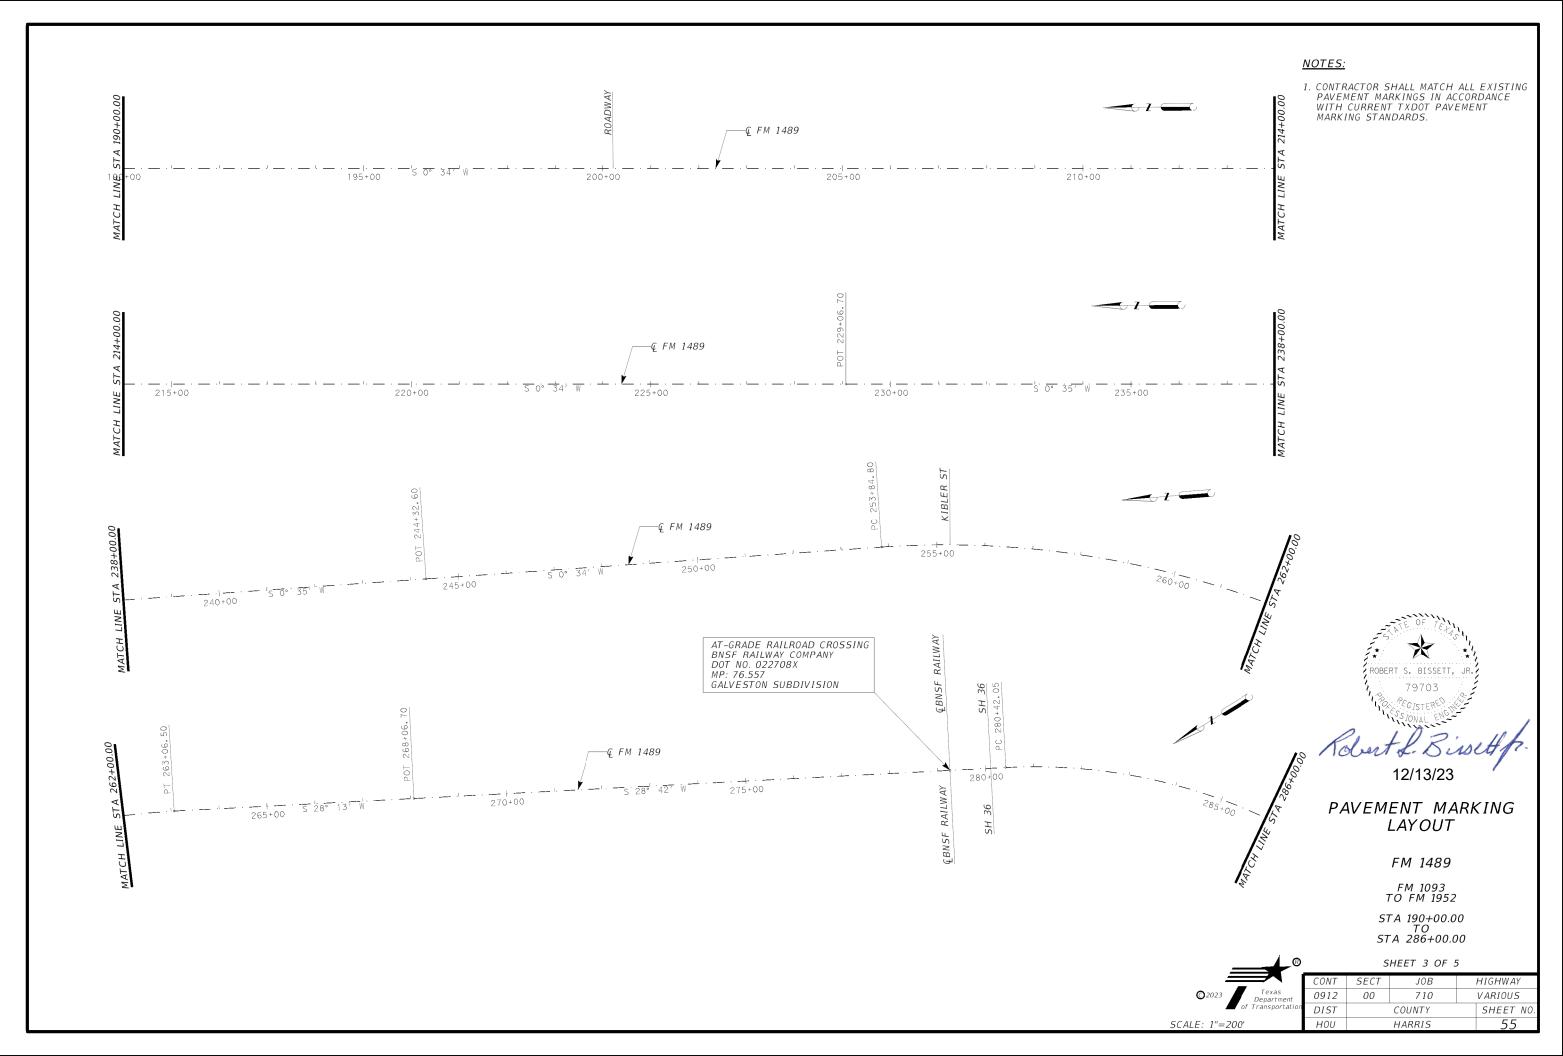

1. CONTRACTOR SHALL MATCH ALL EXISTING PAVEMENT MARKINGS IN ACCORDANCE WITH CURRENT TXDOT PAVEMENT MARKING STANDARDS.





PAVEMENT MARKING LAYOUT


FM 1489

FM 1093 TO FM 1952 STA 382+00.00 TO STA 416+16.00


ß		5	HEET 5 OF 5	5
	CONT	SECT	JOB	HIGHWAY
© 2023 Texas Department	0912	00	710	VARIOUS
of Transportation	DIST		COUNTY	SHEET NO.
SCALE: 1"=200'	HOU		HARRIS	57

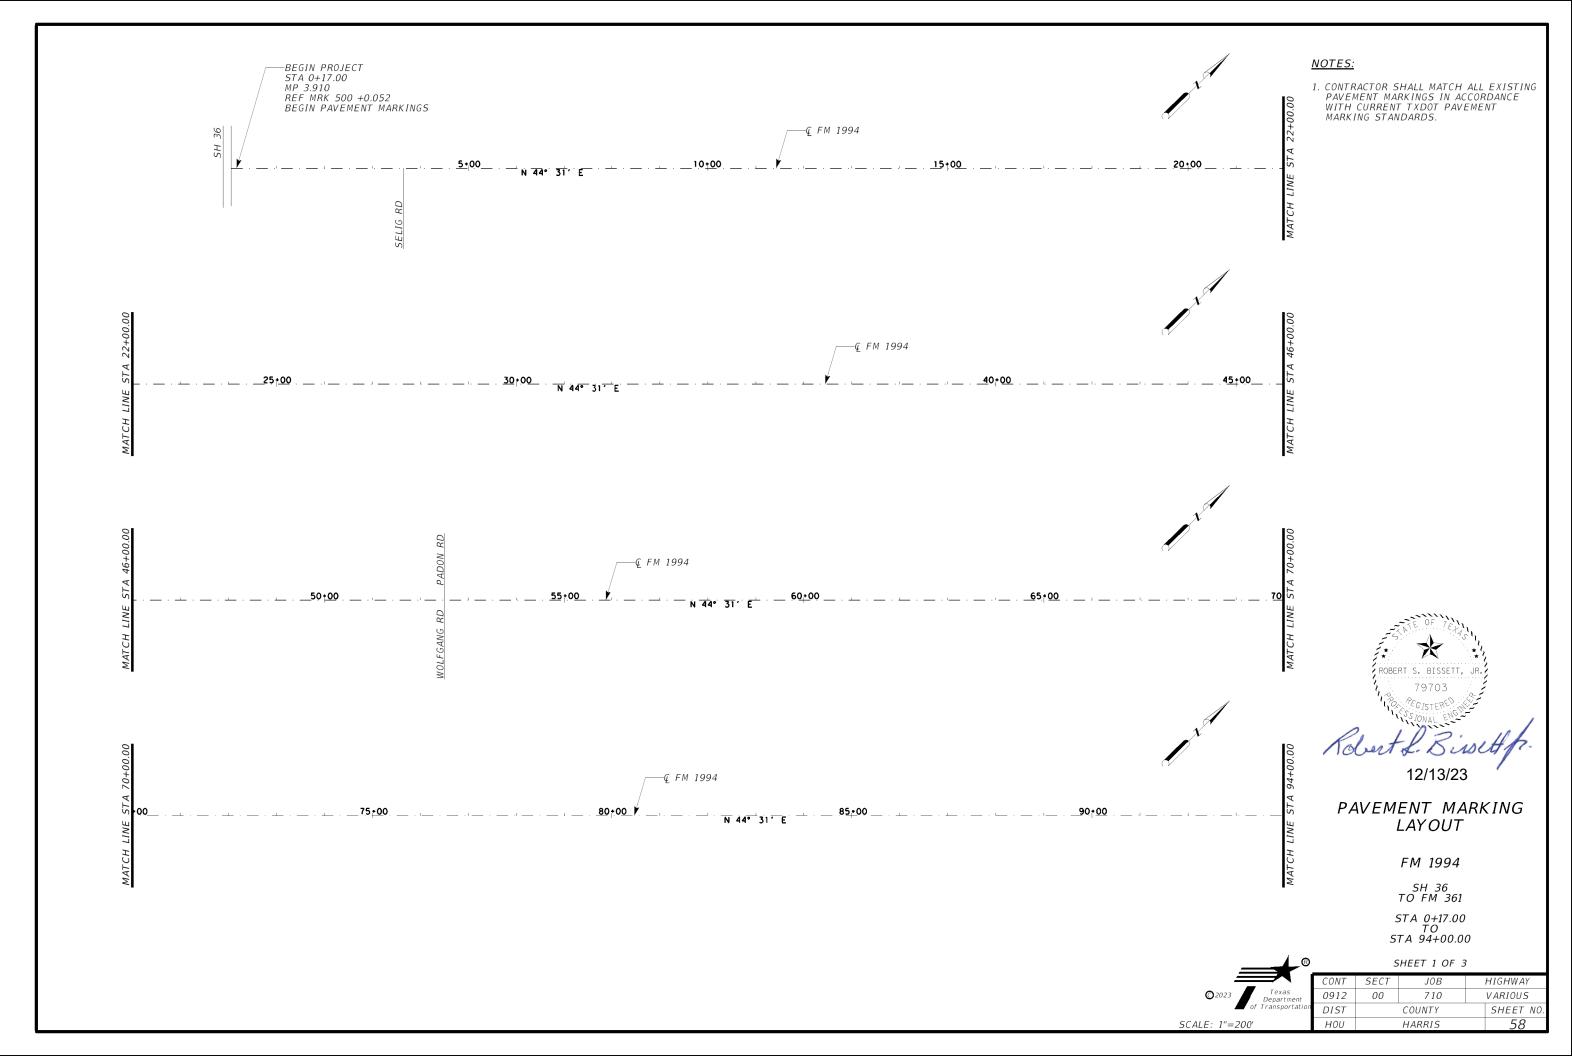

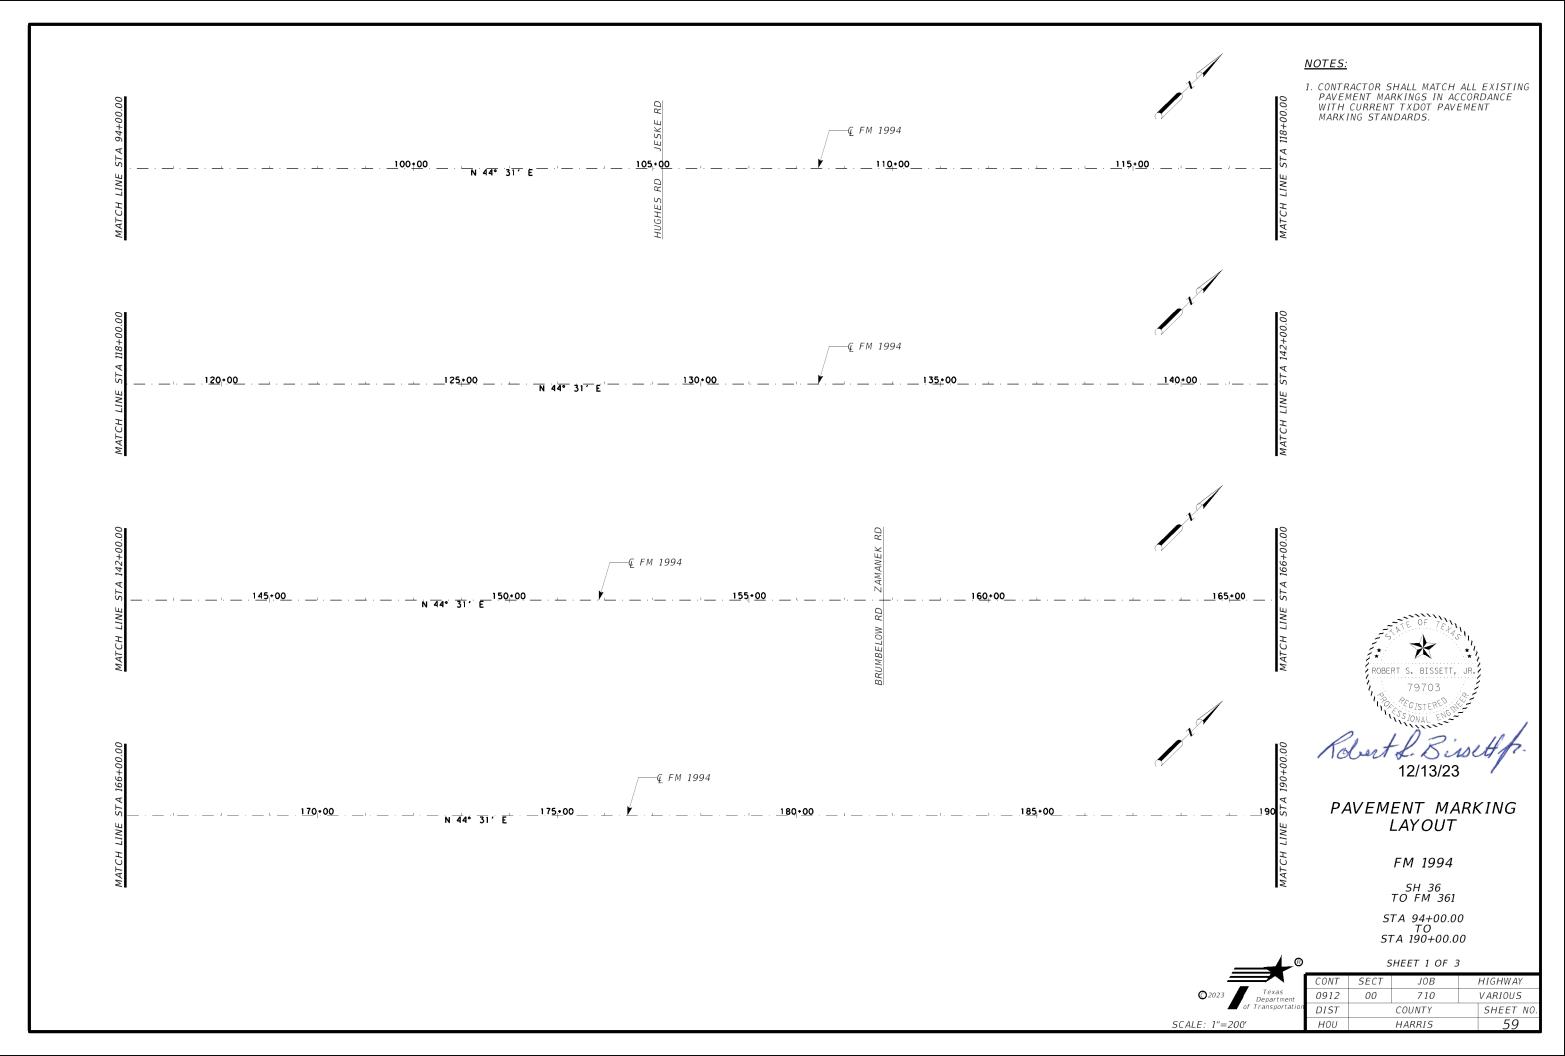

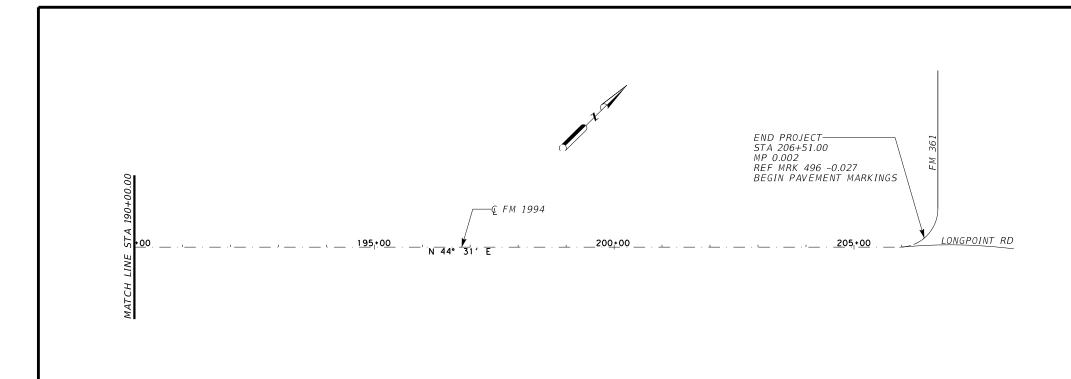

1. CONTRACTOR SHALL MATCH ALL EXISTING PAVEMENT MARKINGS IN ACCORDANCE WITH CURRENT TXDOT PAVEMENT MARKING STANDARDS.

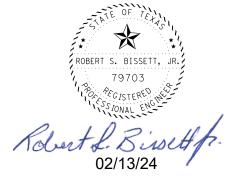



# PAVEMENT MARKING LAYOUT


### FM 1994

SH 36 TO FM 361 STA 190+00.00 TO STA 206+51.00


®		S	HEET 3 OF 3	3	
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©2023 Texas Department of Transportation	0912	00	710		VARIOUS
of Transportation	DIST	COUNTY			SHEET NO.
SCALE: 1"=200'	HOU		HARRIS		60

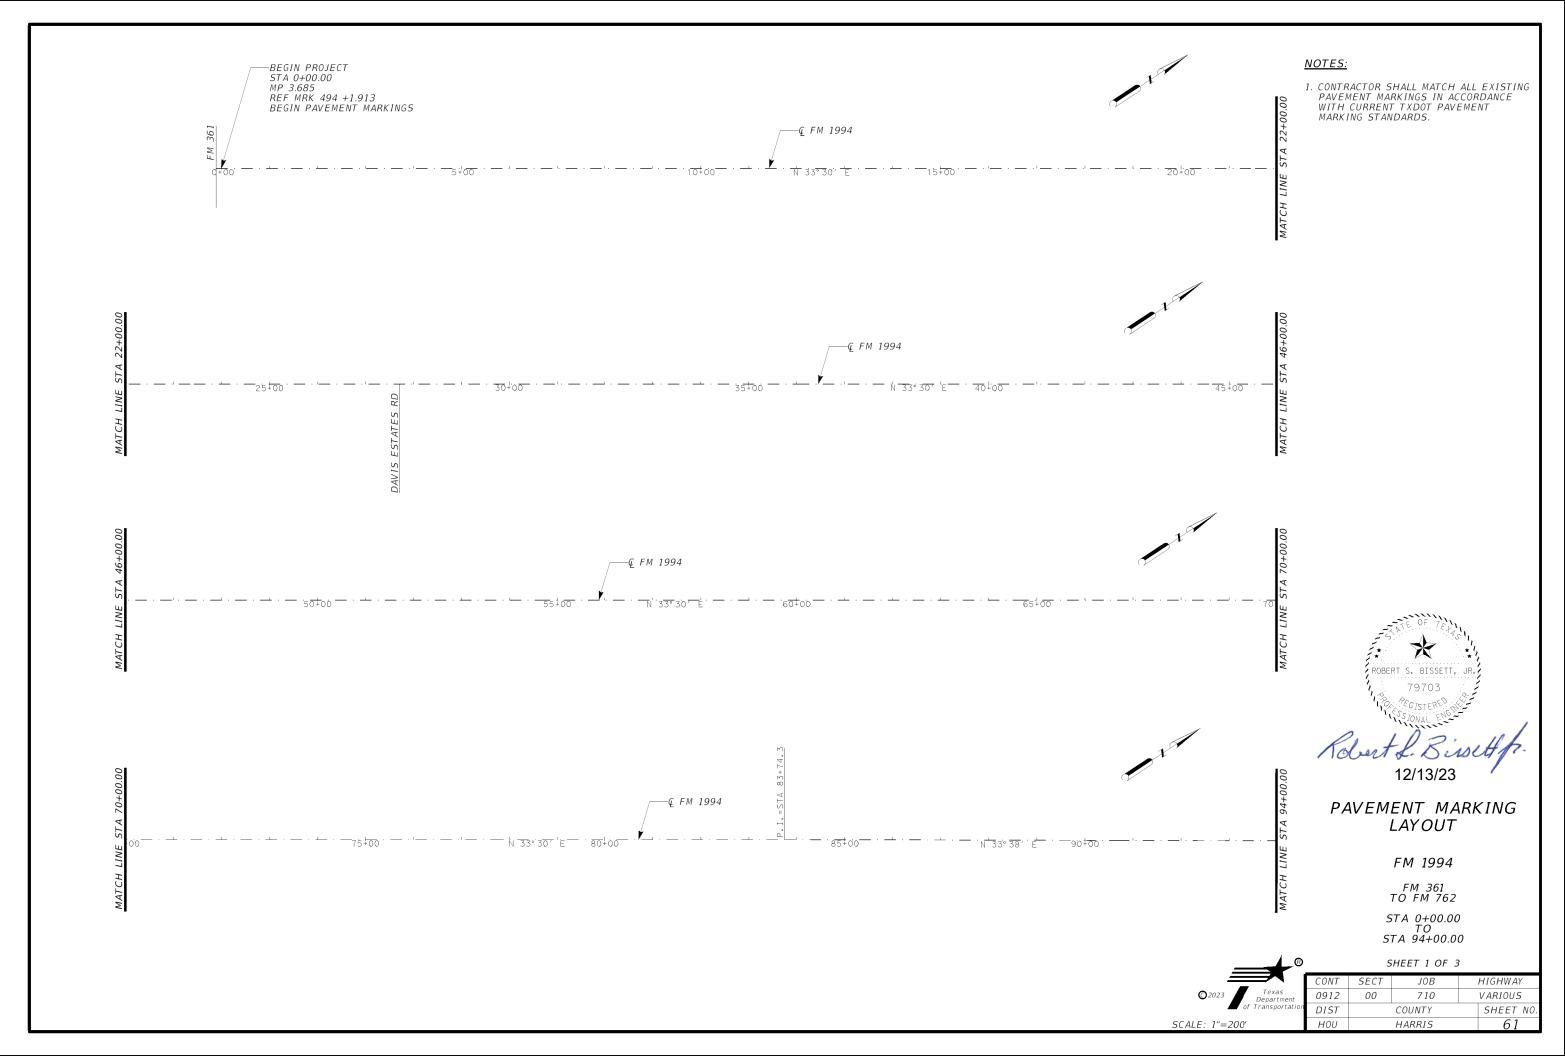

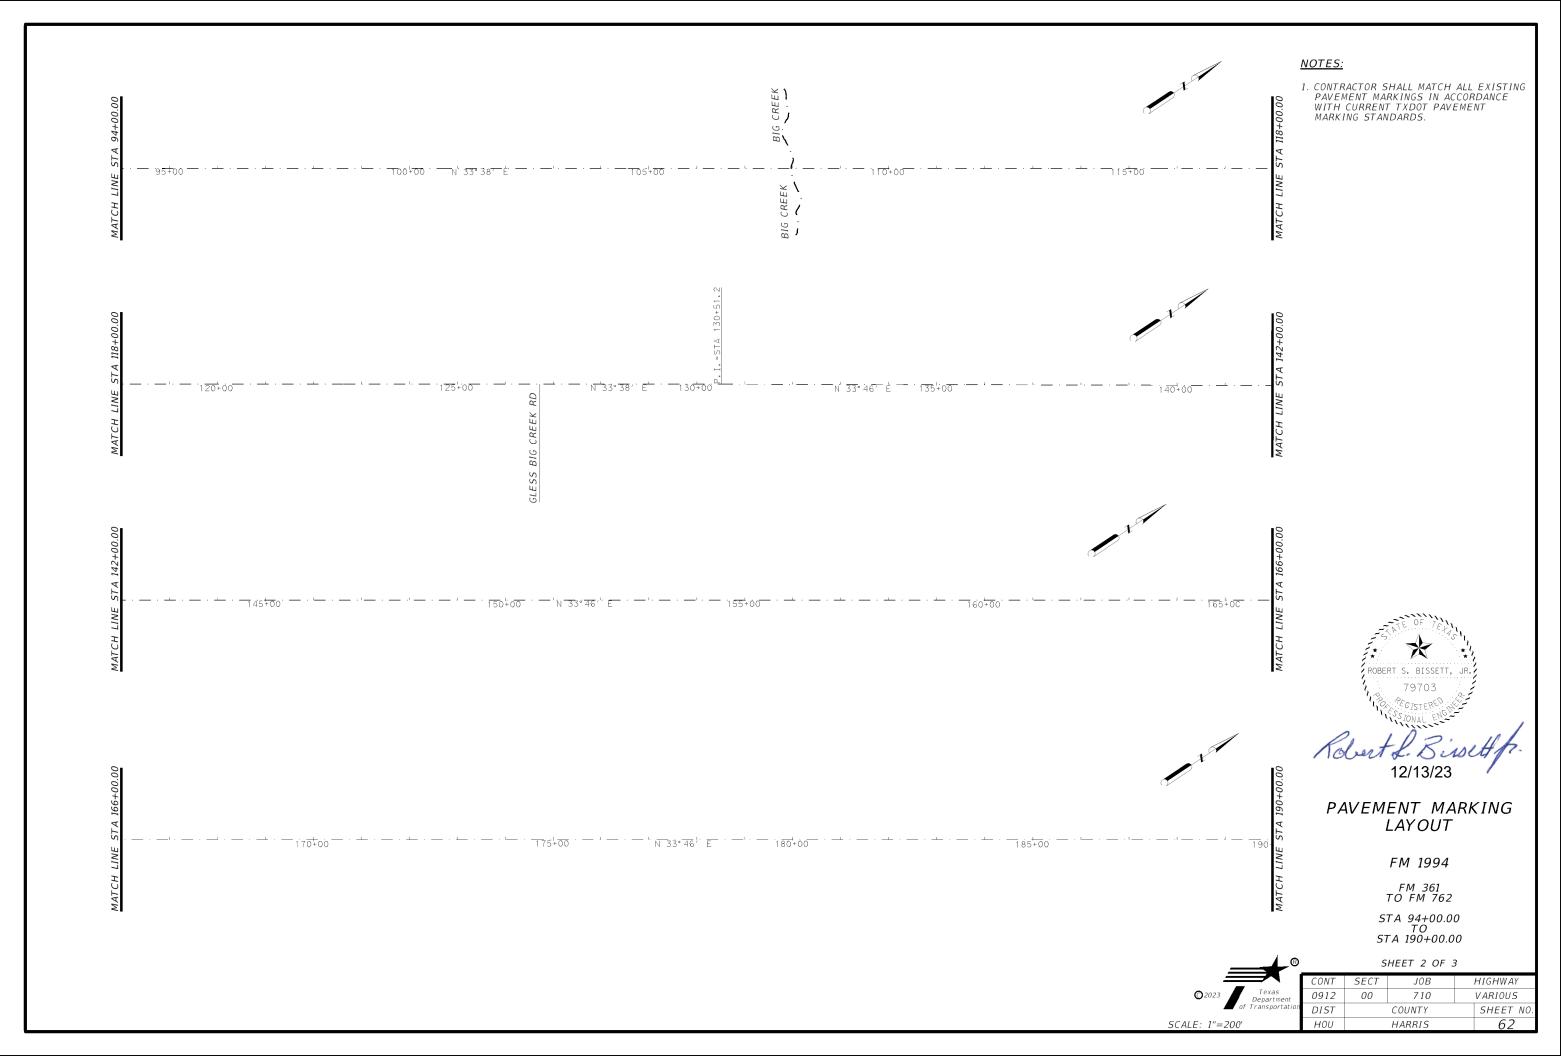

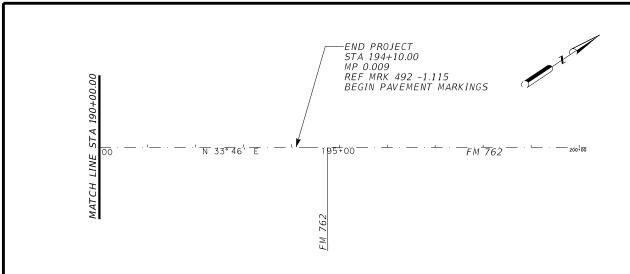

1. CONTRACTOR SHALL MATCH ALL EXISTING PAVEMENT MARKINGS IN ACCORDANCE WITH CURRENT TXDOT PAVEMENT MARKING STANDARDS.

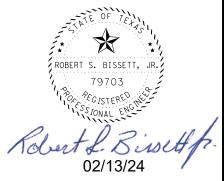



# PAVEMENT MARKING LAYOUT


#### FM 1994


FM 361 TO FM 762 STA 190+00.00 TO STA 194+10.00


		S	HEET 3 OF 3	3	
	CONT	SECT	JOB		HIGHWAY
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of Transportation	DIST		COUNTY		SHEET NO.
SCALE: 1"=200'	HOU		HARRIS		63

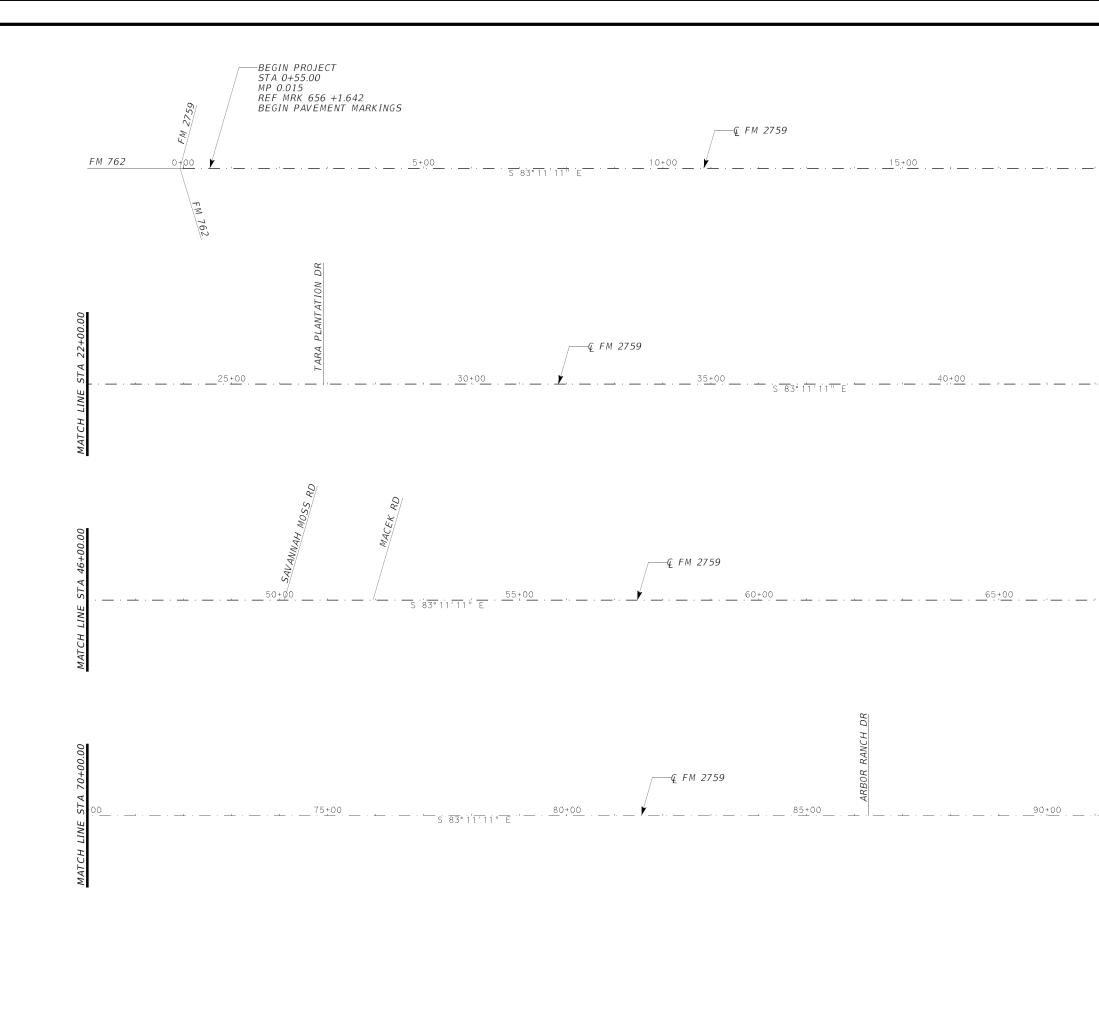


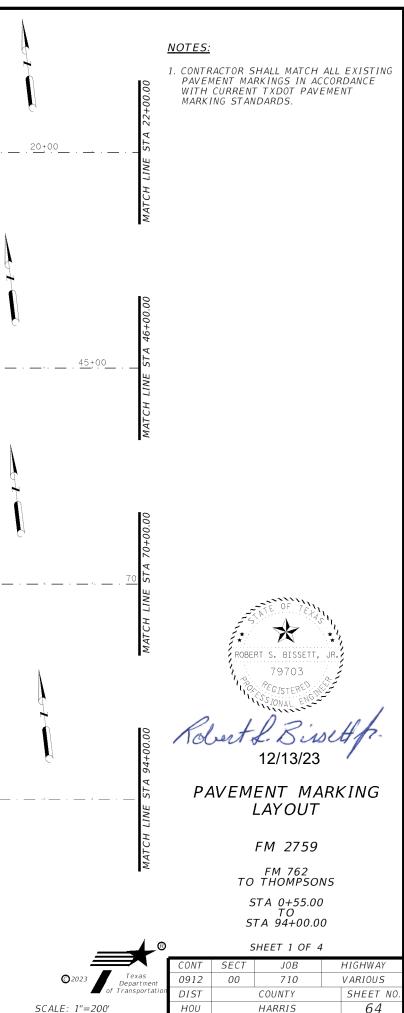


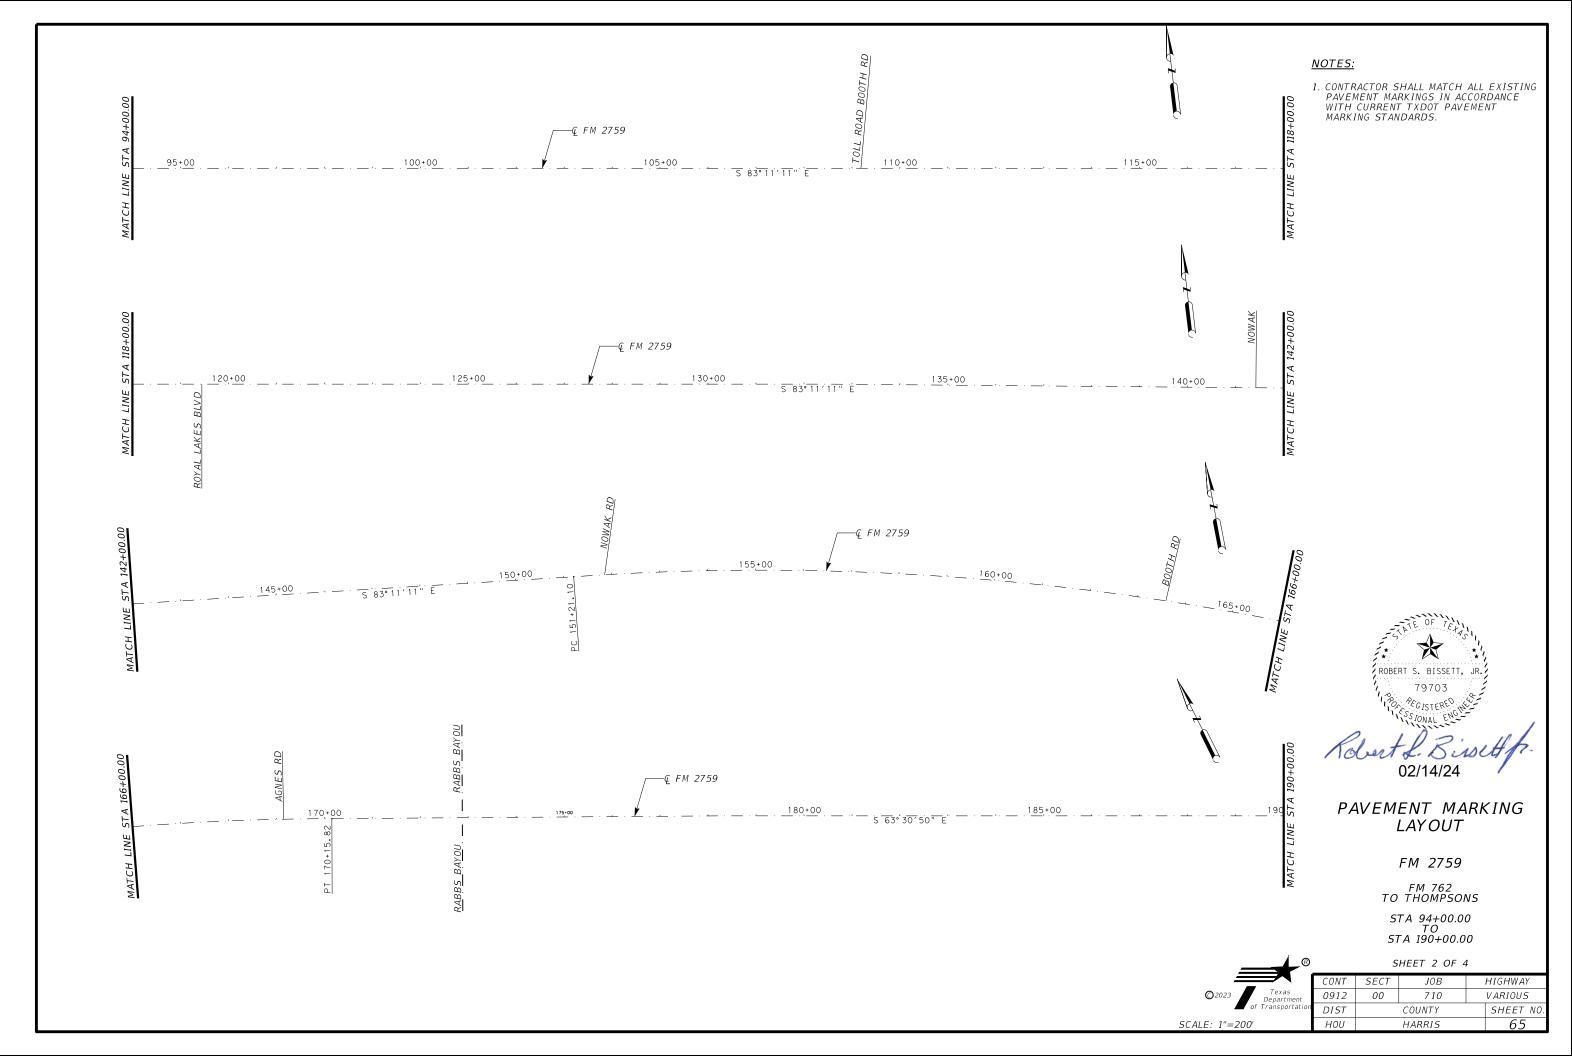

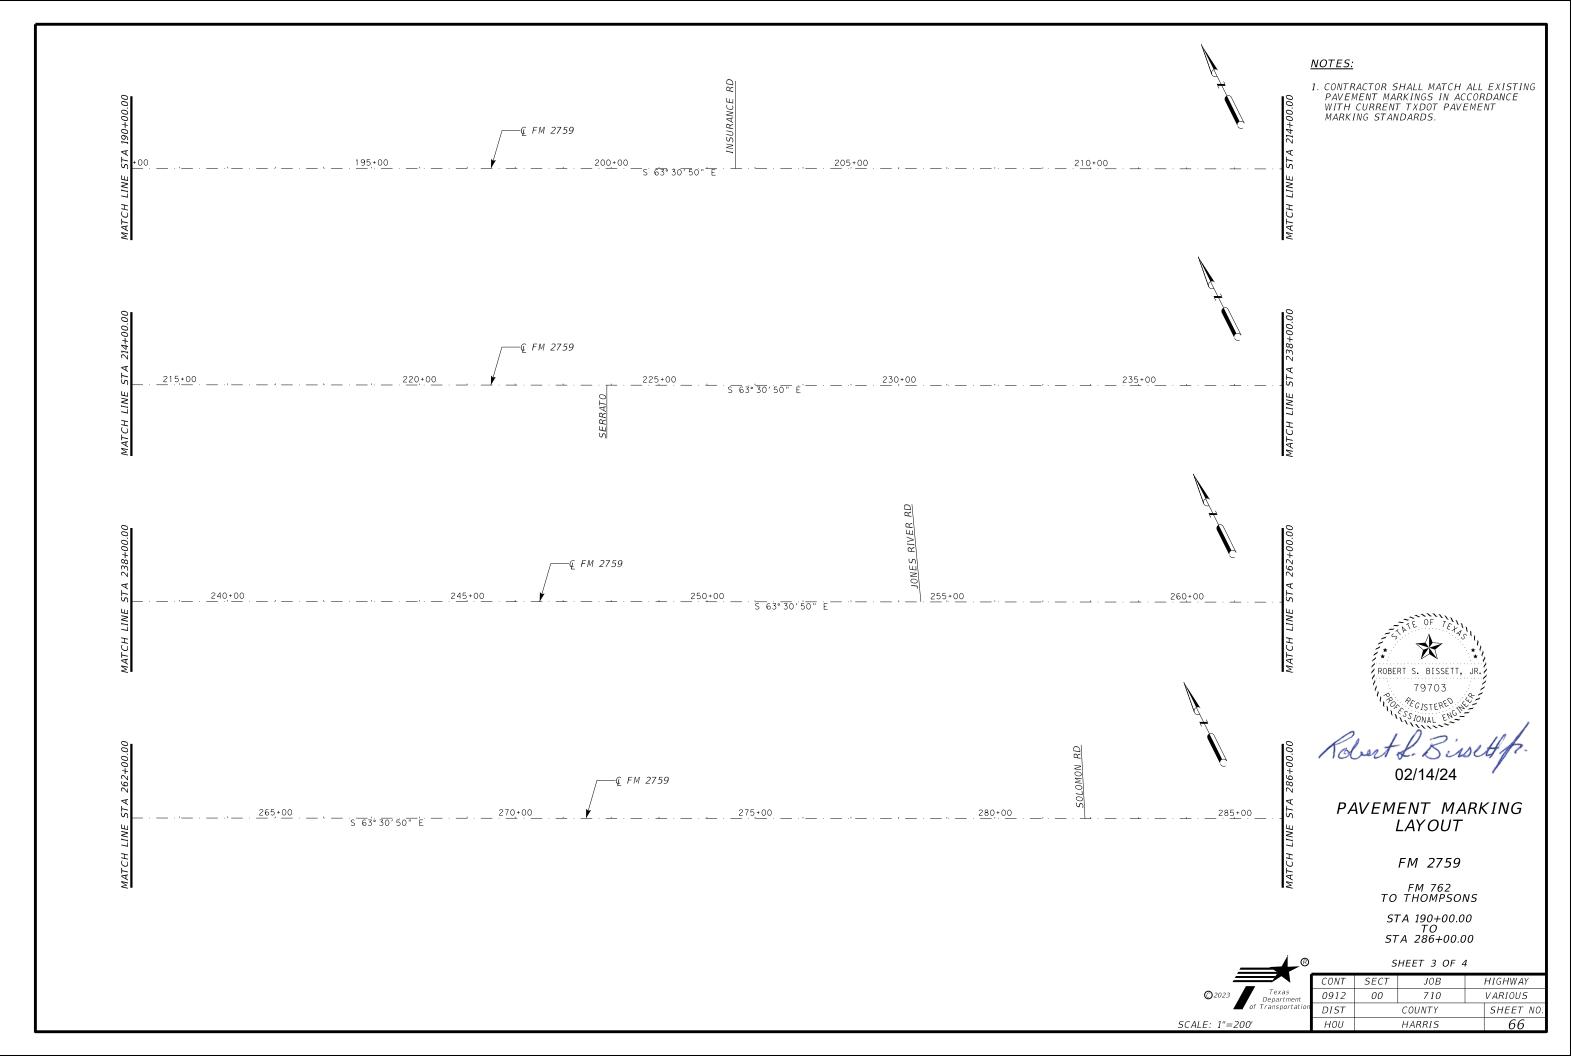

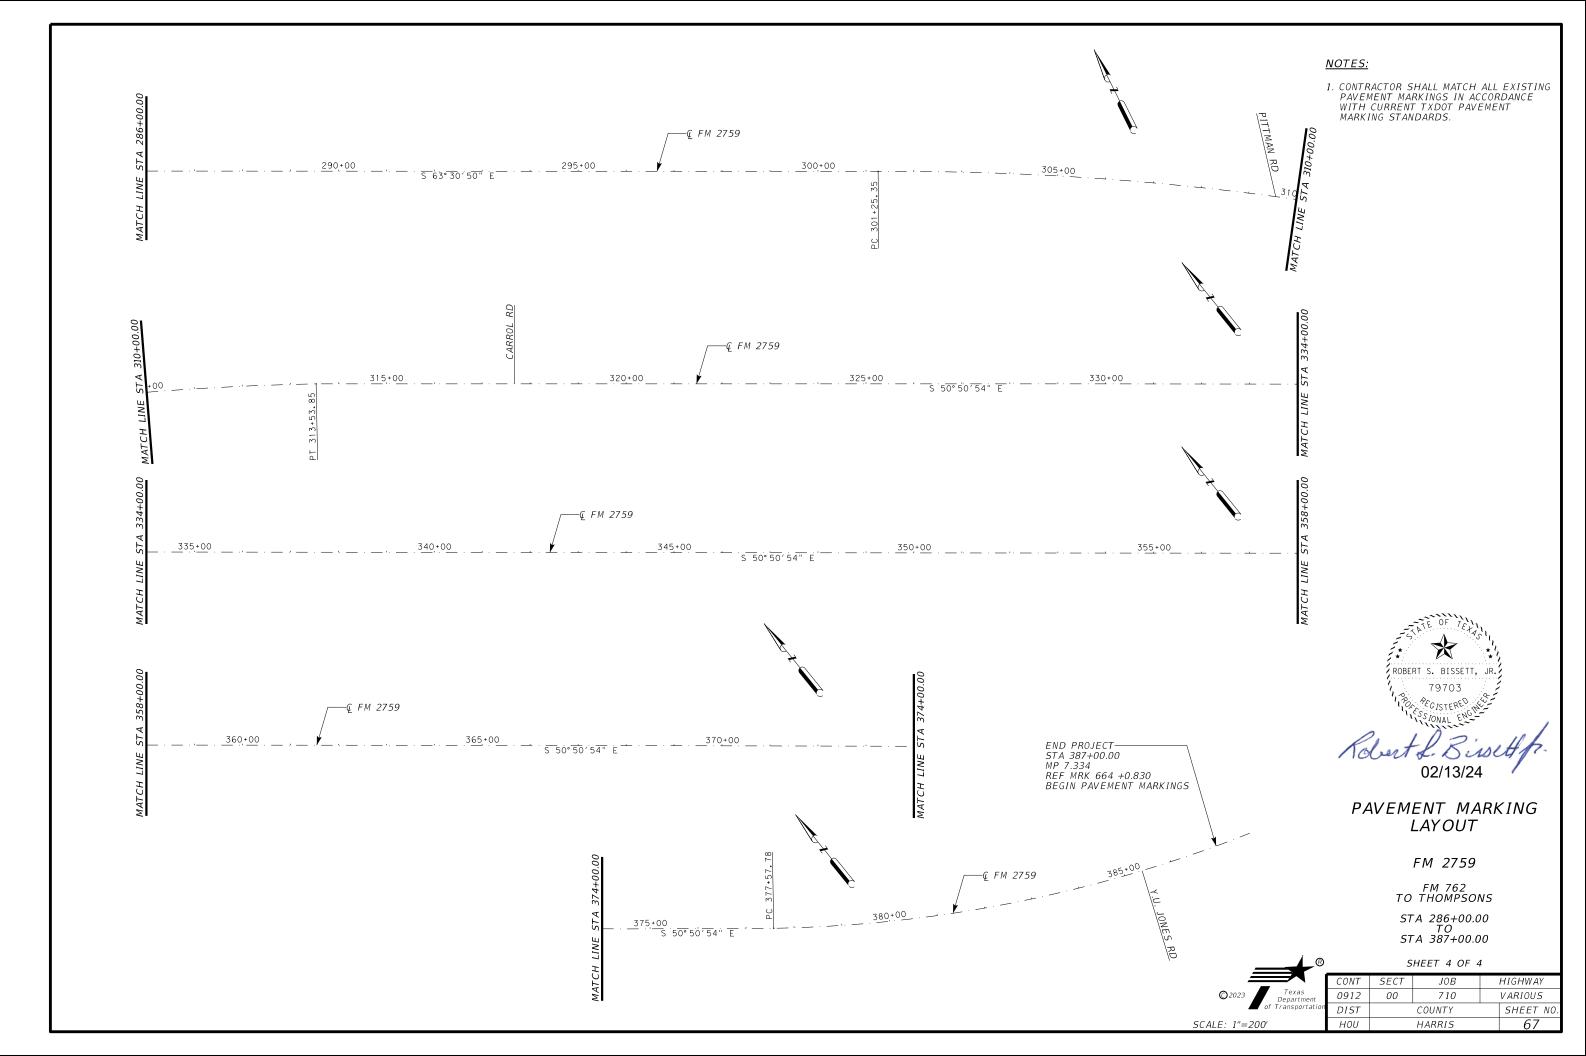

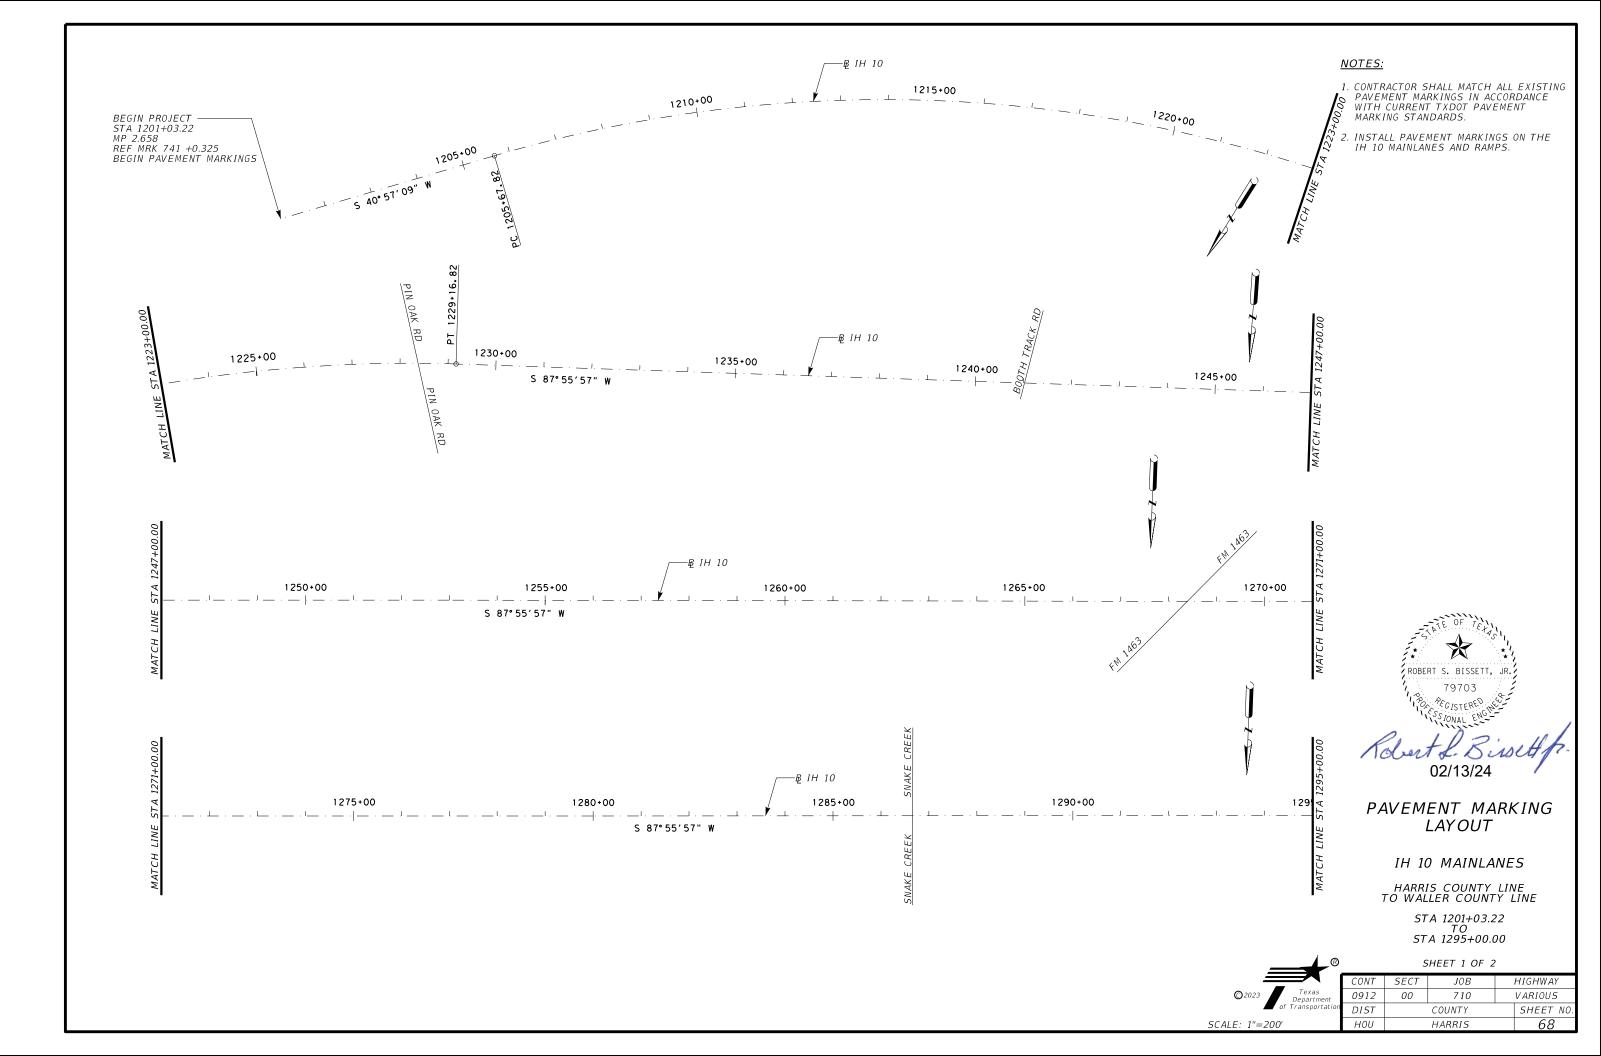

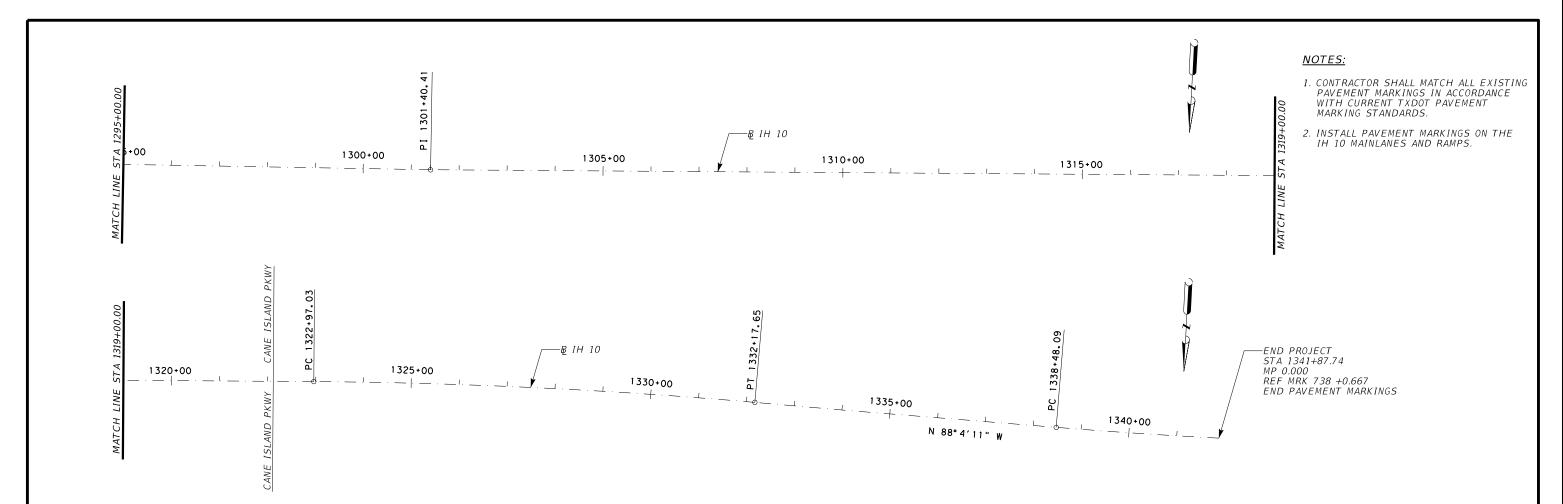





## PAVEMENT MARKING LAYOUT


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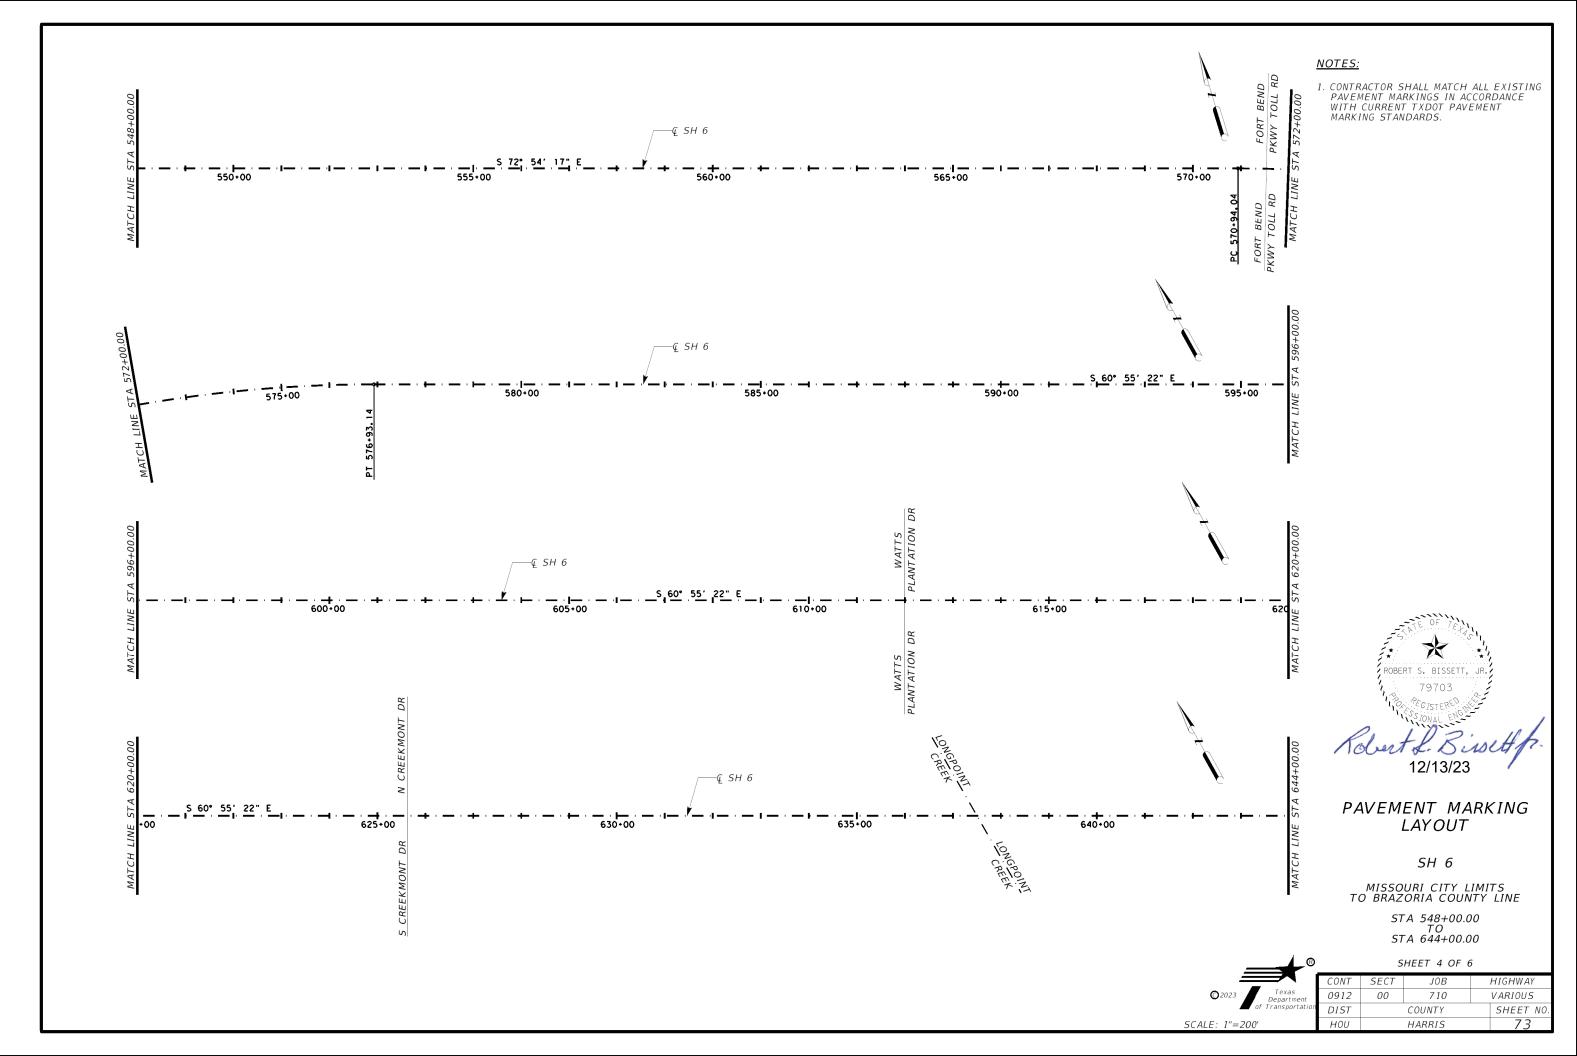
SH 6 TO HARRIS COUNTY LINE STA 1295+00.00 TO STA 1341+87.74


		SHEET 2 OF 2				
	CONT	SECT	JOB	HIGHWAY		
© 2023 Texas Department of Transportation	0912	00	710	VARIOUS		
of Transportation	DIST		COUNTY	SHEET I	NO.	
SCALE: 1"=200'	HOU		HARRIS	69		




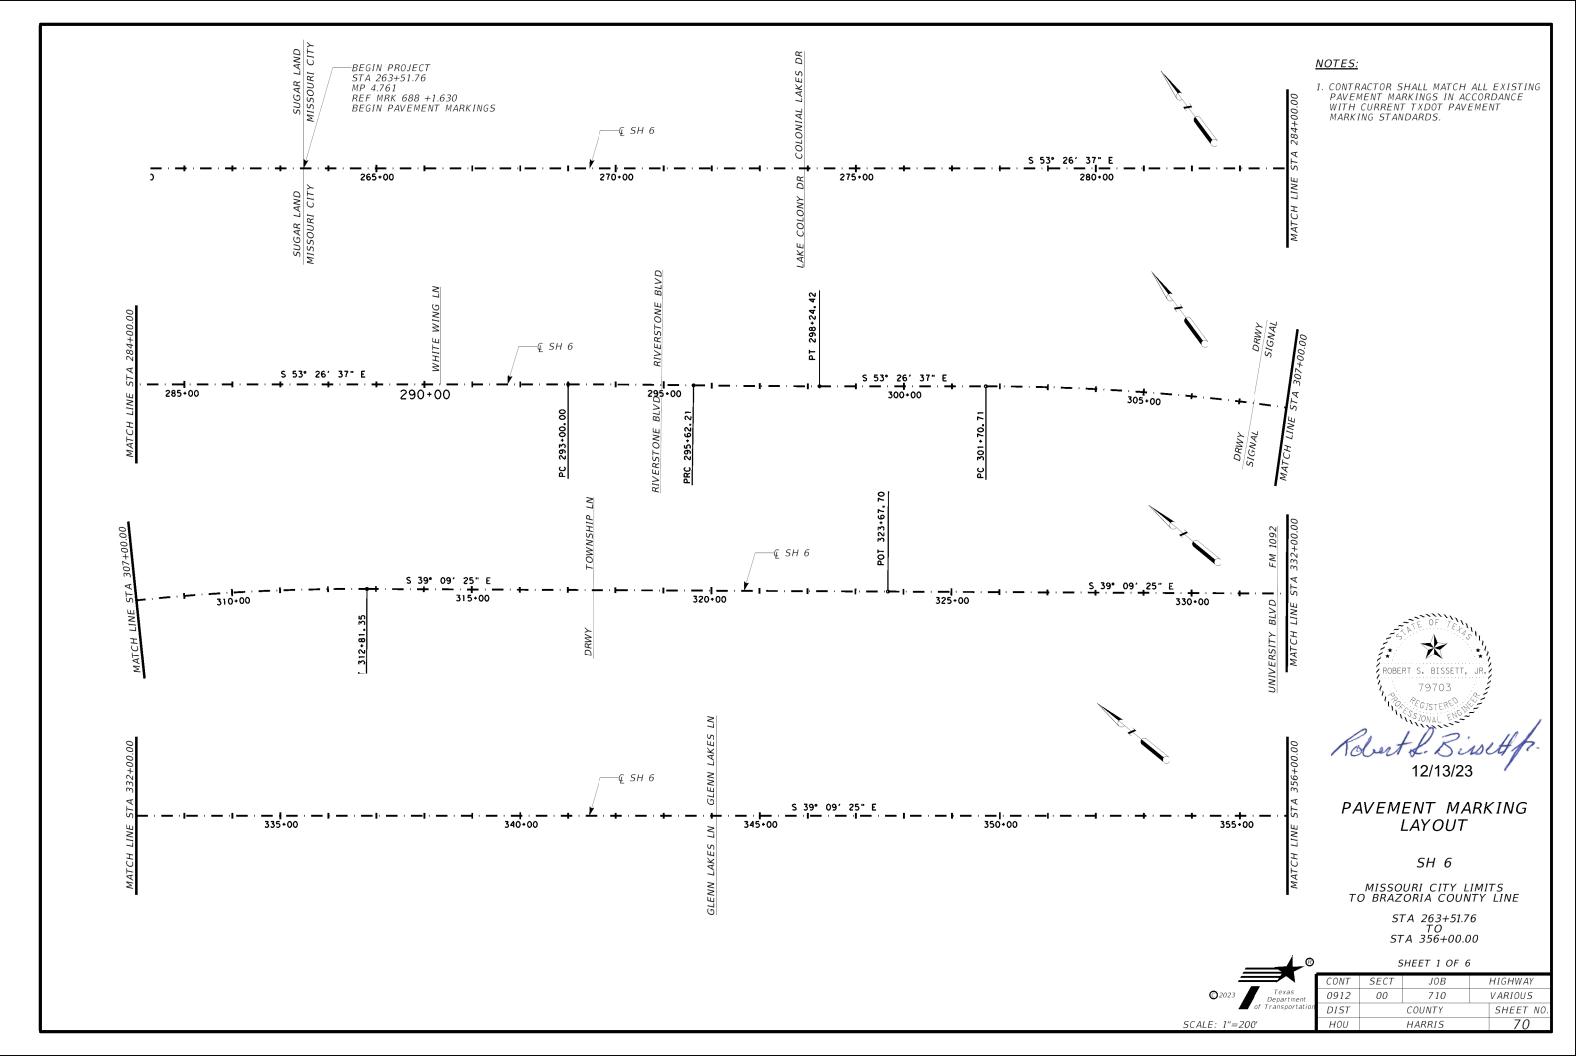


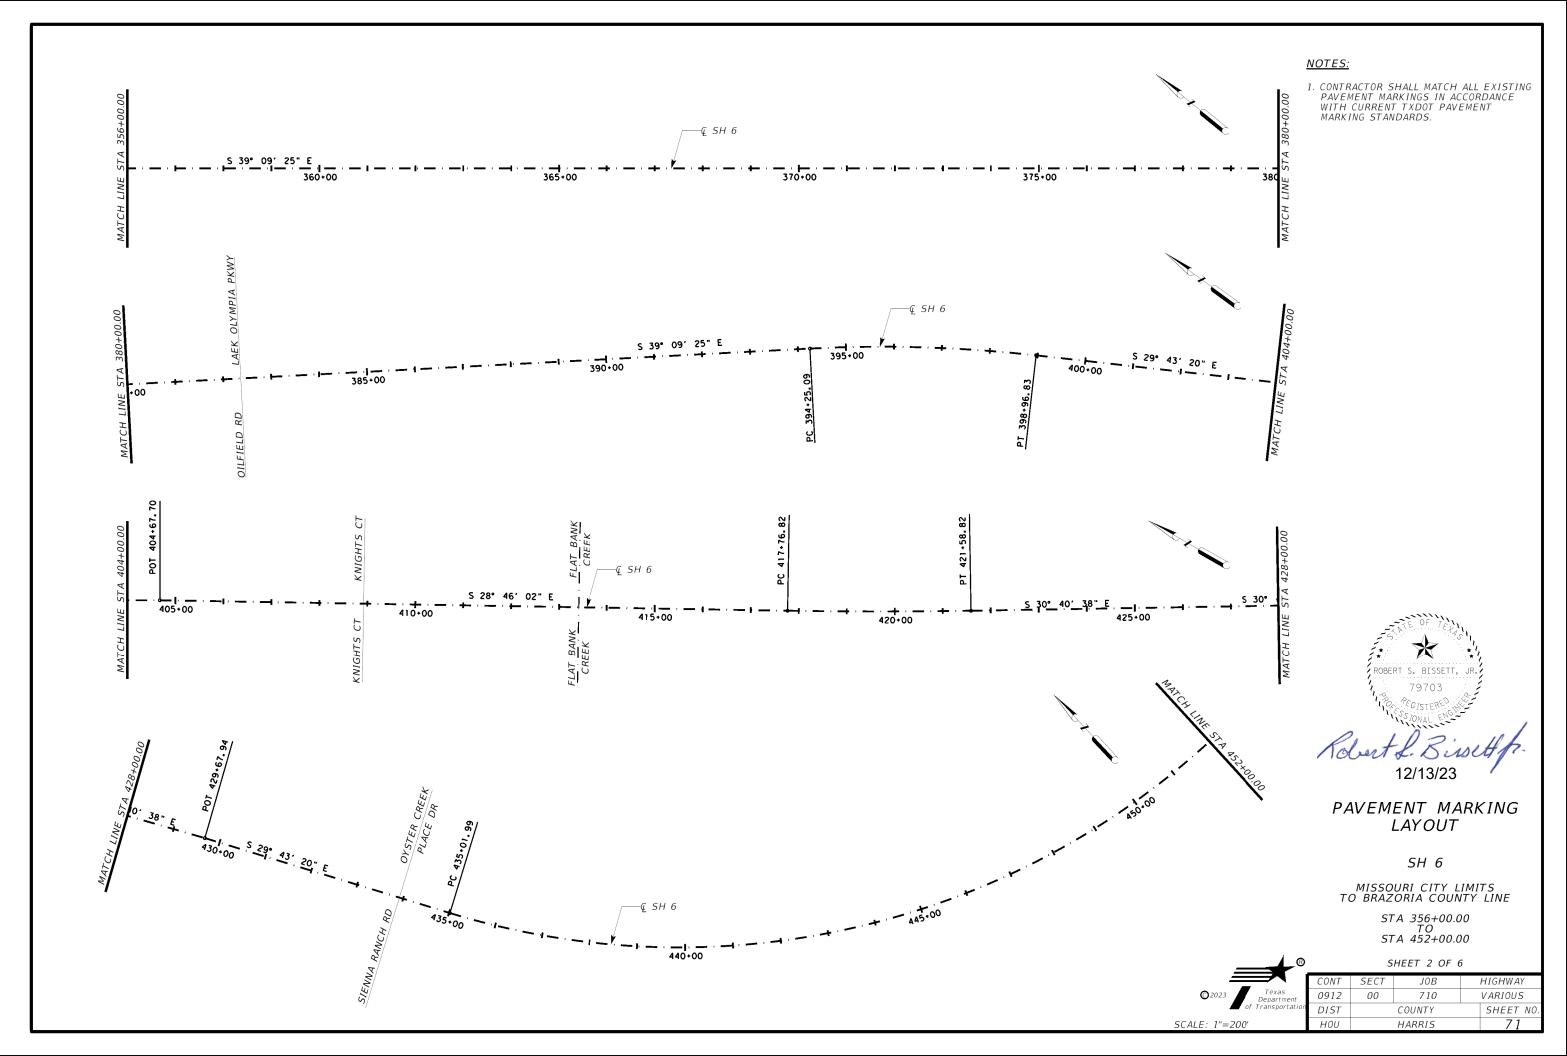

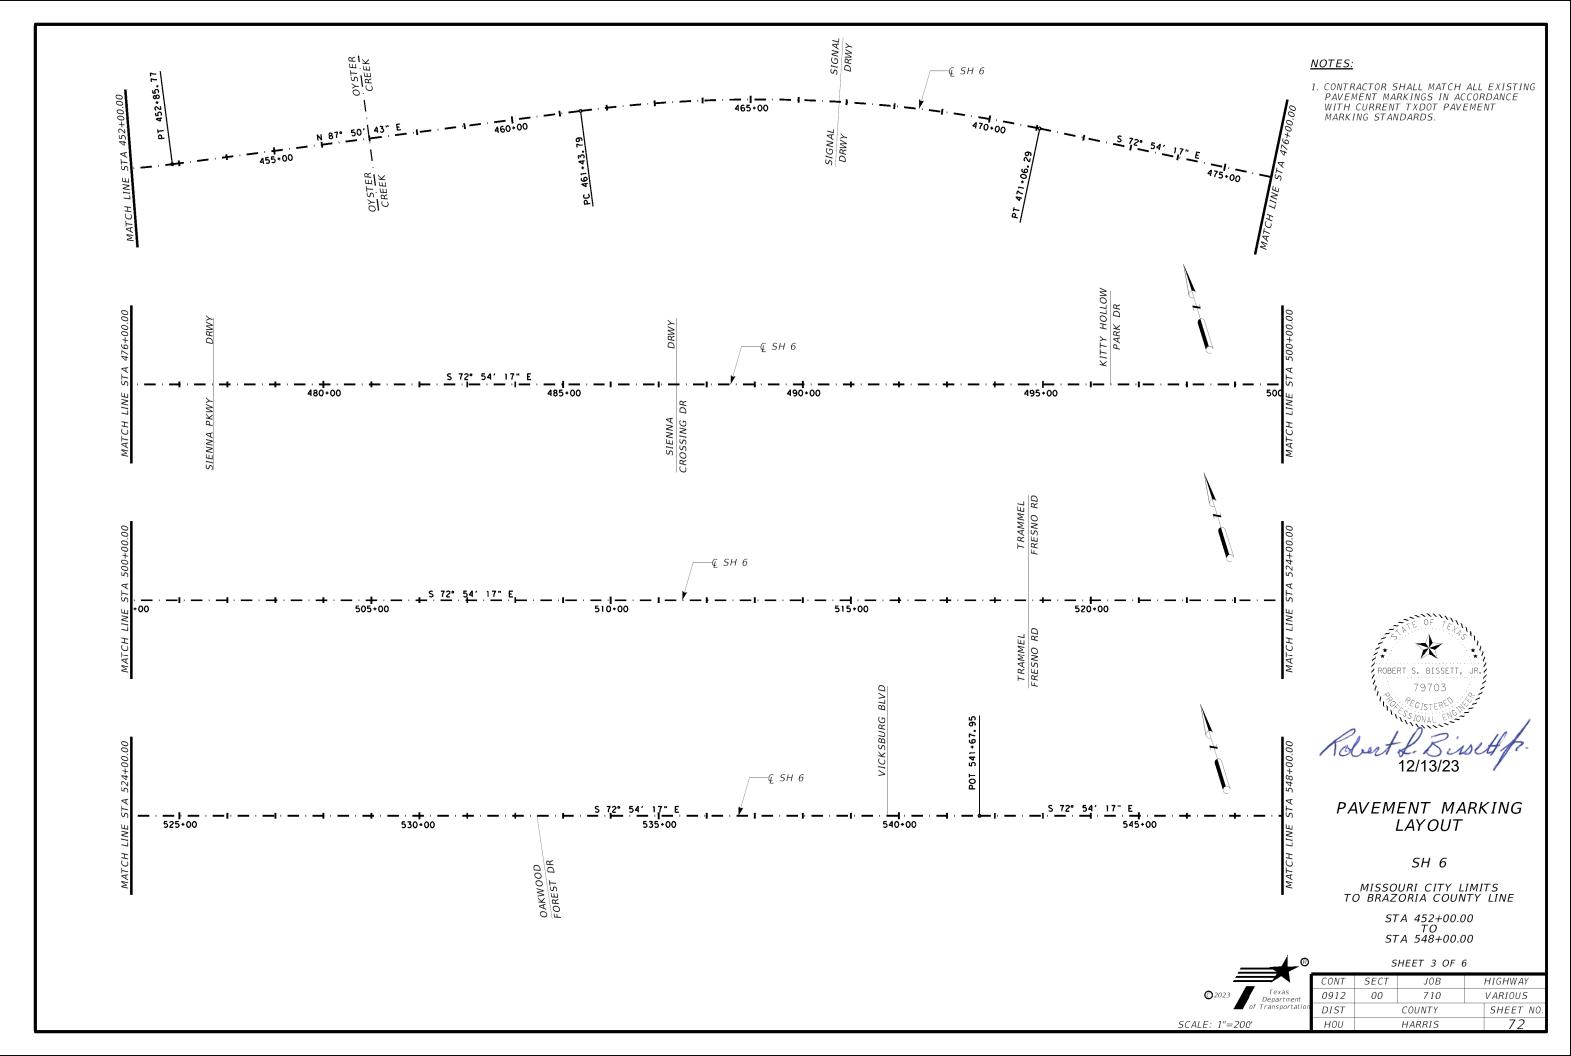


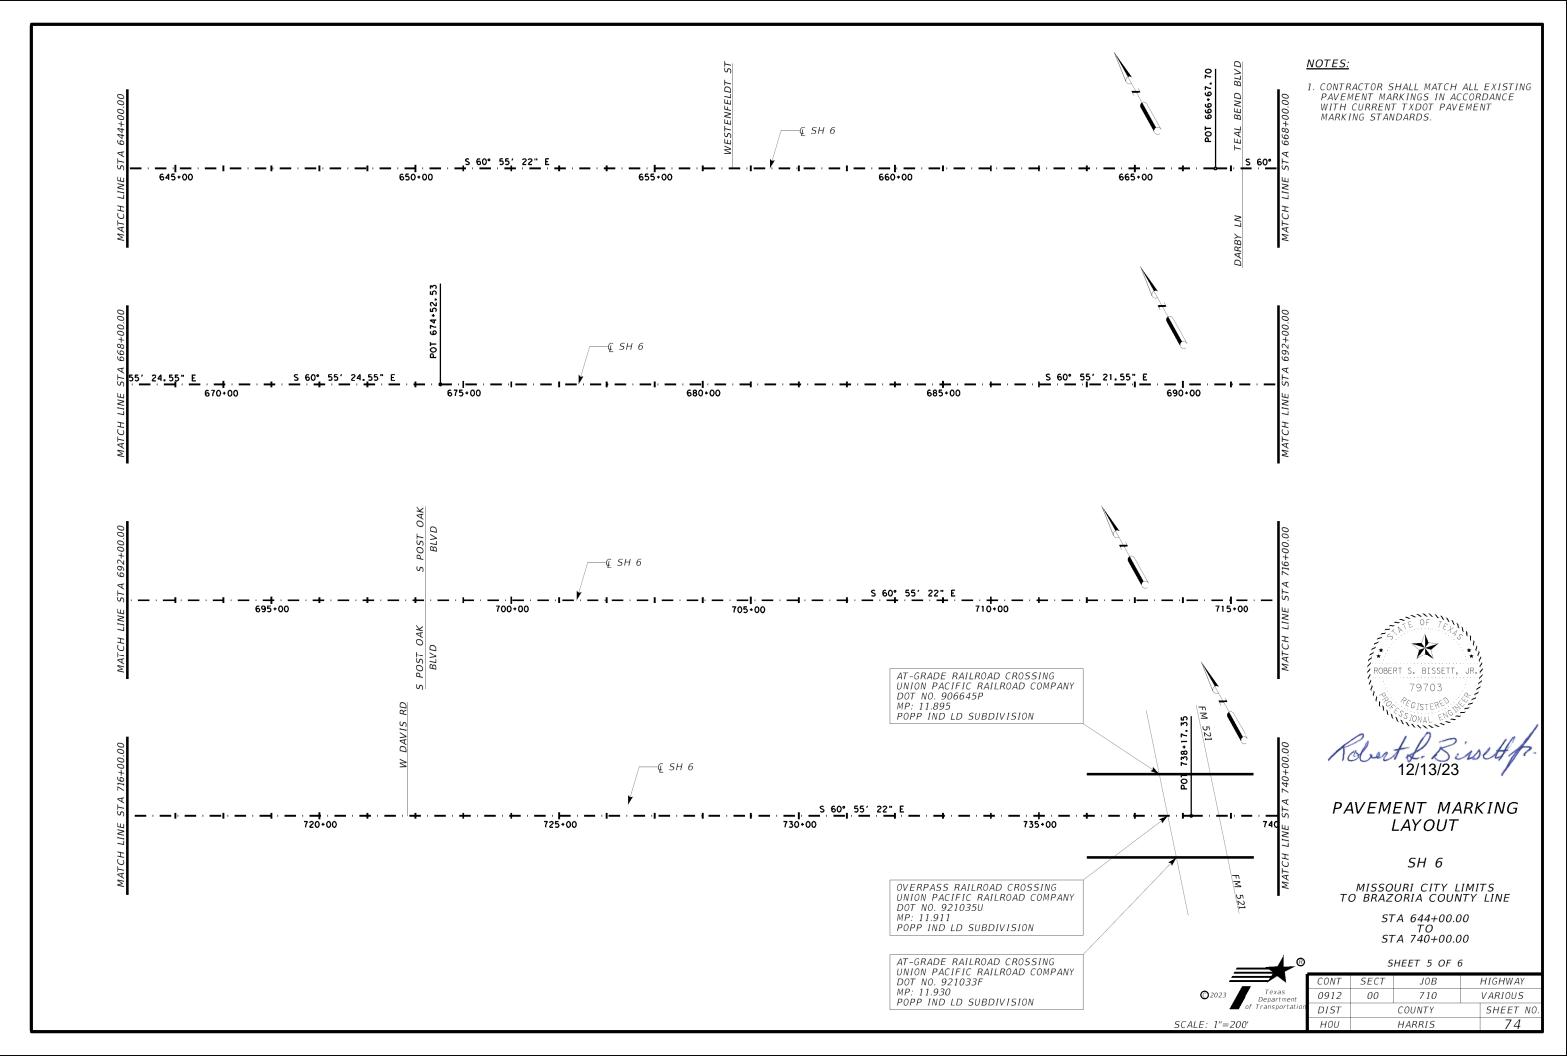

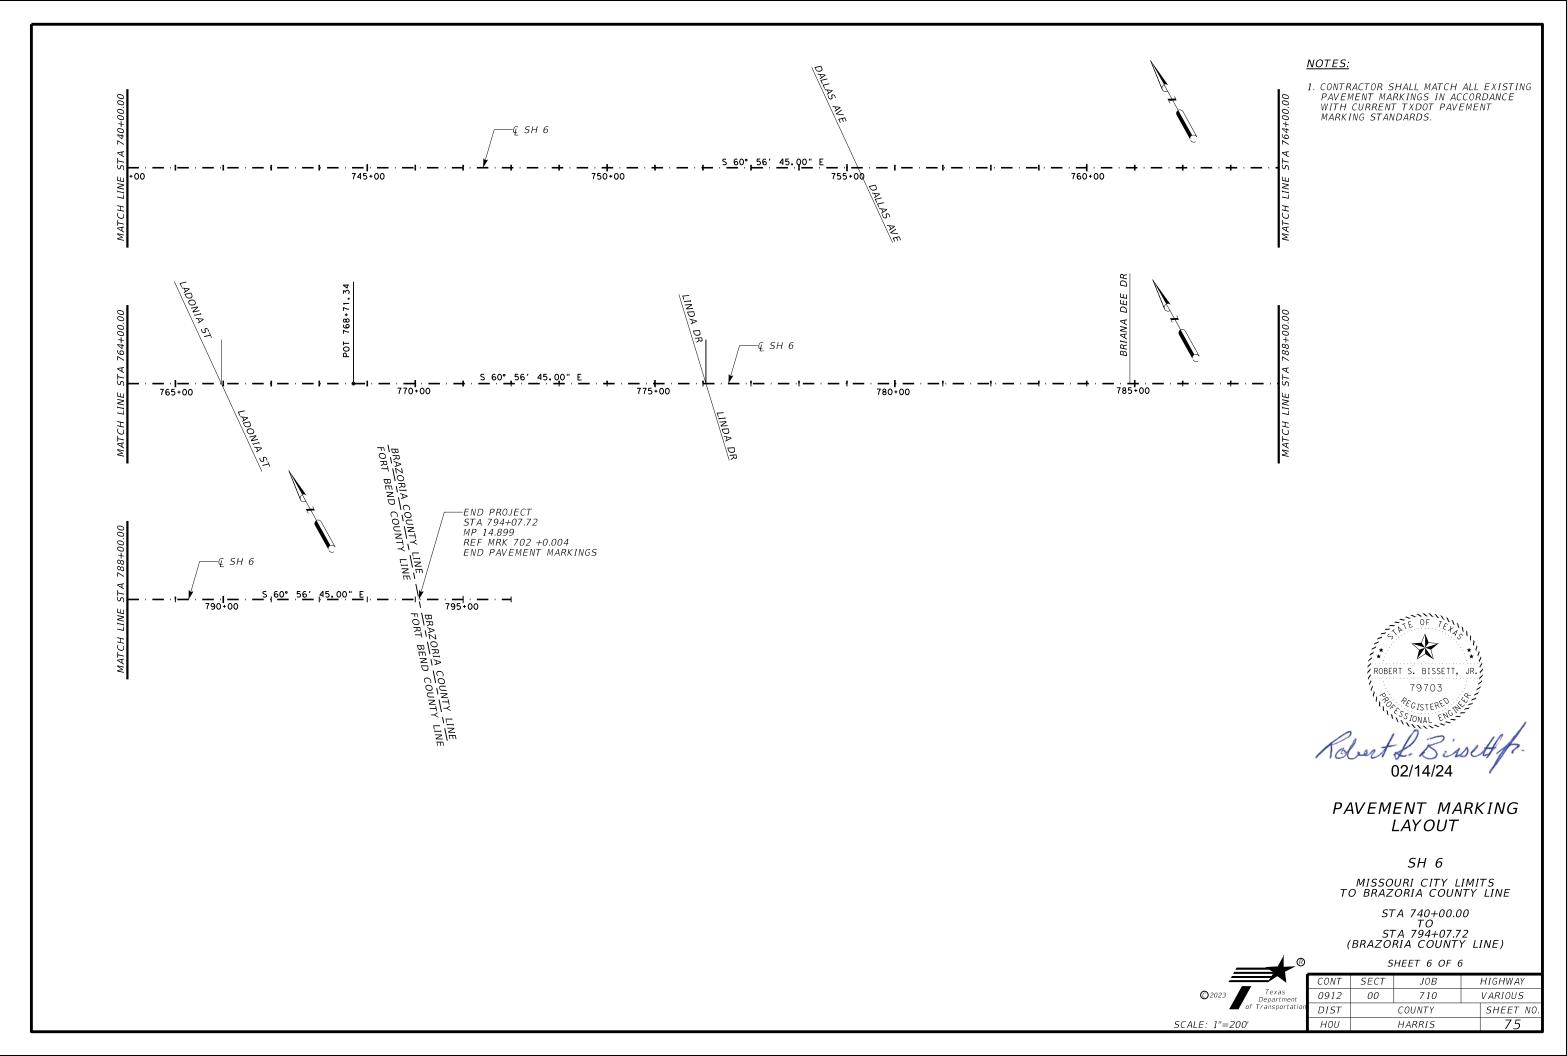


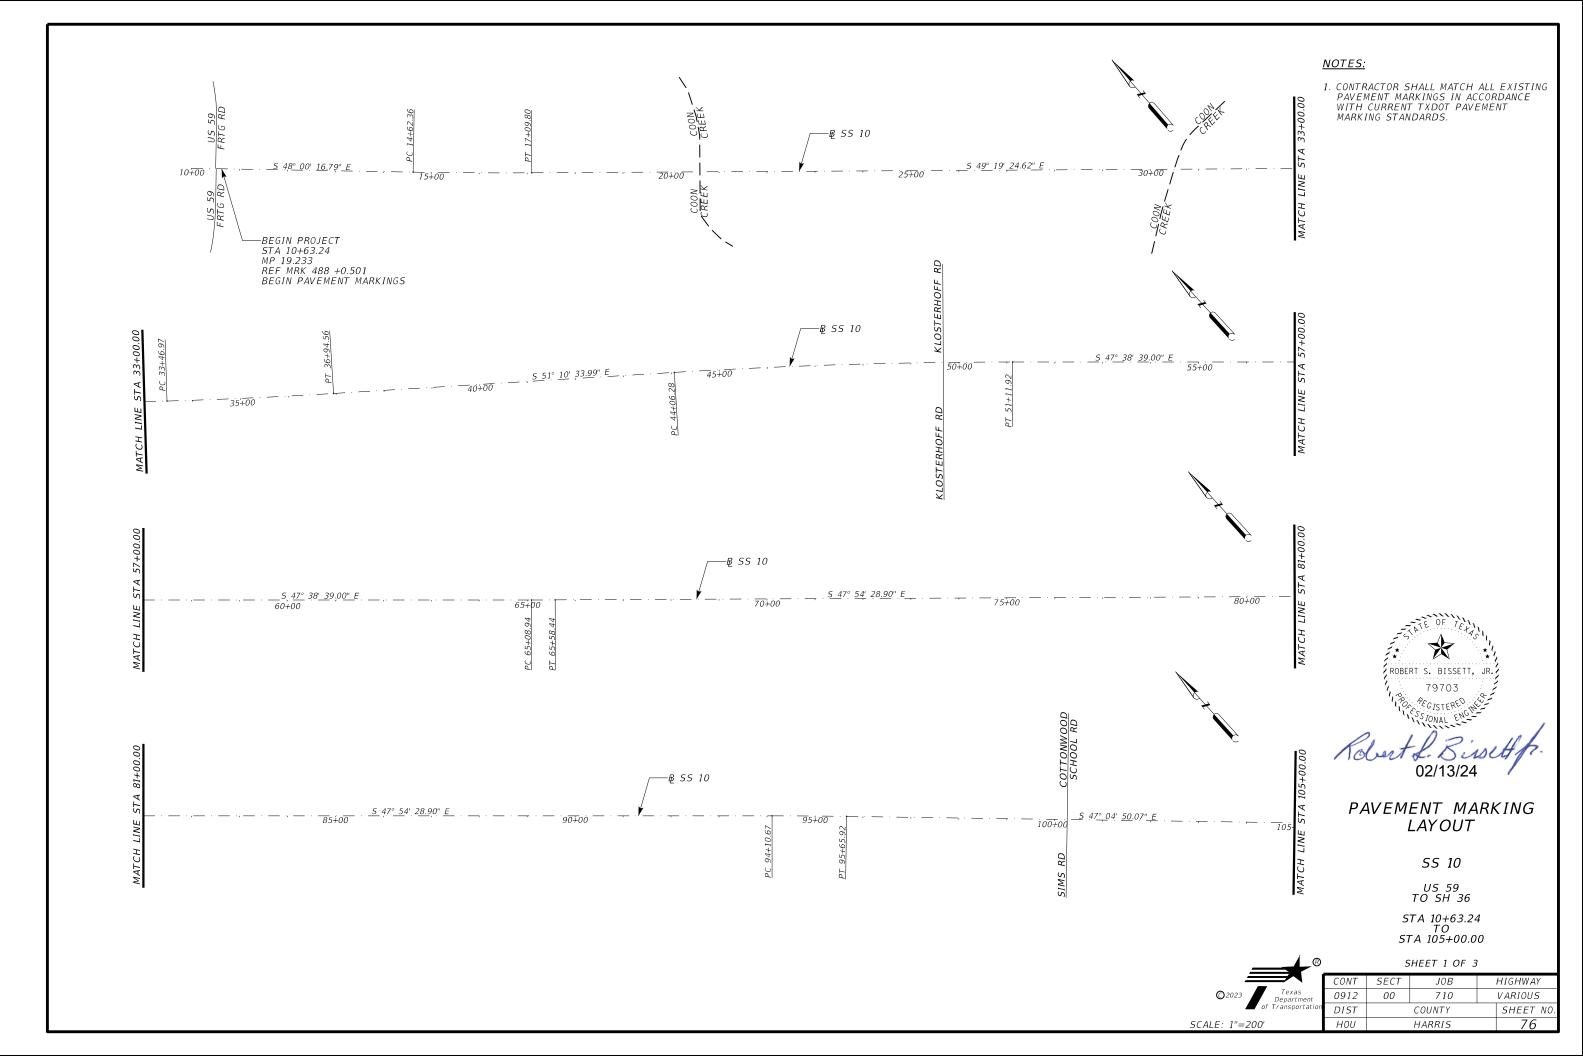




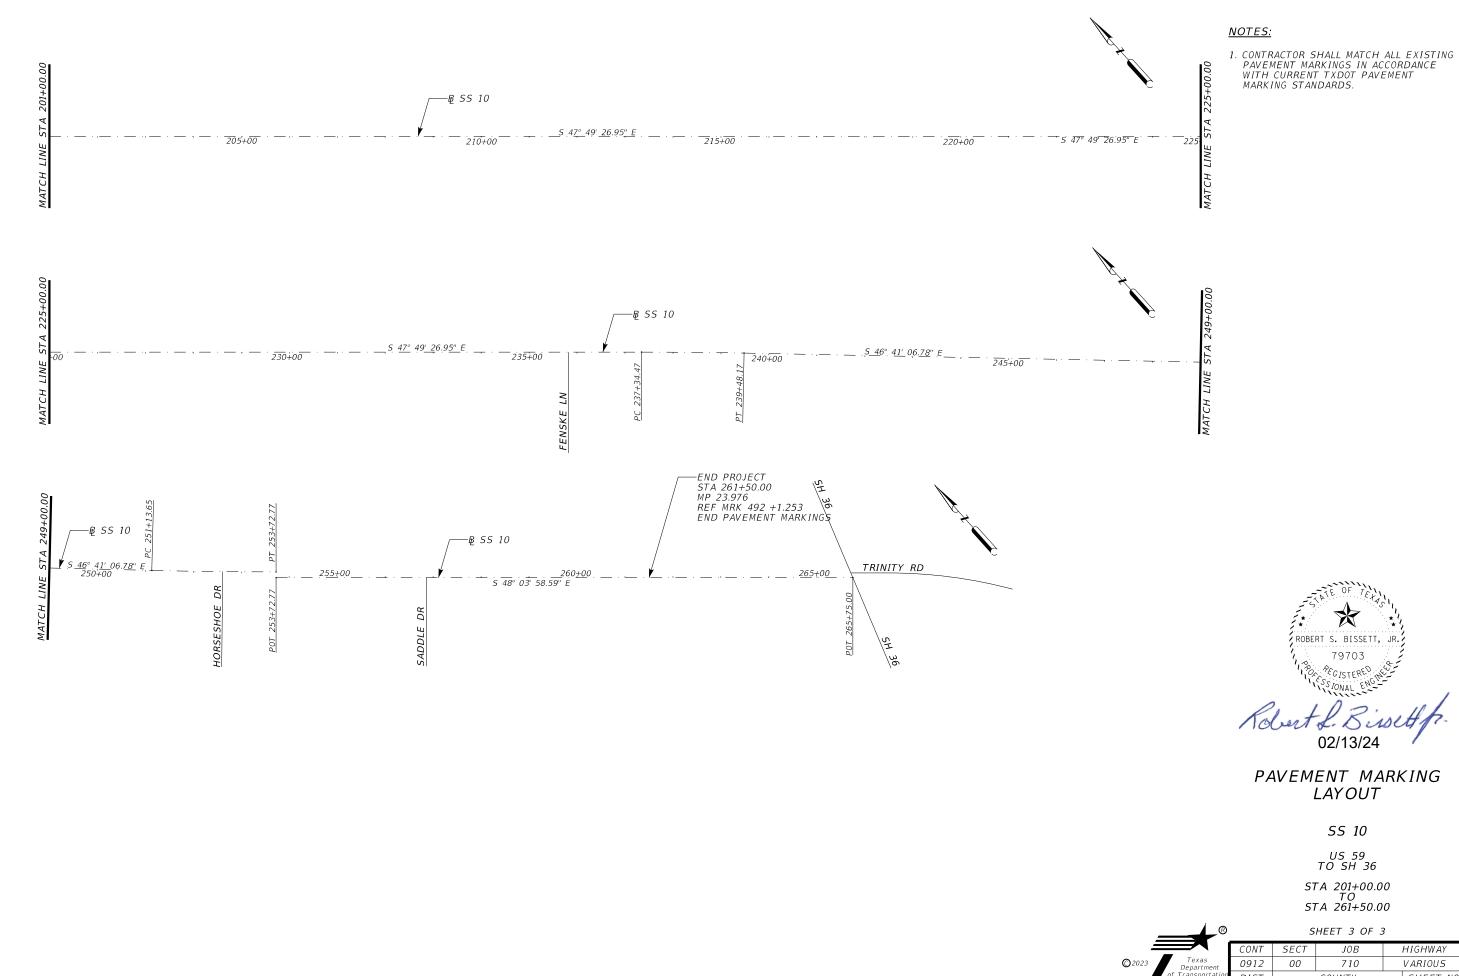

	CONT	SECT	JOB	HIGHWAY
©2023 Texas Department	0912	00	710	VARIOUS
of Transportation	DIST		COUNTY	SHEET NO.
SCALE: 1"=200'	HOU		HARRIS	78

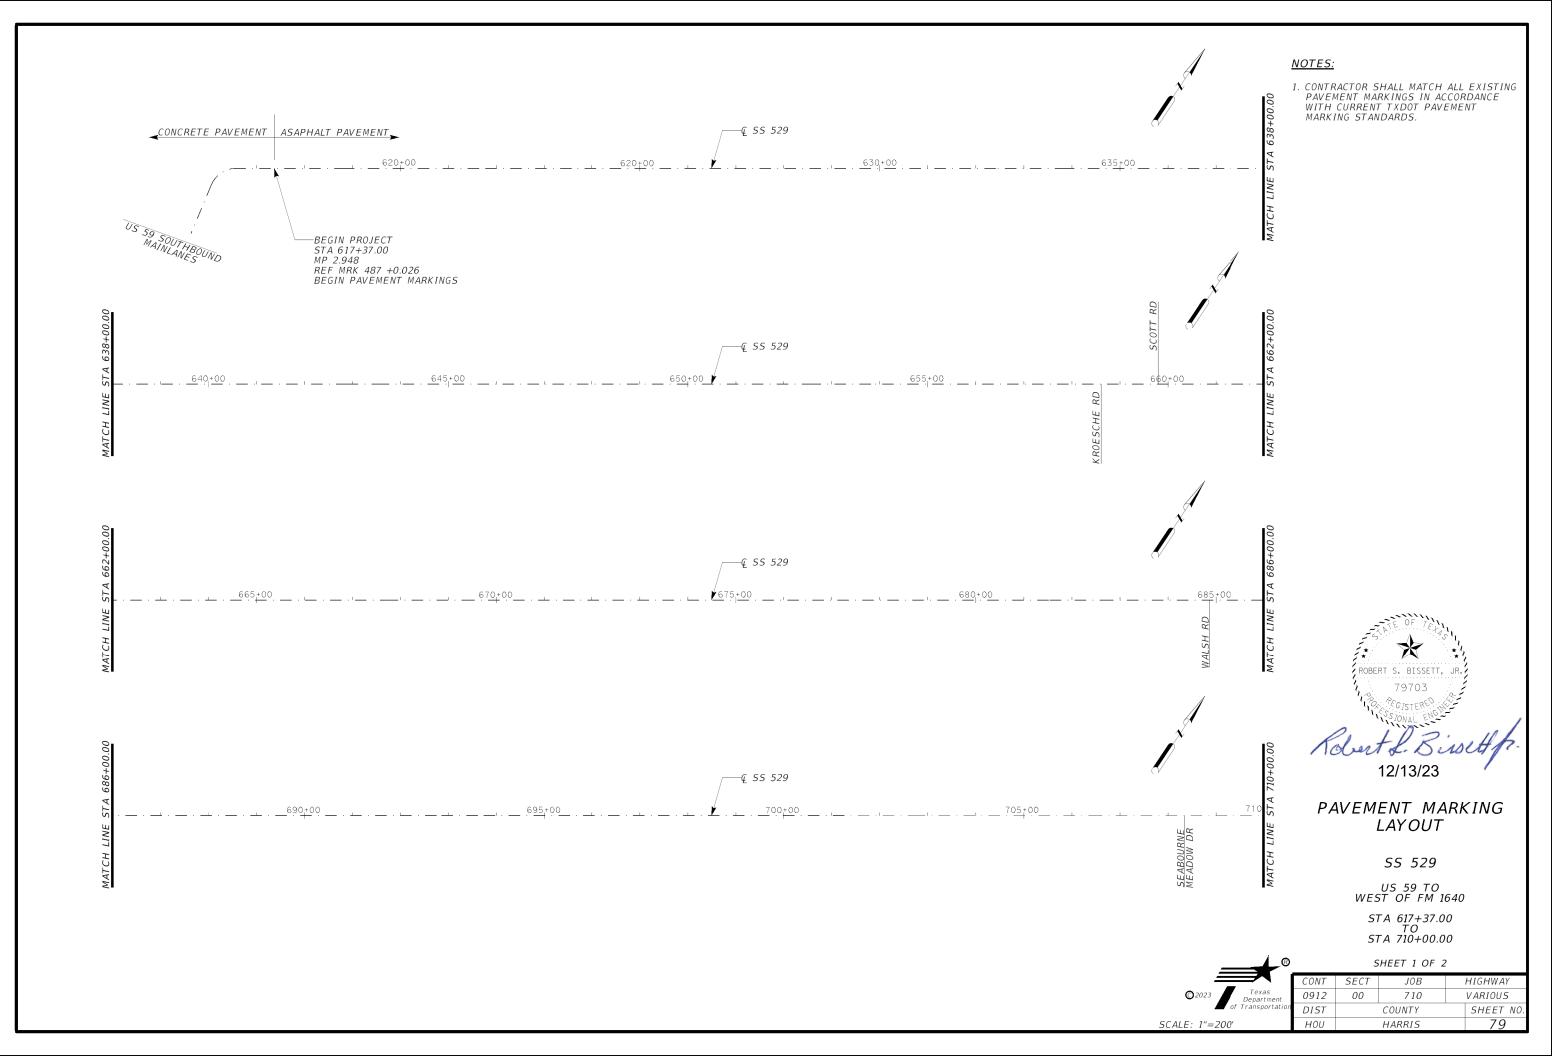

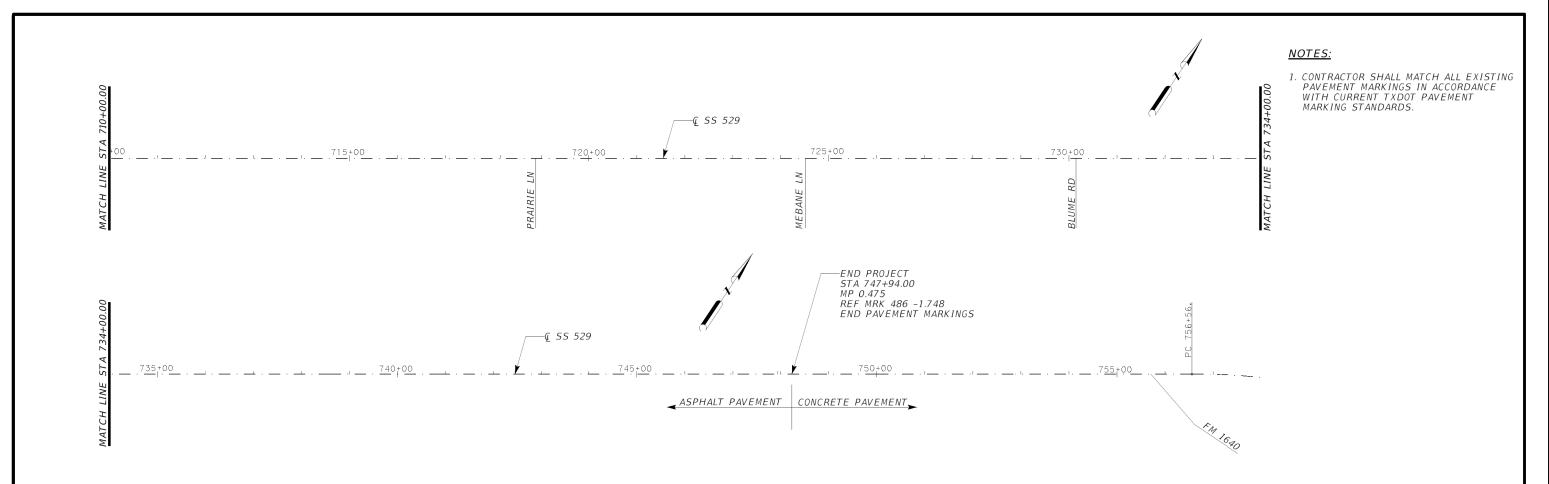




## PAVEMENT MARKING LAYOUT


SS 529

US 59 TO WEST OF FM 1640 STA 710+00.00 TO STA 747+94.00


	SHEET 2 OF 2				
	CONT	SECT	JOB		HIGHWAY
©2023 Texas Department	0912	00	710		VARIOUS
of Transportation	DIST		COUNTY		SHEET NO.
SCALE: 1"=200'	HOU		HARRIS		80

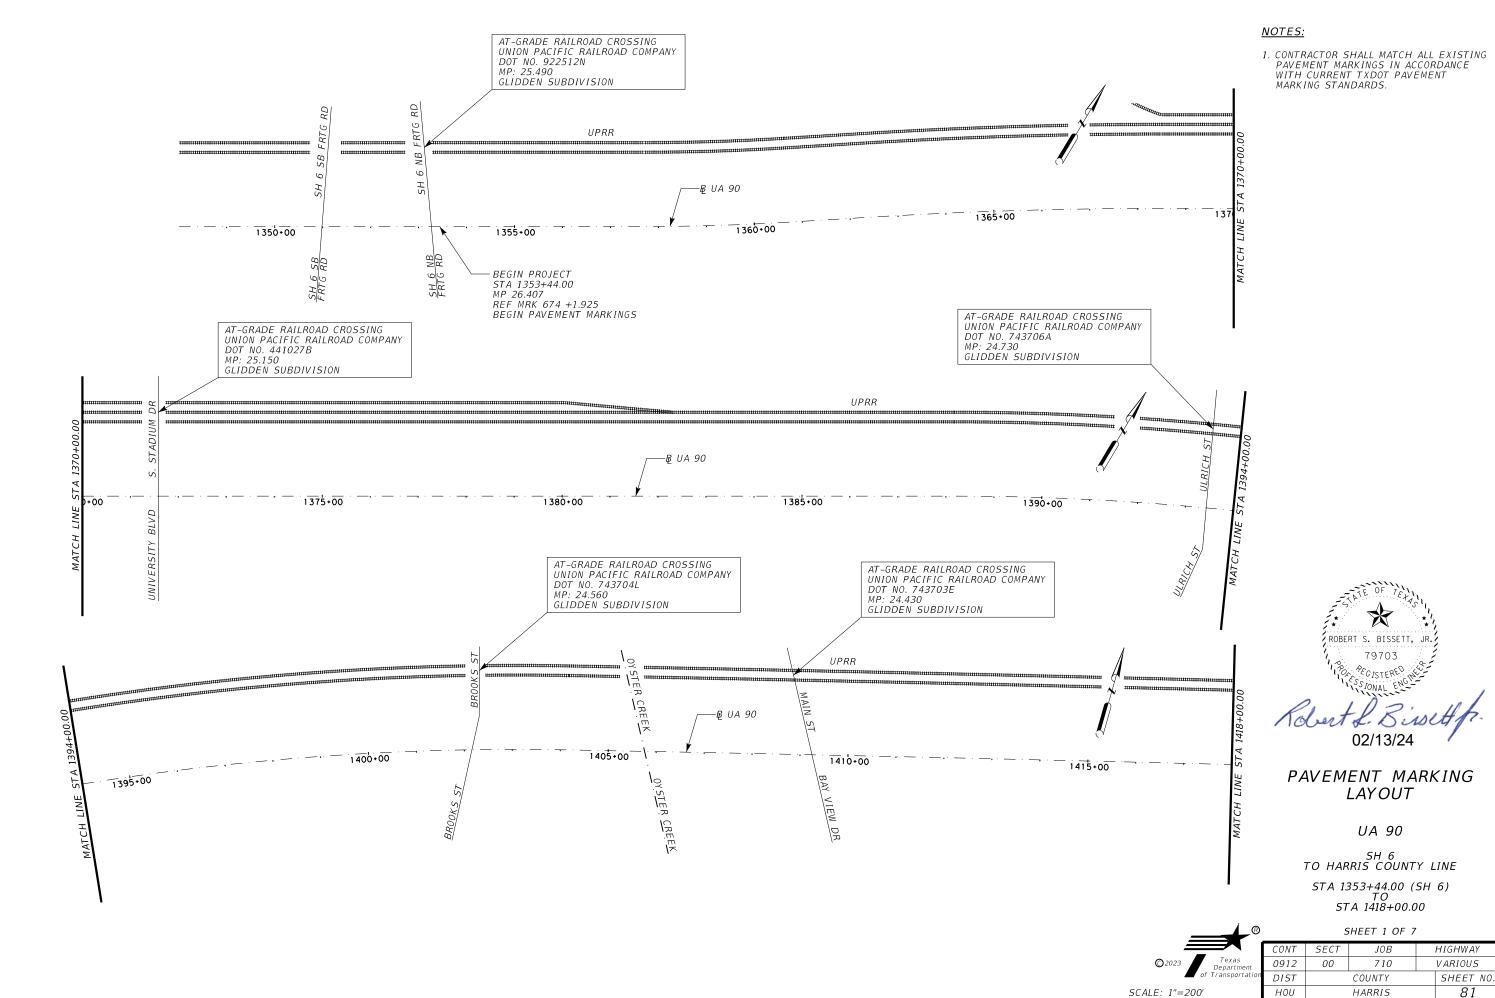





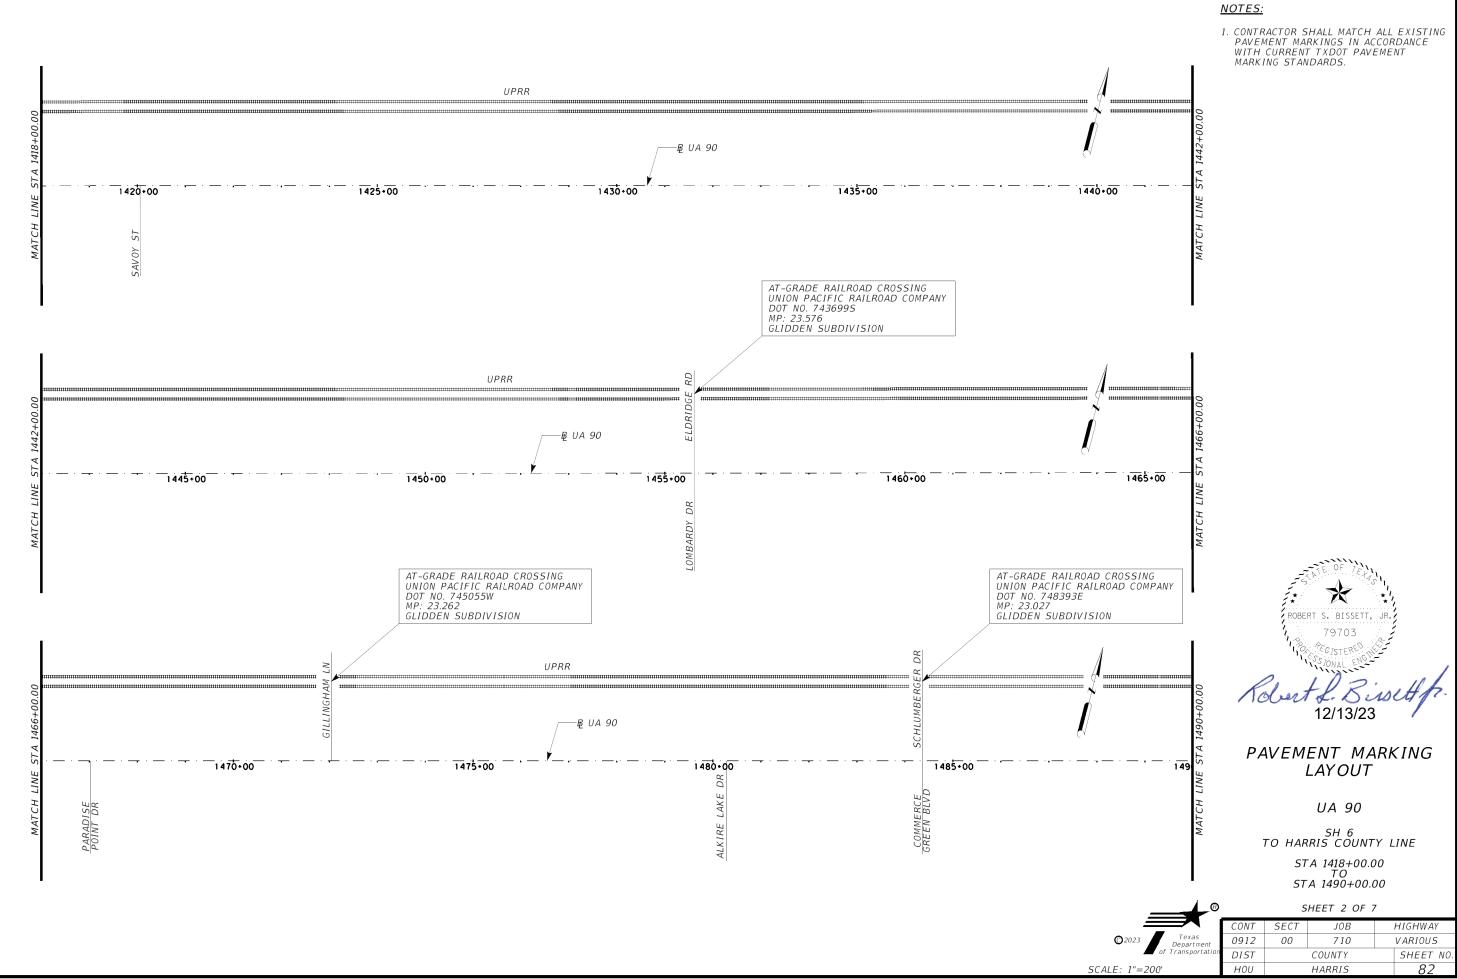





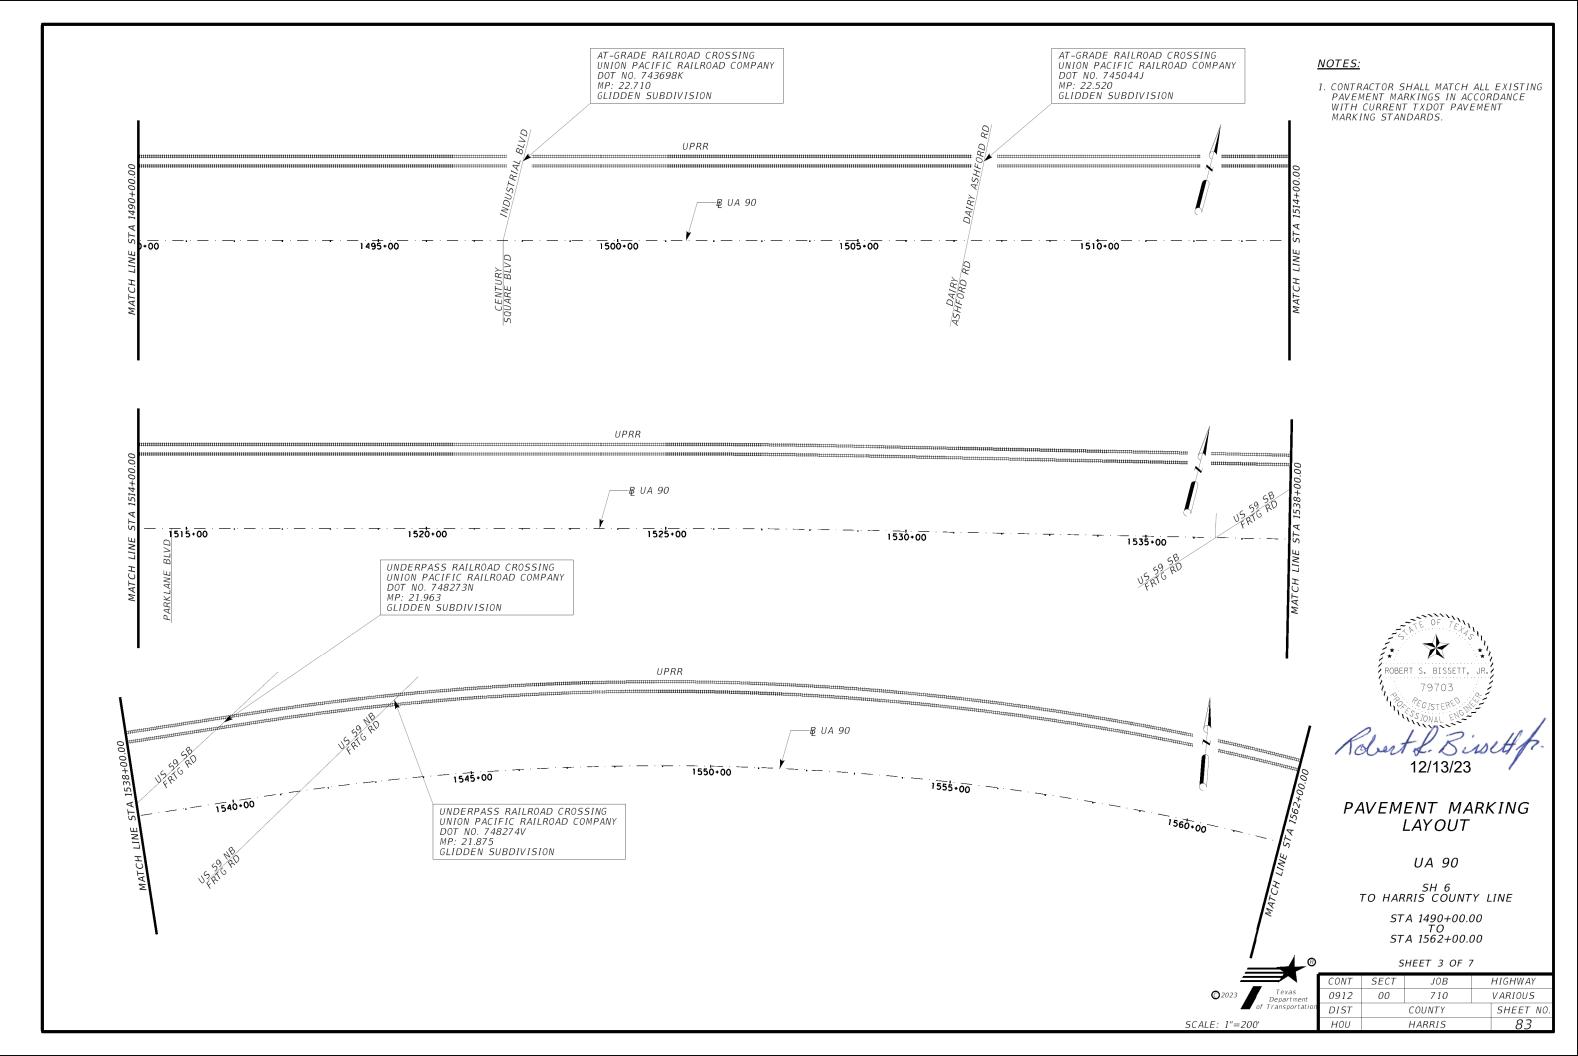


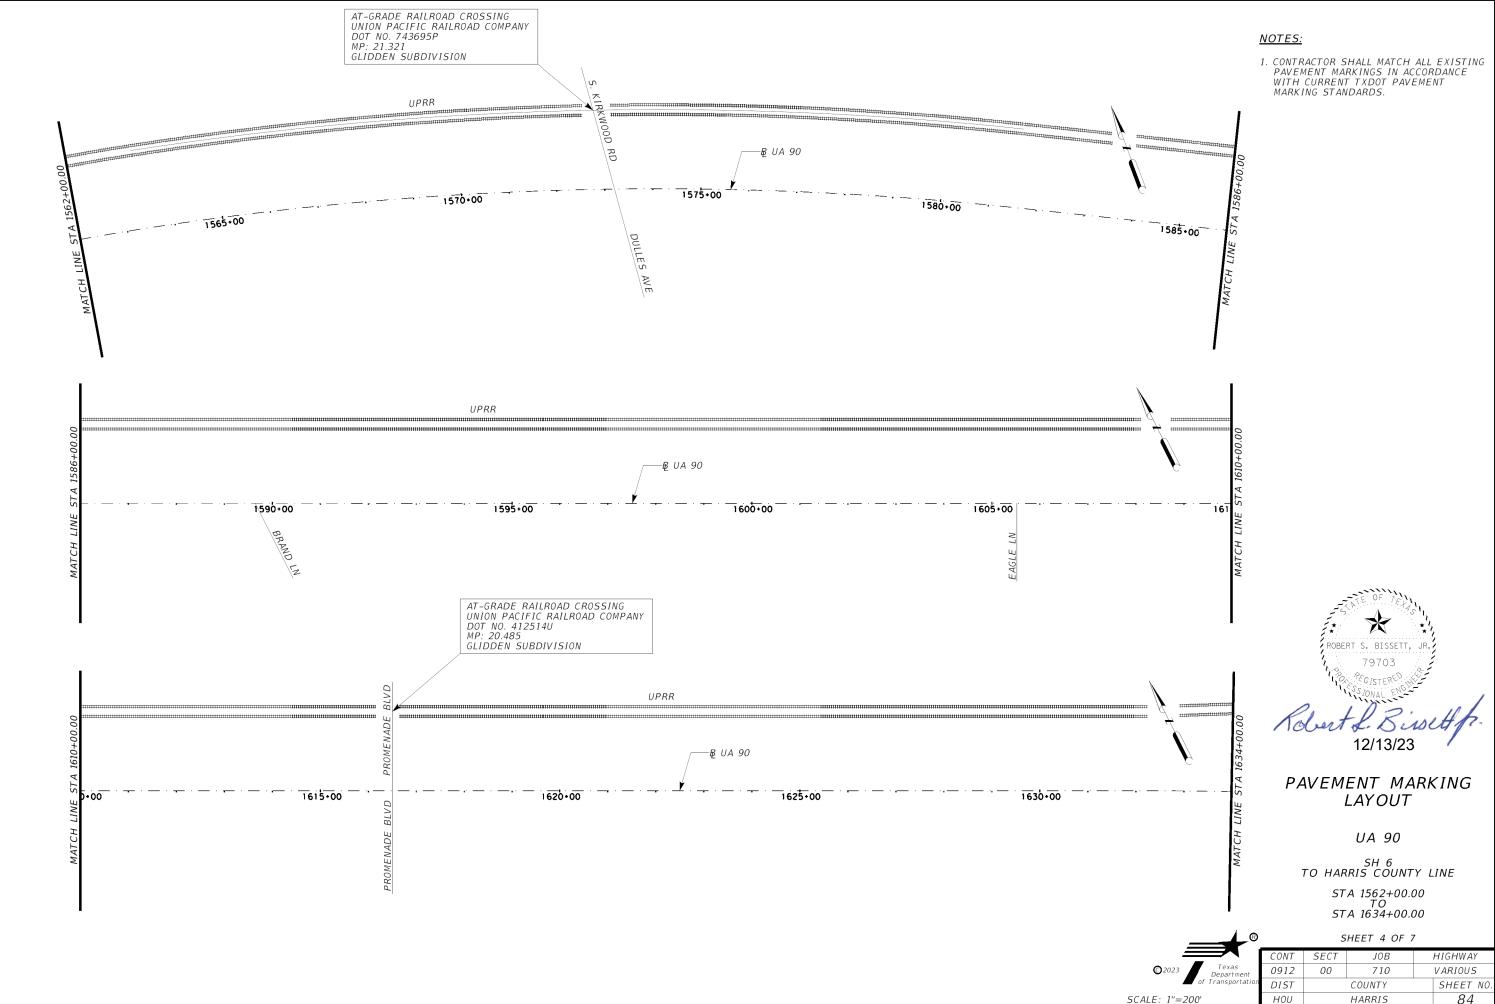


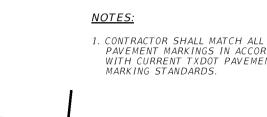

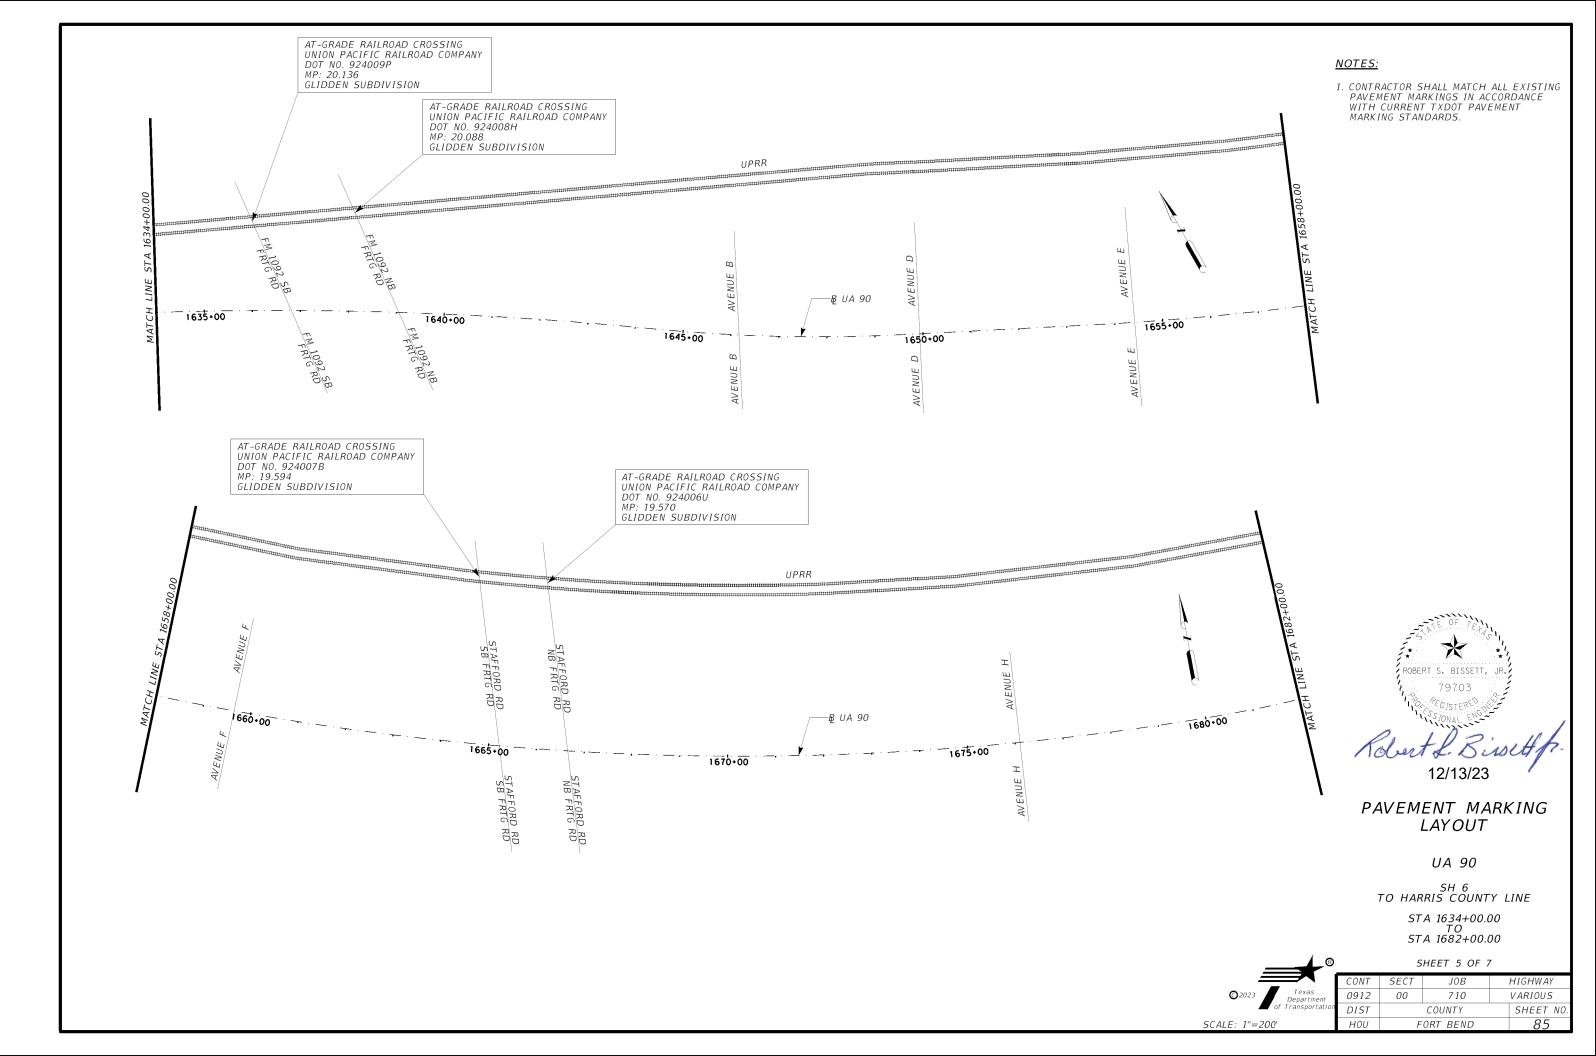

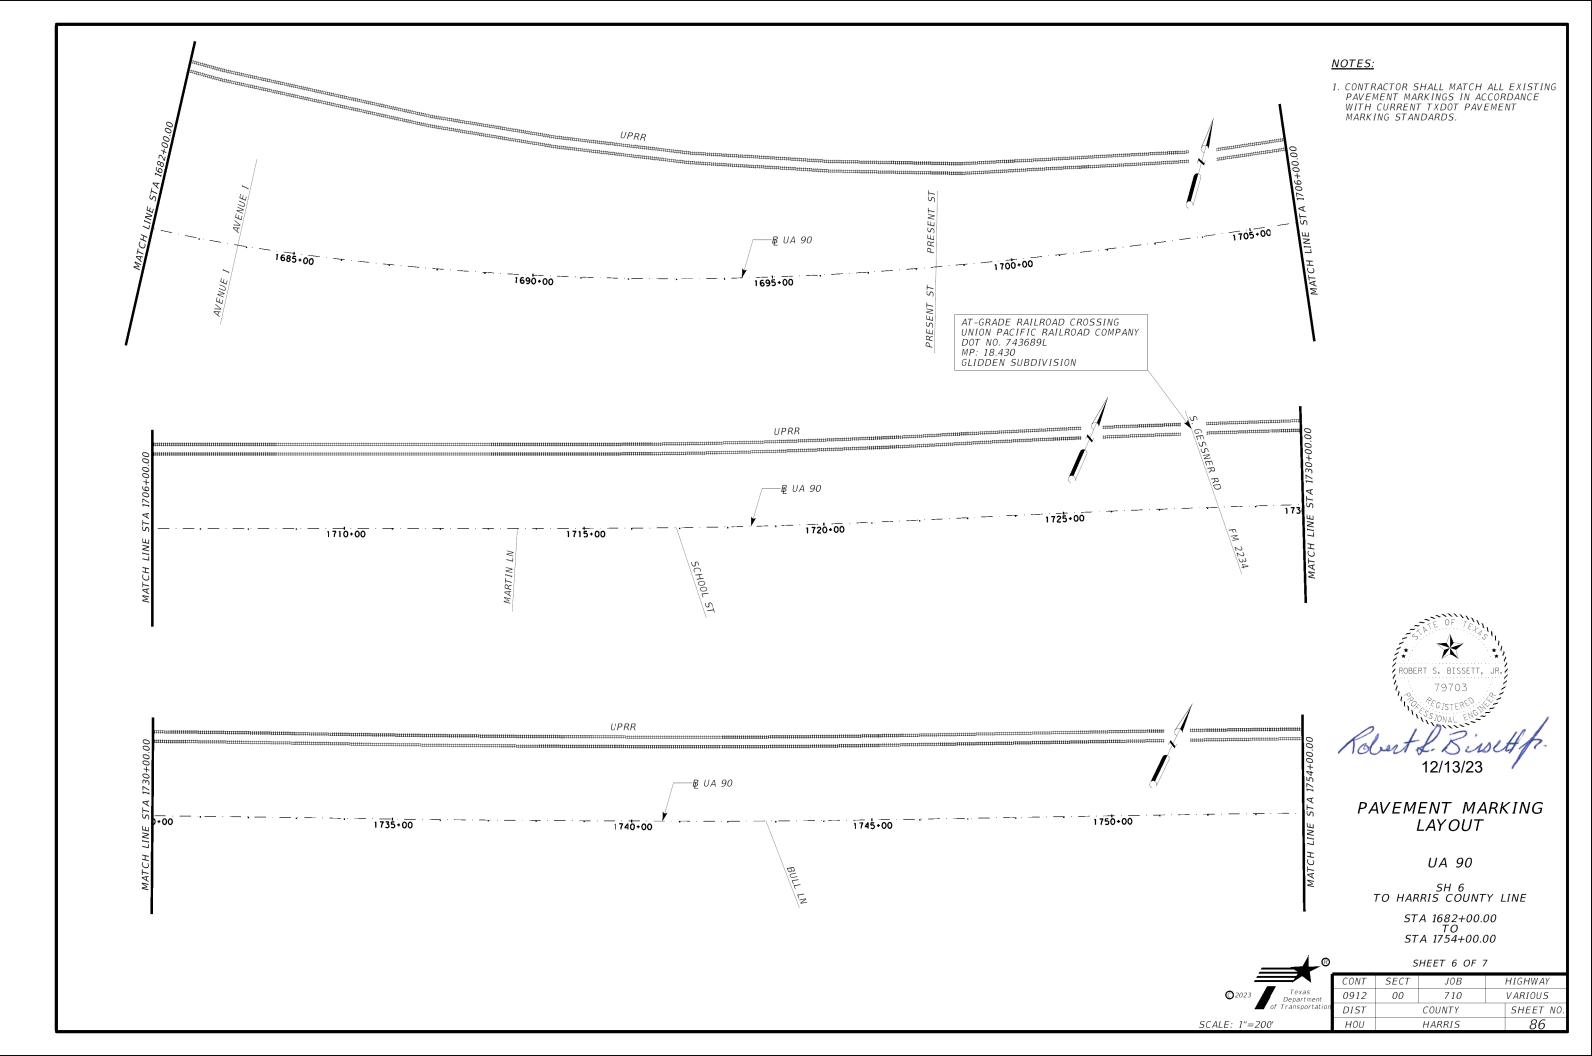

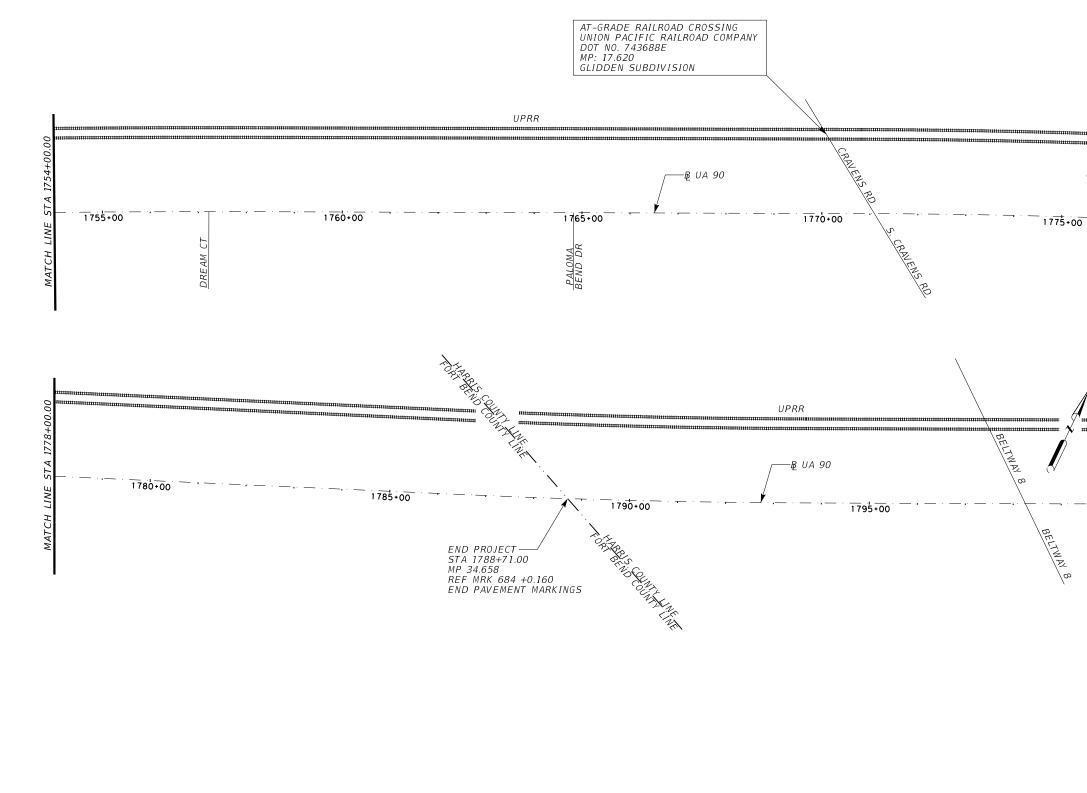

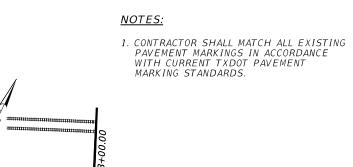


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LINE

MATCH

1800+00




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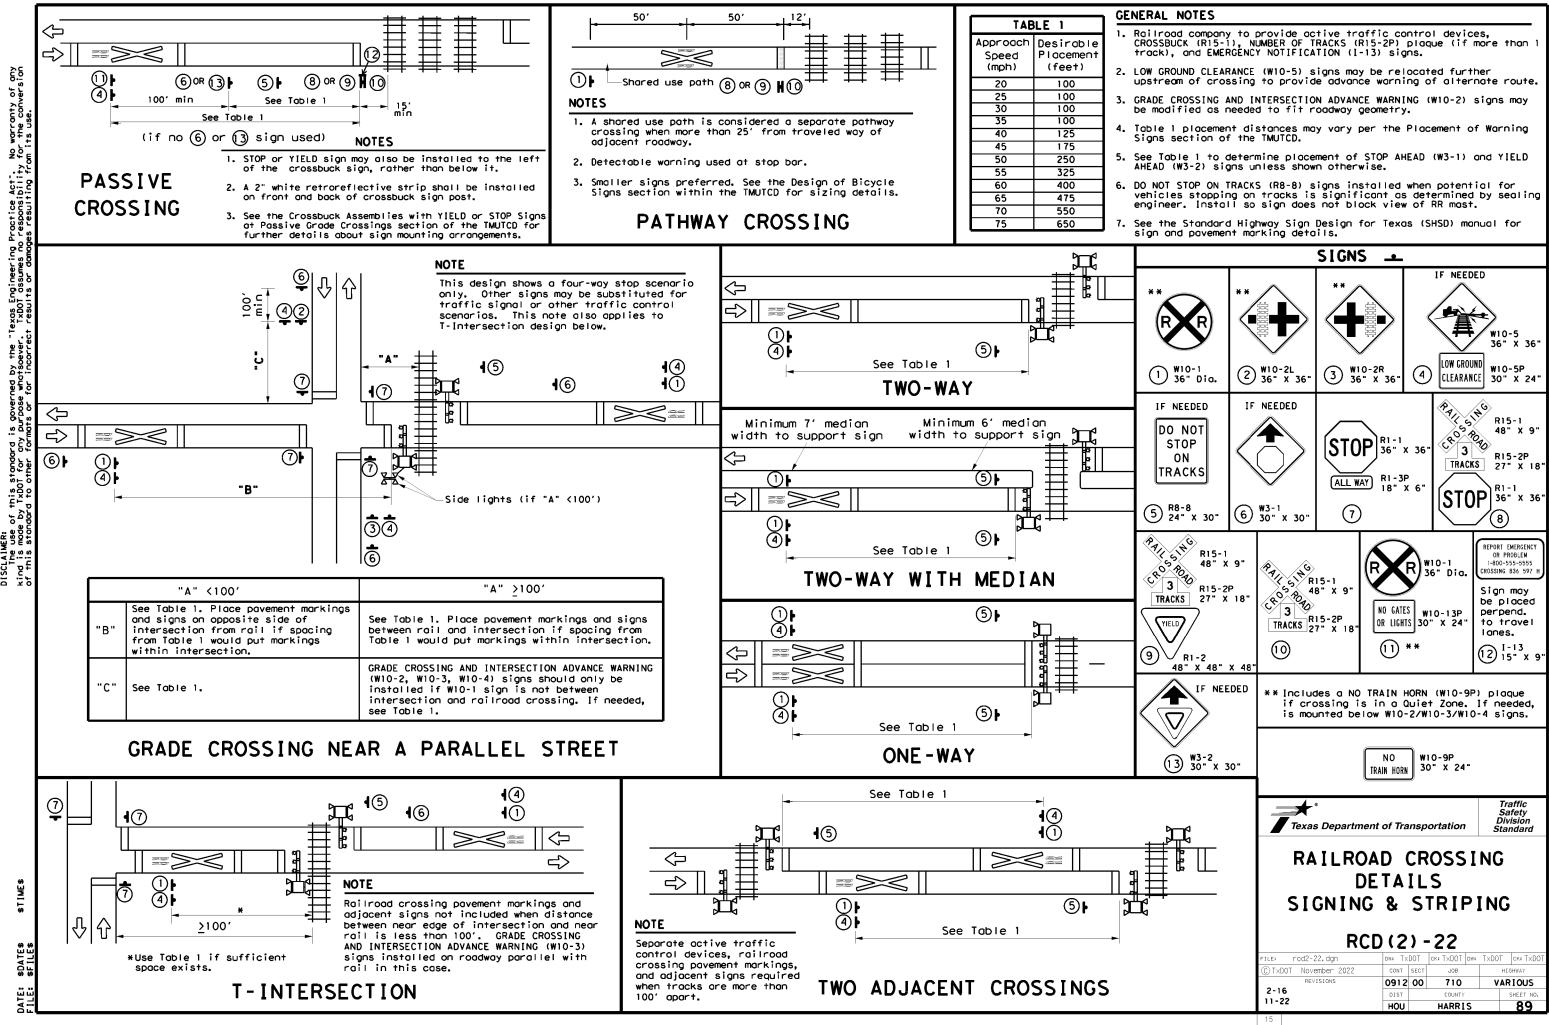
PAVEMENT MARKING LAYOUT

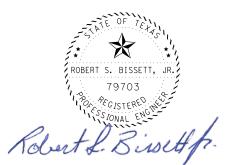
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SH 6 TO HARRIS COUNTY LINE STA 1754+00.00 TO STA 1788+71.00 (HARRIS COUNTY LINE)

		SHEET 7 OF 7				
	CONT	SECT	JOB		HIGHWAY	
©2023 Texas Department	0912	00	710		VARIOUS	
of Transportation	DIST		COUNTY		SHEET NO.	
SCALE: 1"=200'	HOU		HARRIS		87	






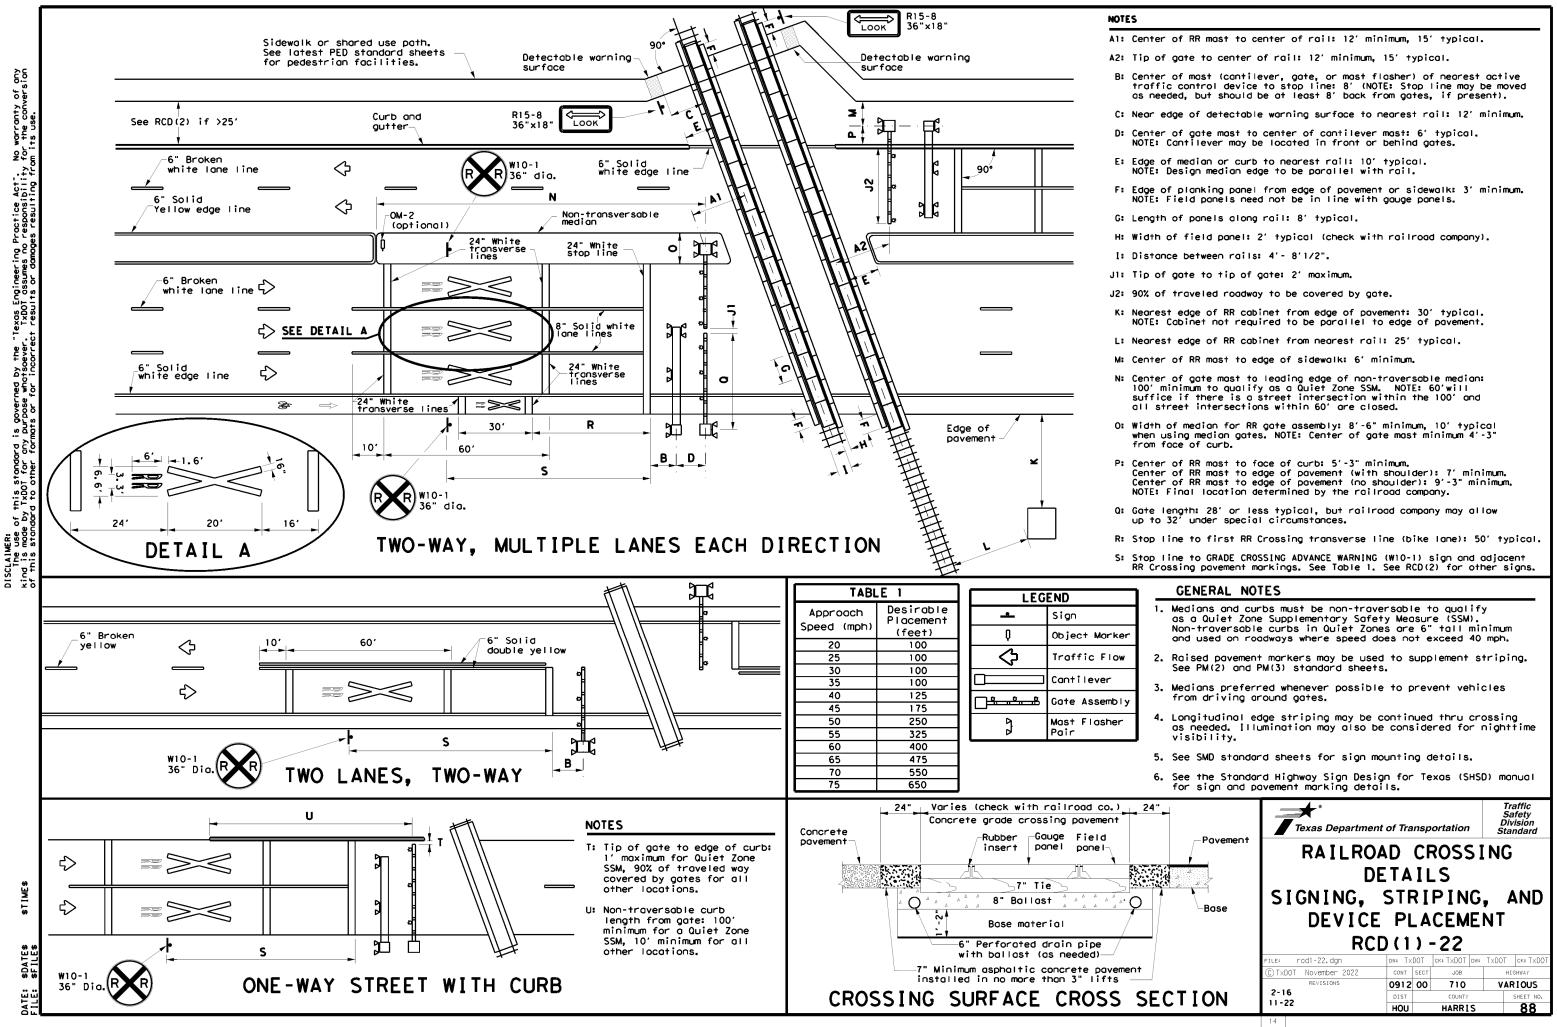

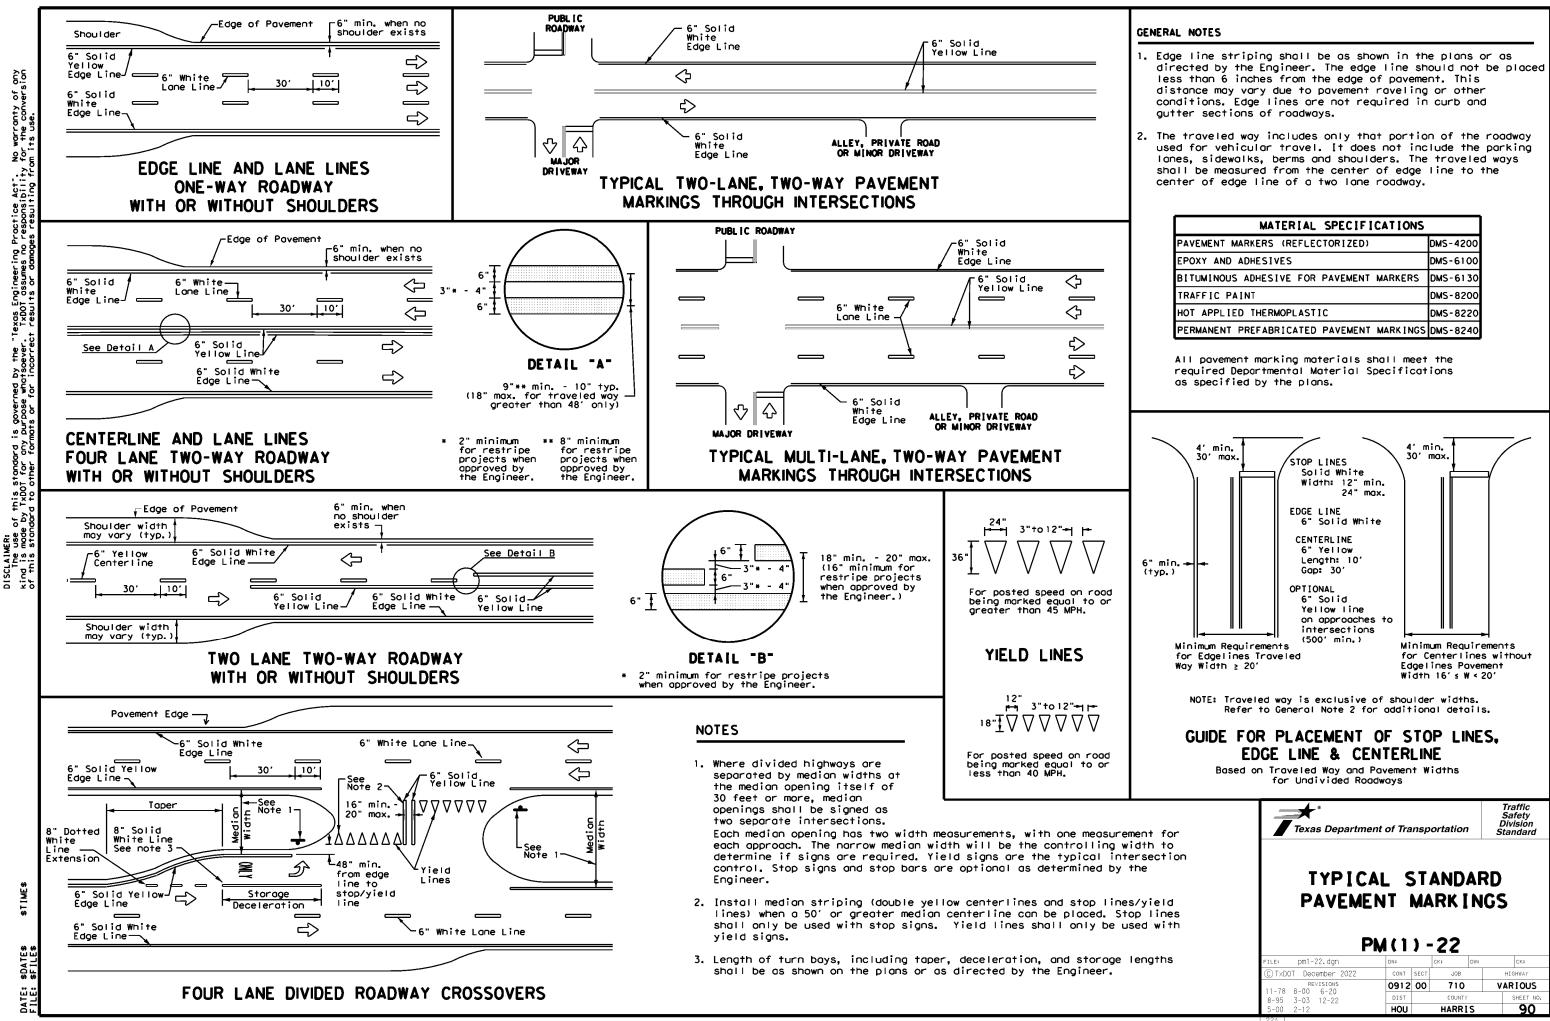
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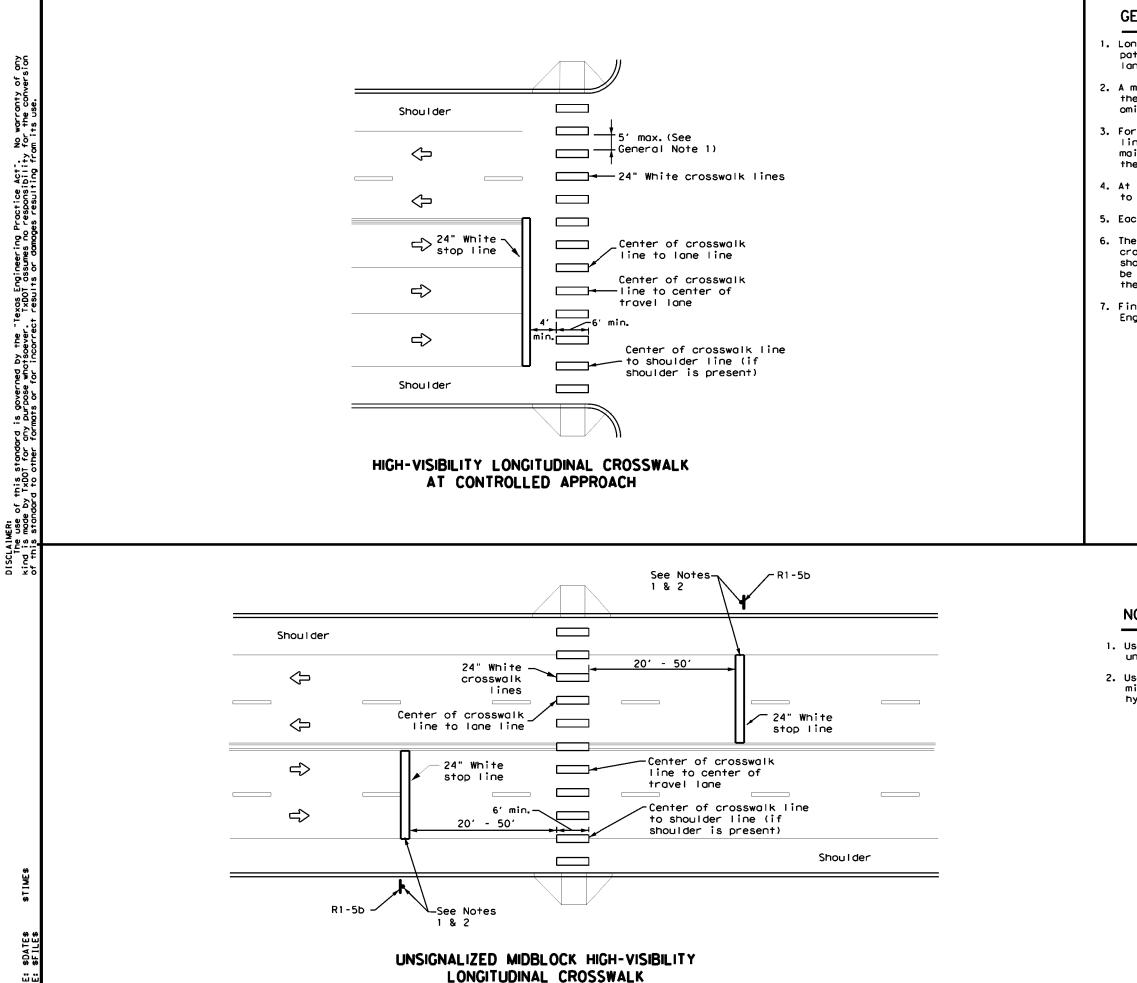
MATERIAL SPECIFICATIONS	
PAVEMENT MARKERS (REFLECTORIZED)	DMS-4200
EPOXY AND ADHESIVES	DMS-6100
BITUMINOUS ADHESIVE FOR PAVEMENT MARKERS	DMS-6130
TRAFFIC PAINT	DMS-8200
HOT APPLIED THERMOPLASTIC	DMS-8220
PERMANENT PREFABRICATED PAVEMENT MARKINGS	DMS-8240

# FOR VEHICLE POSITIONING GUIDANCE

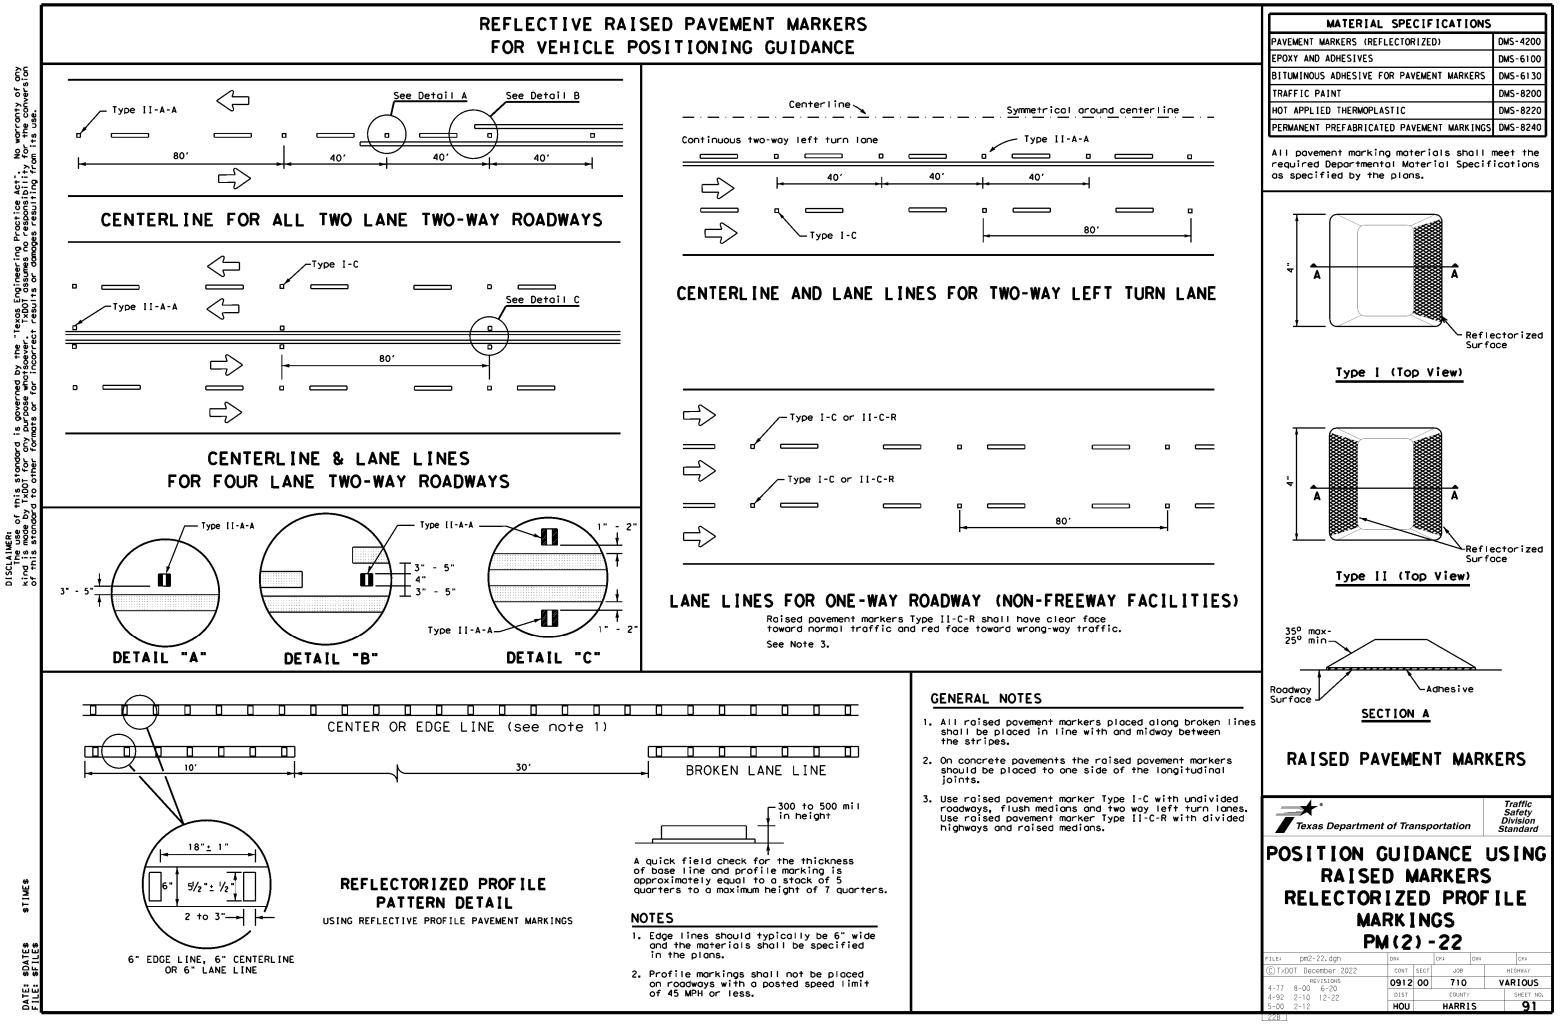

No warranty of any for the conversion on its use. is governed by the "Texas Engineering Practice Act". purpose whatsoever. TxDDT assumes no responsibility wats or for incorrect results or damages resulting fro this standard y TxDOT for any 2 S



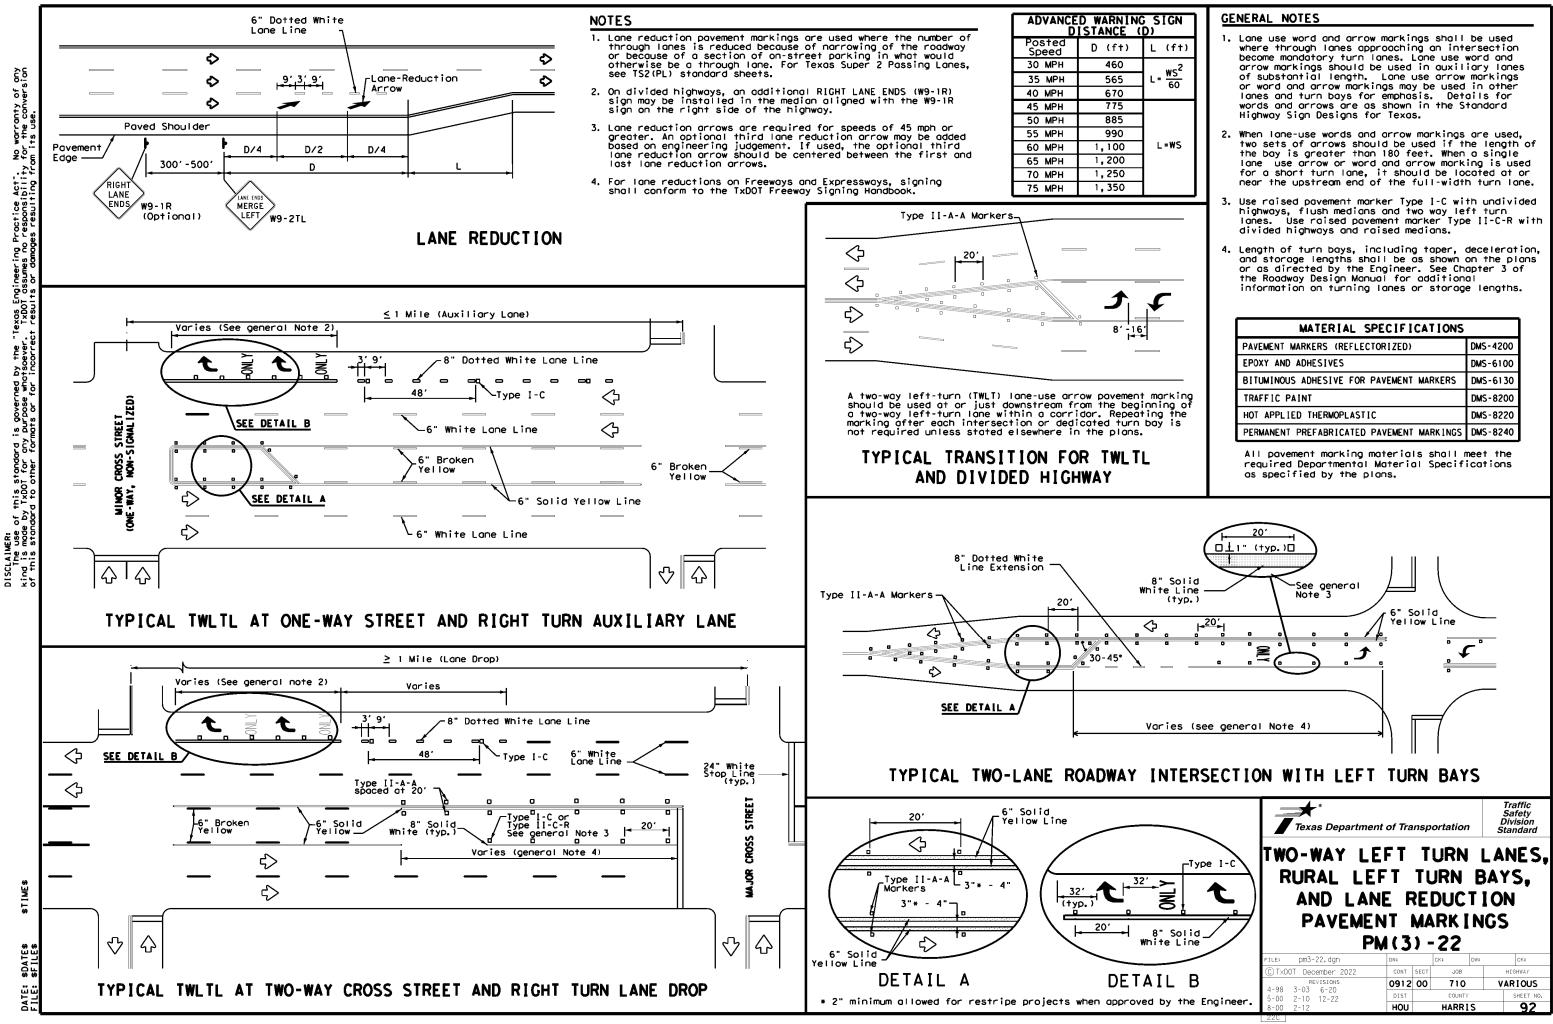

DATE: FIIF:

## GENERAL NOTES

- 1. Longitudinal crosswalk lines should not be placed in the wheel path of vehicles. Center the crosswalk lines on travel lanes, lane lines, and shoulder lines (if present).
- 2. A minimum 6" clear distance shall be provided to the curb face. If the last crosswalk line falls into this distance it must be omitted.
- 3. For divided roadways, adjustments in spacing of the crosswalk lines should be made in the median so that the crosswalk lines are maintained in their proper location across the travel portion of the roadway.
- 4. At skewed crosswalks, the crosswalk lines are to remain parallel to the lane lines.
- 5. Each crosswalk shall be a minimum of 6' wide.
- 6. The High-Visibility Longitudinal Crosswalk is the preferred crosswalk pattern on State Highways. Other crosswalk patterns as shown in the "Texas Manual on Uniform Traffic Control Devices" may be used. All crosswalk designs and dimension shall comply with the "Texas Manual on Uniform Traffic Control Devices."
- 7. Final placement of Stop Bar and Crosswalk shall be approved by the Engineer in the field.


MATERIAL SPECIFICATIONS	
PAVEMENT MARKERS (REFLECTORIZED)	DMS-4200
EPOXY AND ADHESIVES	DMS-6100
BITUMINOUS ADHESIVE FOR PAVEMENT MARKERS	DMS-6130
TRAFFIC PAINT	DMS-8200
HOT APPLIED THERMOPLASTIC	DMS-8220
PERMANENT PREFABRICATED PAVEMENT MARKINGS	DMS-8240

All pavement marking materials shall meet the required Departmental Material Specifications as specified by the plans.

## NOTES:


- 1. Use stop bors with Stop Here For Pedestrians (R1-5b) signs at unsignalized midblock cross walks.
- 2. Use stop bars with STOP HERE ON RED (R10-6 or R10-6a) signs at mid block crosswalks controlled by traffic signals or pedestrian hybrid beacons.



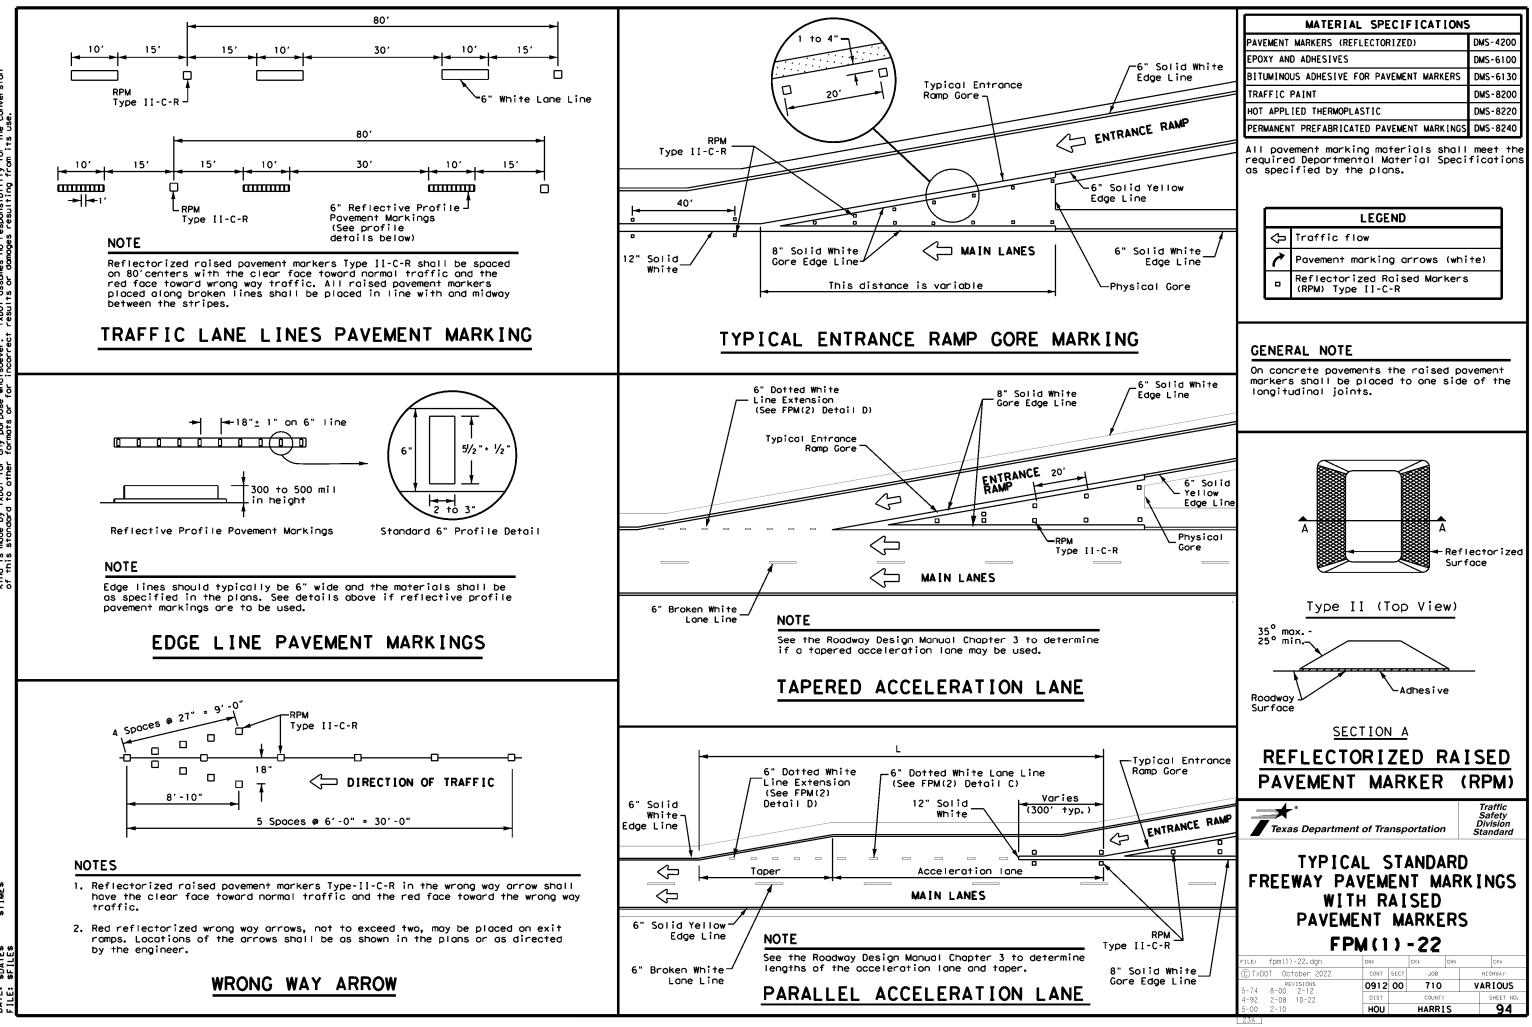

lexas Engineering Practice Act". No warranty of any TxDOT assumes no responsibility for the conversion t results or damages resulting from its use. governed by the rpose whatsoever SCLAIMER: The use of this standard nd is made by TxDOT for on this econdard to other for

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interchange from an adjacent mandatory exit lane.

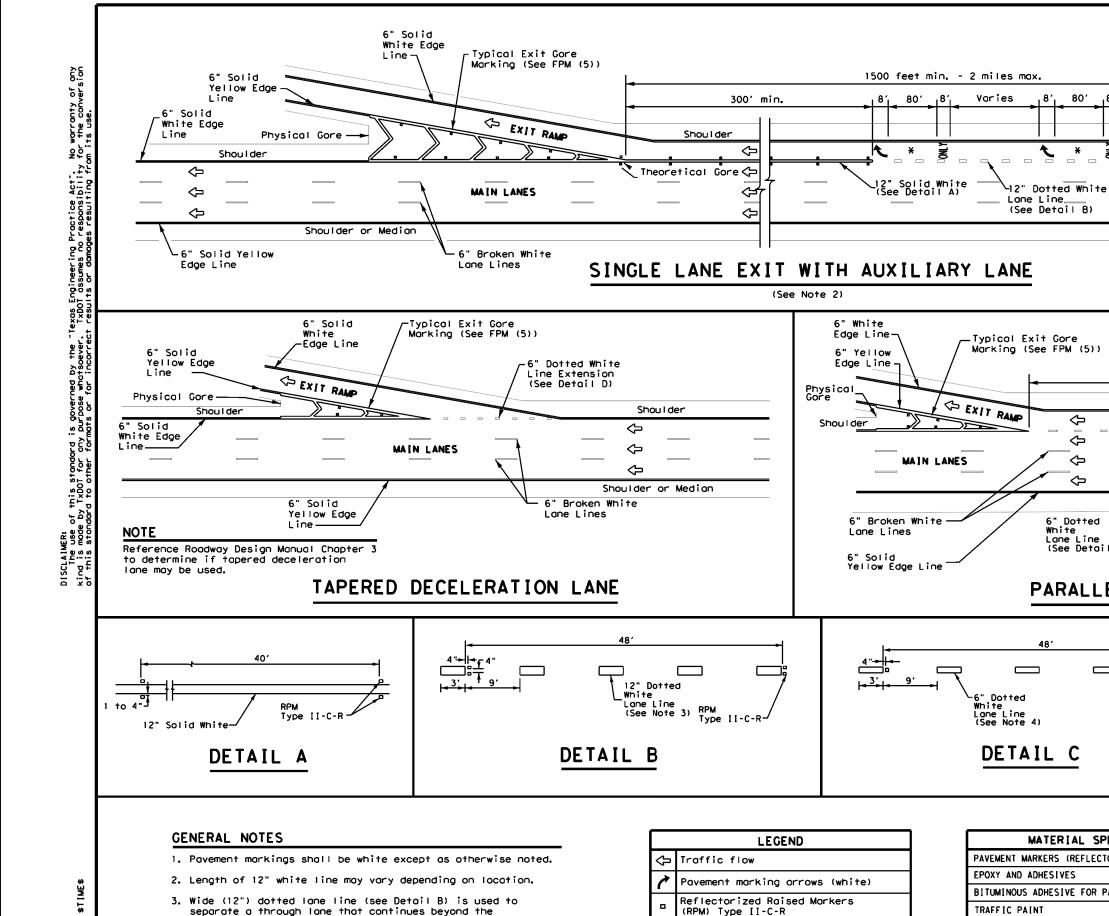parallel acceleration and deceleration lanes.

\$DA F 1

DATE:

4. Normal (6") dotted lane line (see Detail C) is used at

5. See FPM(1) for traffic lane line pavement marking details.

MATERIAL SPECIFICATIONS	
PAVEMENT MARKERS (REFLECTORIZED)	D
EPOXY AND ADHESIVES	D
BITUMINOUS ADHESIVE FOR PAVEMENT MARKERS	D
TRAFFIC PAINT	D
HOT APPLIED THERMOPLASTIC	D
PERMANENT PREFABRICATED PAVEMENT MARKINGS	D

80'

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6" Dotted White

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Arrow markings are optional, however "ONLY" is required if arrow is used

Lone Line (See Detail C)—

RPM_

Type II-C-R


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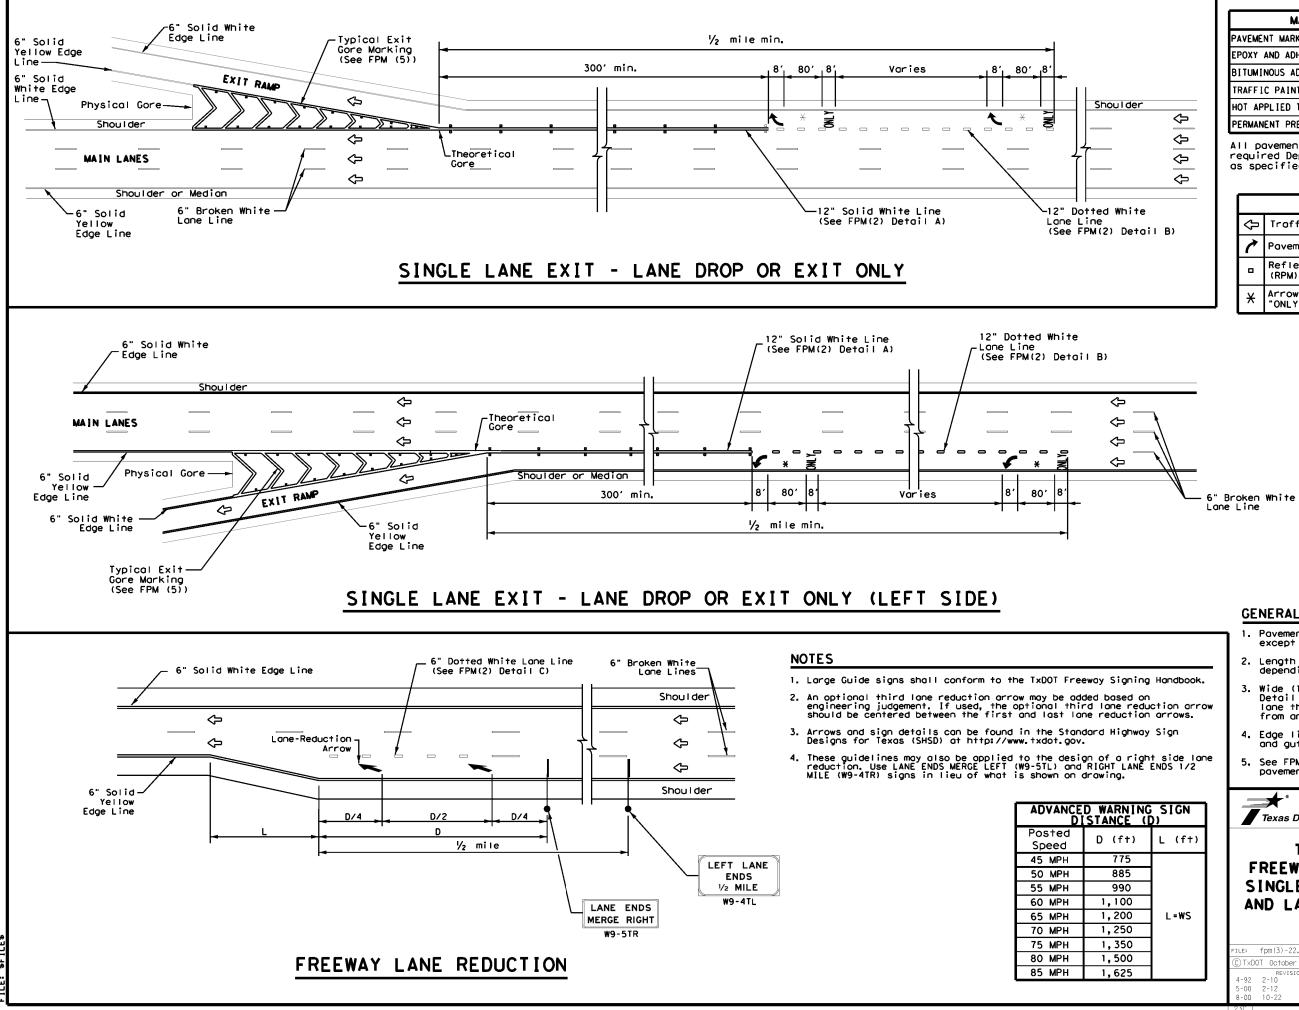
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All pavement marking materials shall meet the required Departmental Material Specifications as specified by the plans.





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MATERIAL SPECIFICATIONS				
PAVEMENT MARKERS (REFLECTORIZED)	DMS-4200			
EPOXY AND ADHESIVES	DMS-6100			
BITUMINOUS ADHESIVE FOR PAVEMENT MARKERS	DMS-6130			
TRAFFIC PAINT	DMS-8200			
HOT APPLIED THERMOPLASTIC	DMS-8220			
PERMANENT PREFABRICATED PAVEMENT MARKINGS	DMS-8240			

All pavement marking materials shall meet the required Departmental Material Specifications as specified by the plans.

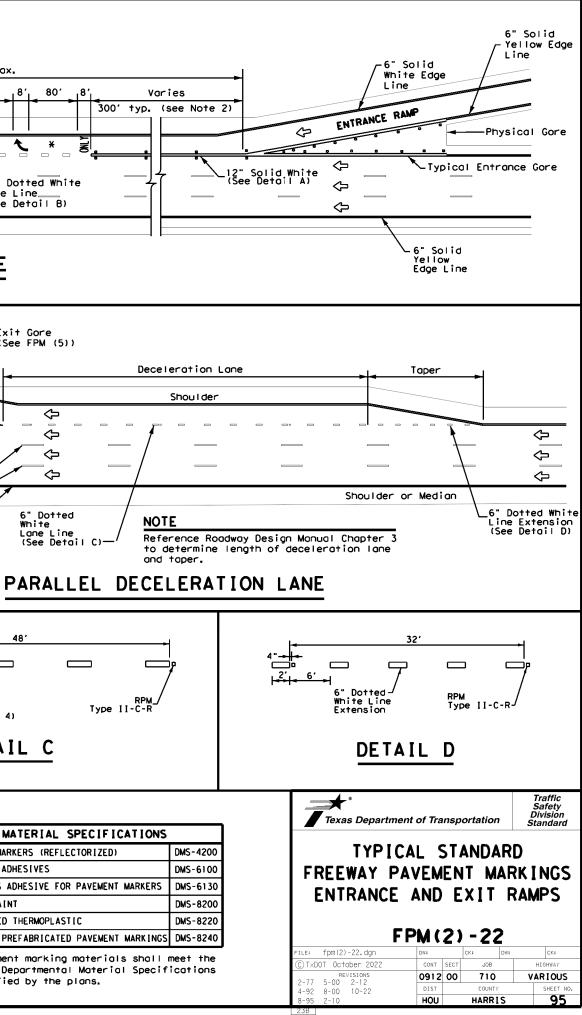
	LEGEND				
Ŷ	Traffic flow				
1	Pavement marking arrows (white)				
•	Reflectorized Raised Markers (RPM) Type II-C-R				
¥	Arrow markings are optional, however "ONLY" is required if arrow is used				

## GENERAL NOTES

- 1. Pavement markings shall be white except as otherwise noted.
- 2. Length of 12" white line may vary depending on location.
- Wide (12") dotted lane line (see FPM(2) Detail B) is used to separate a through lane that continues beyond the interchange from an adjacent mandatory exit lane.
- Edge lines are not required in curb and gutter sections of frontage roads.
- 5. See FPM(1) for traffic lane line pavement marking details.

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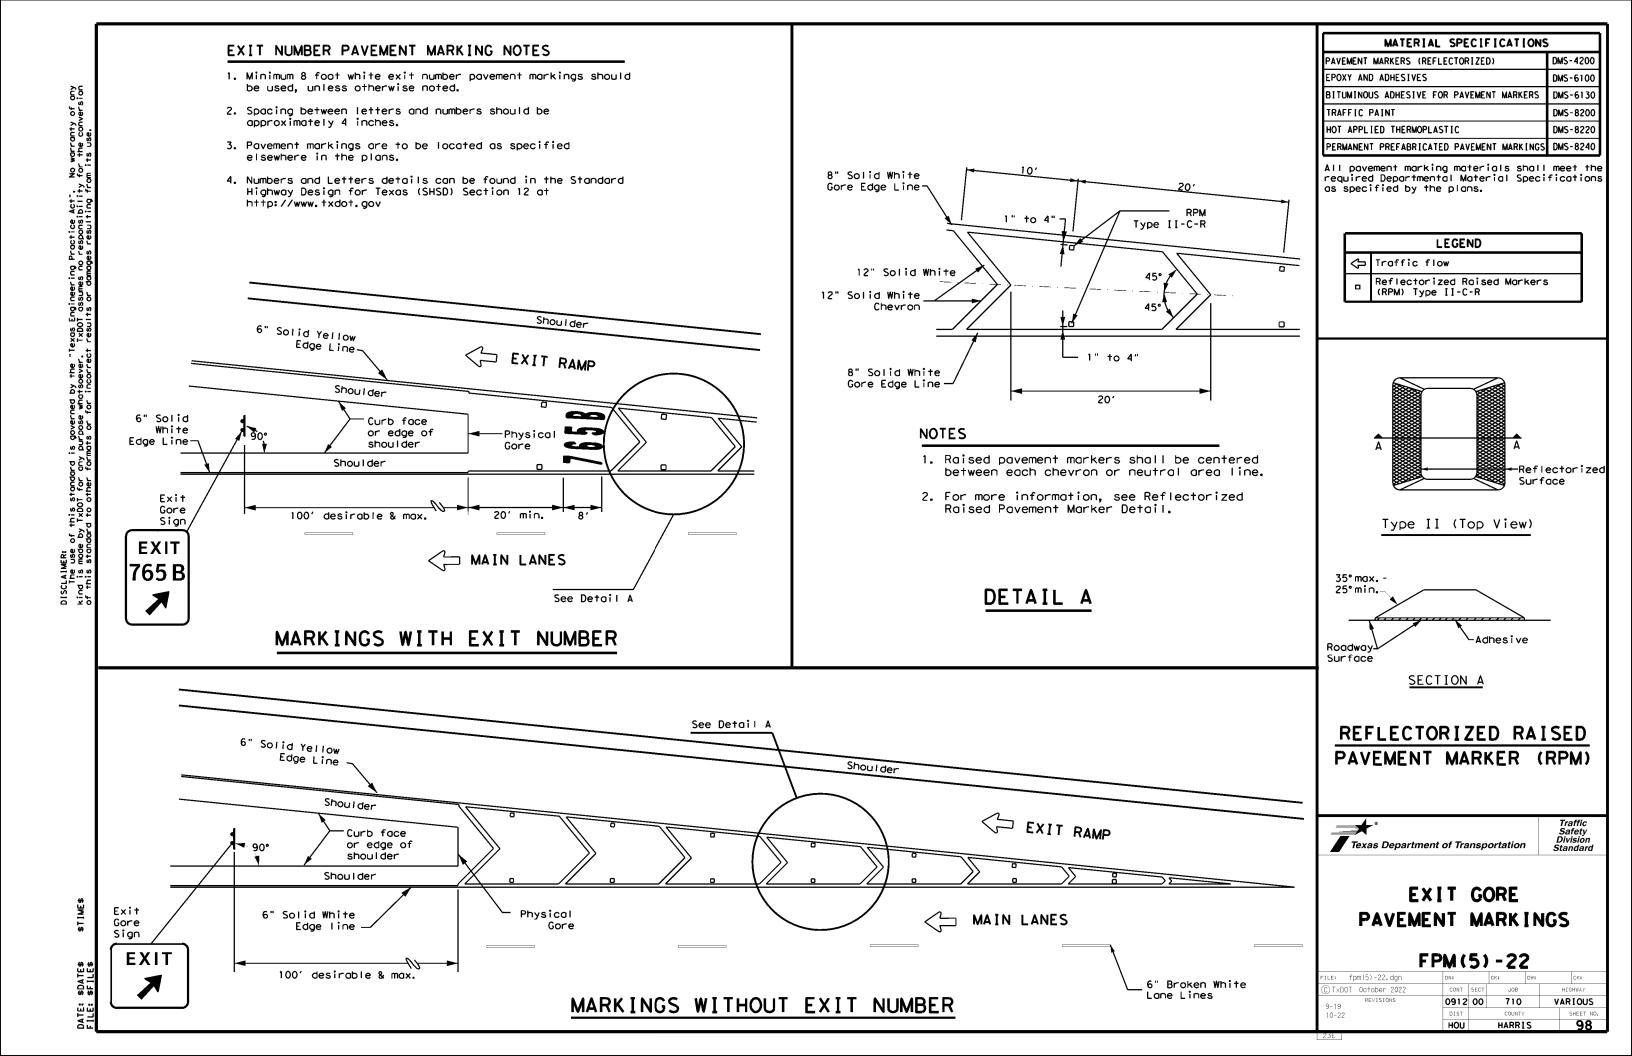
Texas Department	of Tra	nsp	ortatior	2	Traffic Safety Division Standard	
TYPICAL STANDARD FREEWAY PAVEMENT MARKINGS SINGLE LANE DROP(EXIT ONLY) AND LANE REDUCTION DETAILS FPM(3)-22						
ILE: fpm(3)-22.dgn	DN:		ск:	D₩:	CK;	
C)T×DOT October 2022	CONT	SECT	JOB		HIGHWAY	
REVISIONS 4-92 2-10	0912	00	710		VARIOUS	
5-00 2-12	DIST		COUNT	(	SHEET NO.	
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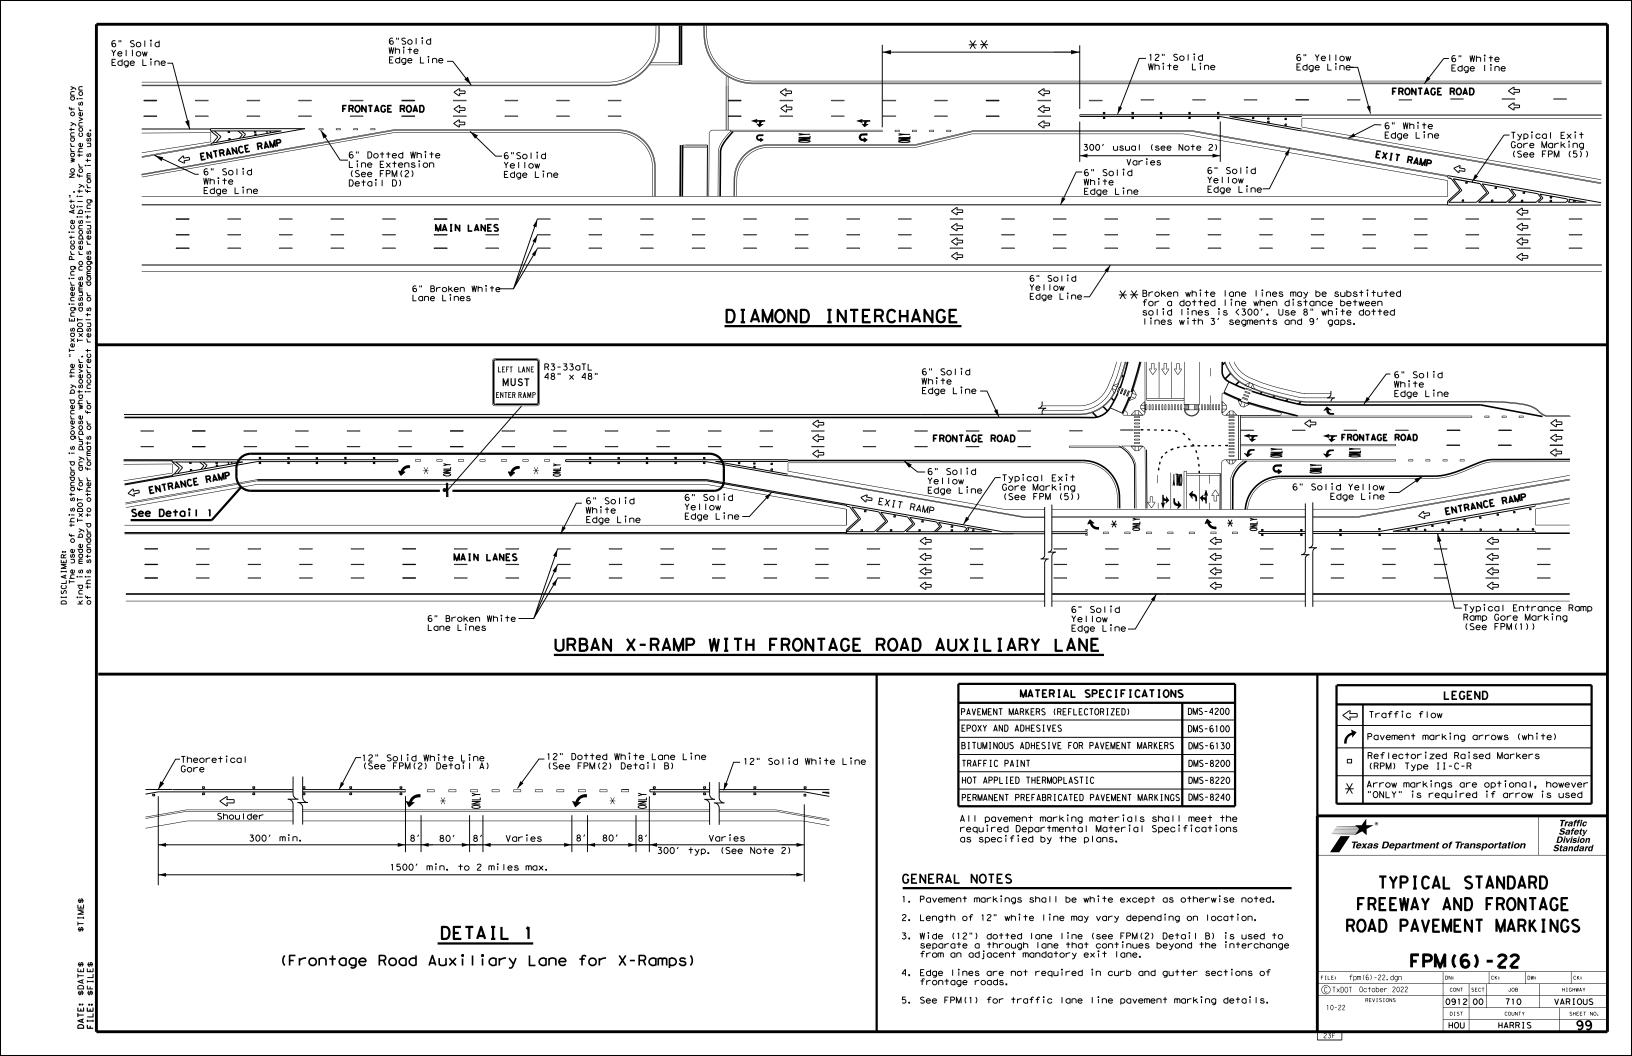



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arrow (white)
optional, however if arrow is used
re optional

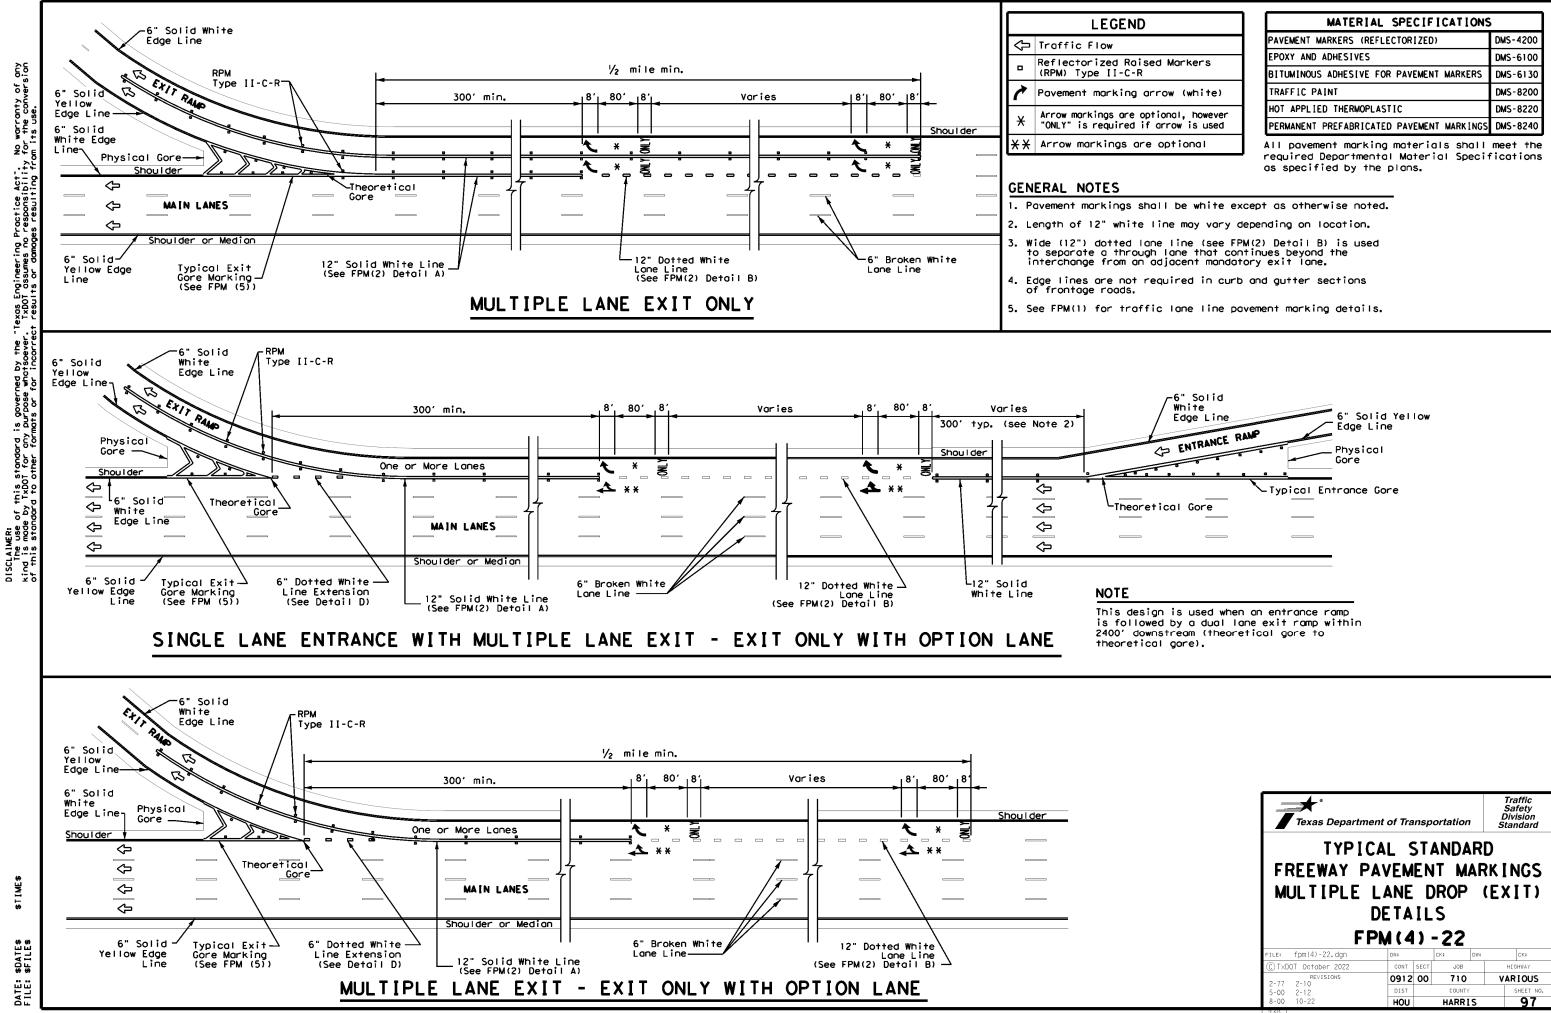MATERIAL SPECIFICATIONS		
PAVEMENT MARKERS (REFLECTORIZED)	DMS-4200	
EPOXY AND ADHESIVES	DMS-6100	
BITUMINOUS ADHESIVE FOR PAVEMENT MARKERS	DMS-6130	
TRAFFIC PAINT	DMS-8200	
HOT APPLIED THERMOPLASTIC	DMS-8220	
PERMANENT PREFABRICATED PAVEMENT MARKINGS	DMS-8240	
All pavement marking materials shall	meet the	






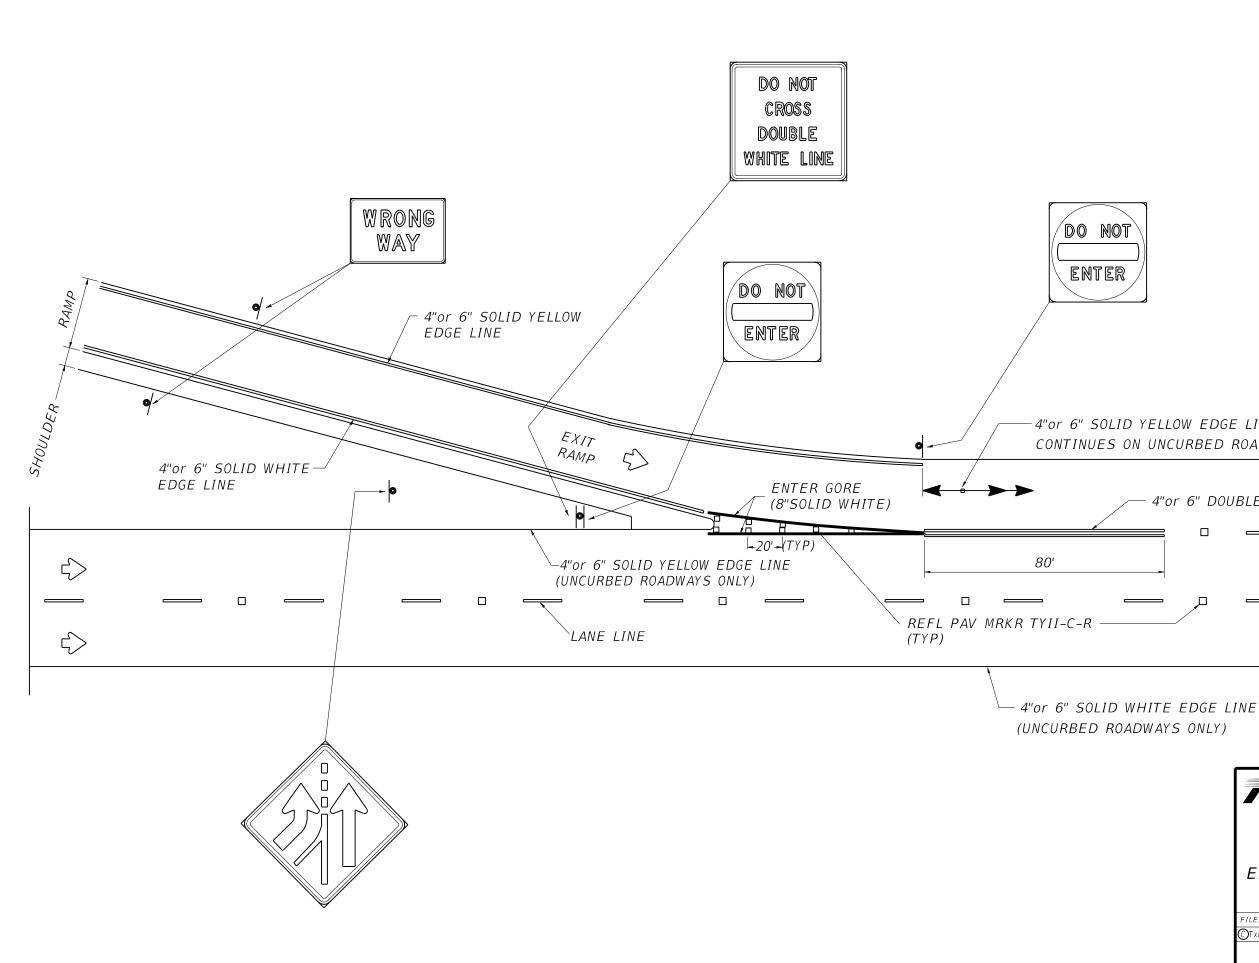


-4"or 6" SOLID YELLOW EDGE LINE CONTINUES ON UNCURBED ROADWAYS ONLY  $\leq$ 4"or 6" DOUBLE WHITE LINE П ONE WAY  $\leq$ FRONTAGE ROAD  $\leq$ 

Texas Department of Transportation Houston District				
SIGNING AND PAVEMENT MARKING DETAILS EXIT RAMPS-FRONTAGE ROAD ER-FR(1)-09				
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FEB., 2008 DEC., 2009	SHEET NO.			
HOU HARRIS <b>100</b>				

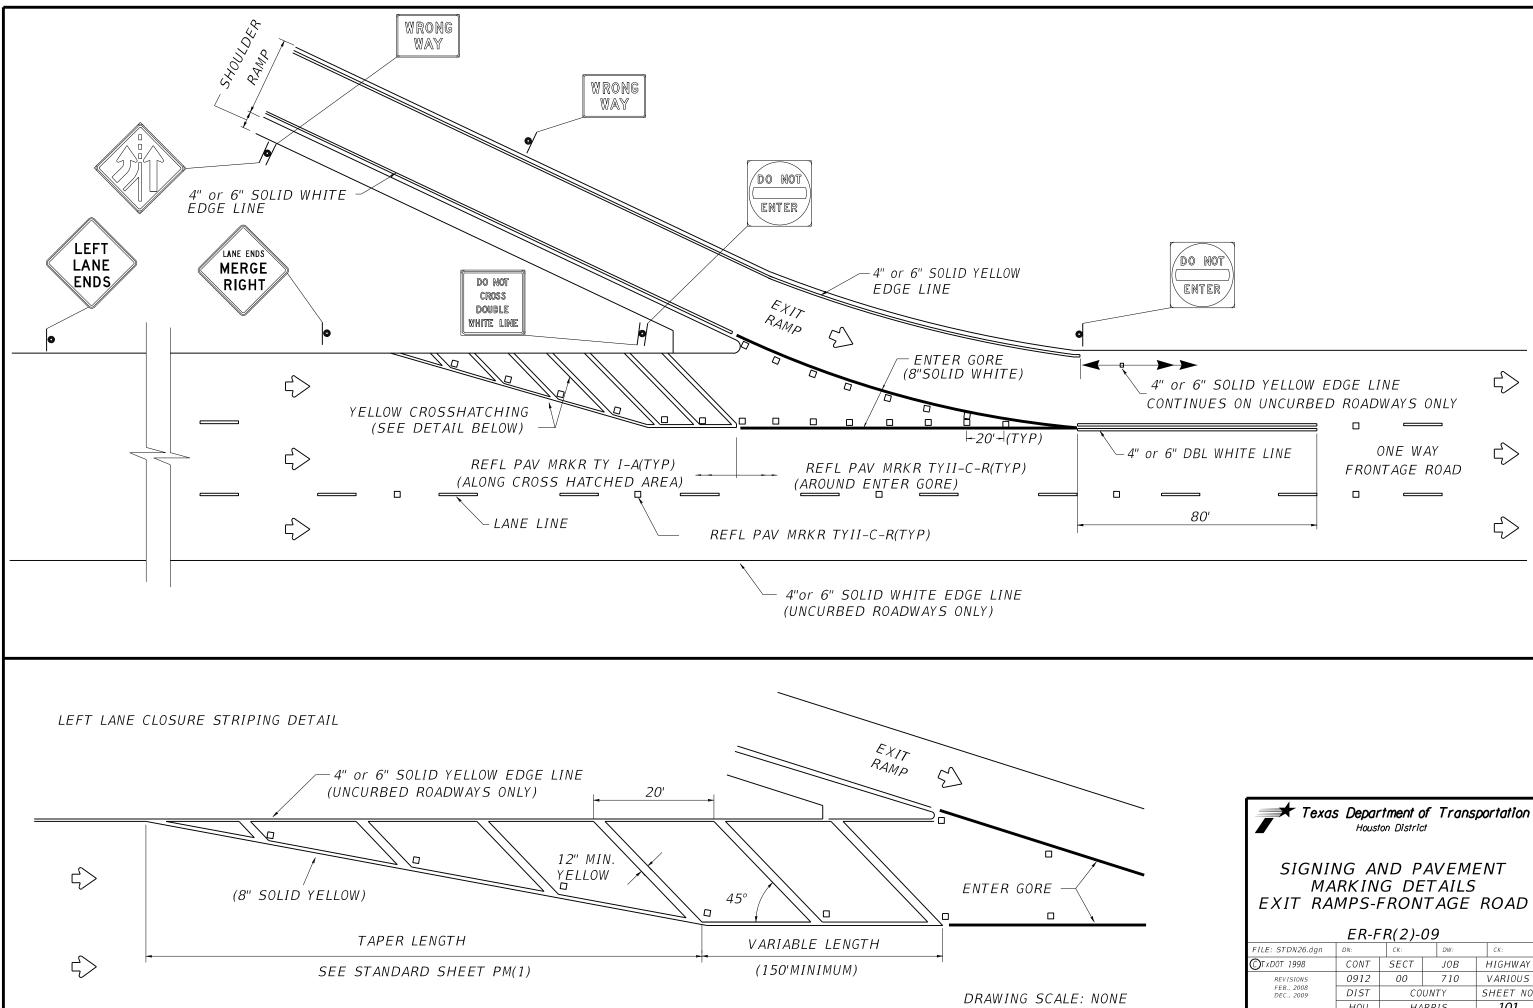


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	HOU	HARRIS		101

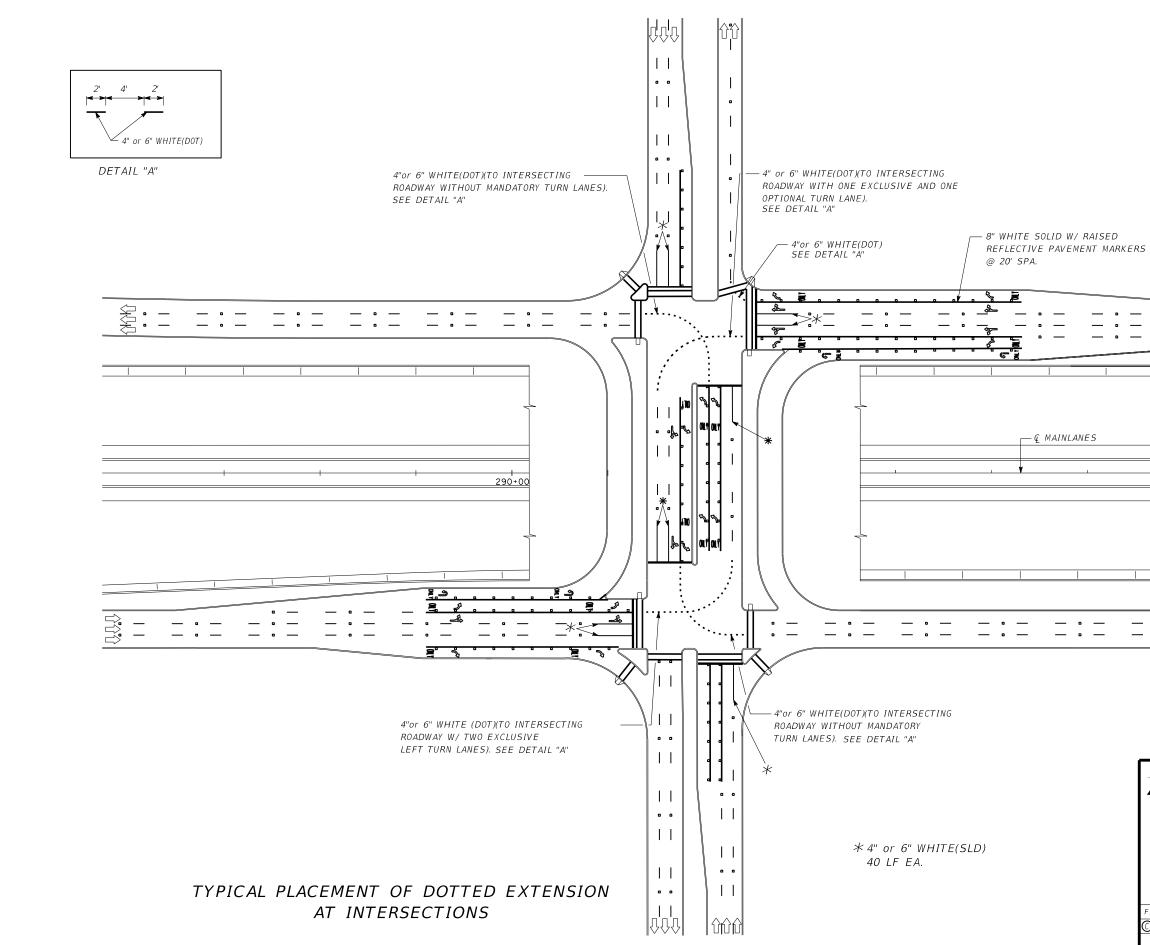

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Texas Department of Transportation Houston District				
PAVEMENT MARKINGS (DOTTED EXTENSION DETAILS) PM(DOT)-11				
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4/2010 4/2011				SHEET NO.
HOU HARRIS <b>102</b>				102

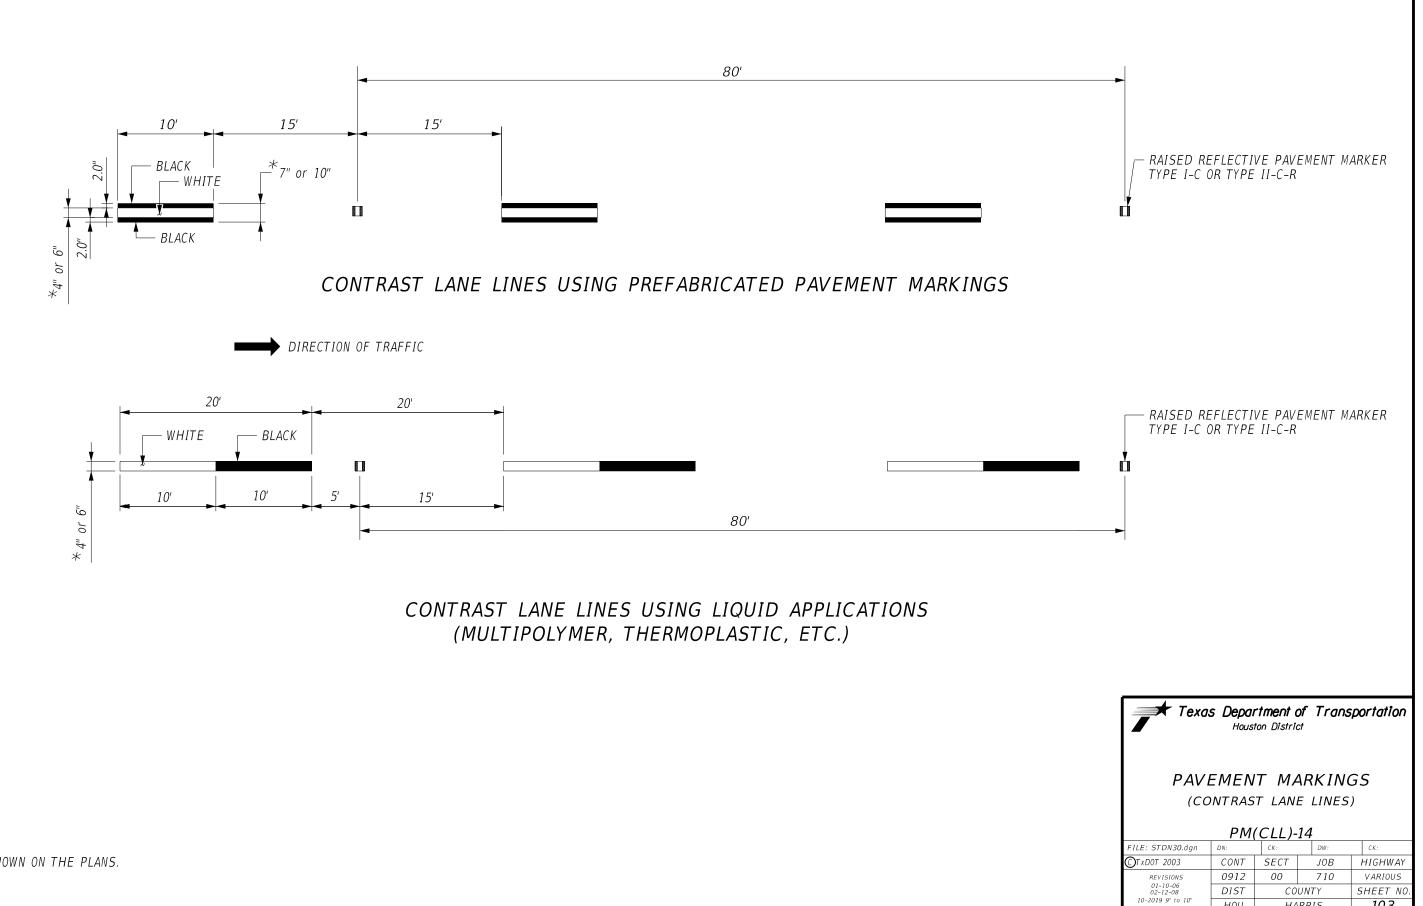

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HARRIS

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 $\star$  as shown on the plans.

□ This project is adjacent or parallel work, not within RR ROW: DOT No.: 022708X

Crossing Type: At-Grade

RR Company Operating Track at Crossing: BNSF Railway Company (BNSF)

RR Company Owning Track at Crossing: BNSF

RR MP: 76.557

RR Subdivision: GALVESTON

City: ____

County: Fort Bend

CSJ at this Crossing: 0912-00-710

Latitude: 29°36'15.35"N Longitude: 95°58'39.80"W

Scope of Work, including any TCP, to be performed by State Contractor:

1) Pavement Markings 2) TCP(3-1)-13

3) Railroad and Contractor flaggers will coordinate with lane closures in vicinity of railroad. 4) All lanes across railroad tracks are to be open to traffic at the end of the day.

Scope of Work to be performed by Railroad Company:

N/A

#### II. FLAGGING & INSPECTION

No. of Days of Railroad Flagging Expected: 1

On this project, night or weekend flagging is:

Expected

Not Expected

Flagging services will be provided by:

□ Railroad Company: 1) Txdot will pay flagging invoices. Flagging Agreement with railroad will be needed or, 2) Permitted crossing. Railroad company to provide flagging.

☑ Outside Party: Contractor will pay flagging invoices to be reimbursed by TxDOT

Contractor must incorporate flaggers into anticipated construction schedule. The Railroad requires a 30-day notice if their flaggers are to be utilized. If Contractor falls behind schedule due to their own negligence and is not ready for scheduled flaggers, any flagging charges will be paid by Contractor.

Contact Information for Flagging:

UP.info@railpros.com Call Center 877-315-0513, Select #1 for flagging UP.request@nrssinc.net Call Center 877-984-6777

- ✓ BNSF BNSFinfo@railprosfs.com Call Center 877-315-0513, Select #1 for flagging
- CPKCR KCS.info@railpros.com Call Center 877-315-0513, Select #1 for flagging Bottom Line On-Track Safety Services bottomline076@aol.com, 903-767-7630

OTHERS:

#### Contractor must incorporate railroad construction inspection into anticipated construction schedule.

☑ Not Required

□ Required. Contact Information for Construction Inspection:

#### III. CONSTRUCTION WORK TO BE PERFORMED BY THE RAILROAD

Required.
Regulieu.

☑ Not Required

Railroad Point of Contact:

Coordinate with TxDOT for any work to be performed by the Railroad Company. TxDOT must issue a work order for any work done by the Railroad Company prior to the work being performed.

#### IV. RAILROAD INSURANCE REQUIREMENTS

The Contractor shall confirm the insurance requirements with the Railroad as the insurance limits are subject to change without notice.

Insurance policies and corresponding certificates of insurance must be issued by the contractor on behalf of the Railroad. Separate insurance policies and certificates are required when more than one Railroad Company is operating on the same right of way, or when several Railroad Companies are involved and operate on their own separate right of ways.

No direct compensation will be made to the Contractor for providing the insurance coverages shown below or any deductibles. These costs are incidental to the various bid items.

	Escalated Limits
Type of Insurance	Amount of Coverage (Minimum)
Workers Compensation	\$500,000 / \$500,000 / \$500,000
Commercial General Liability	\$2,000,000 / \$4,000,000
Business Automobile	\$2,000,000

#### **Railroad Protective Liability Limits**

- Not Required
- \$2,000,000 / \$6,000,000 ☑ Non - Bridge/Typical Maintenance Projects. Includes repairs to overpass/underpass and culvert structures \$5,000,000 / \$10,000,000 □ Bridge Structure Projects. Includes new
- construction or replacement of overpass/ underpass structures

Other:

Initials:

# whatso ts use. its TXDOT 9 ard to by the **DISCLAIMER:** The use of this standard i TXDOT assumes no respoi

### V. CONTRACTOR'S RIGHT OF ENTRY (CROE)

☑ Not Required

- □ Required: UPRR Maintenance Consent Letter. TxDOT to assist
- □ Required: TxDOT to assist in obtaining the UPRR CROE
- □ Required: Contractor to obtain

#### BNSF:

- https://bnsf.railpermitting.com
- https://jllrpg.360works.com/fmi/webd/rpo_web_kcs.fmp12
- Other Railroads:

To view previously approved CROE templates agreed upon between the State and Railroad, see: https://www.txdot.gov/business/resources/railroad-highway-crossing/sample-right-of-entryagreements.html

Approved CROE templates are not to be modified by the Contractor.

Contractor shall not operate within Railroad Right of Way without an executed Construction & Maintenance Agreement between the State and the Railroad and an executed CROE between the Contractor and the Railroad if required on project.

### VI. RAILROAD COORDINATION MEETING

A Railroad Coordination Meeting is required. See item 5, Article 8.1, of the Standard Specifications for Construction and Maintenance of Highways, Streets and Bridges Manual for more details.

### VII. RAILROAD SAFETY ORIENTATION

A. Complete the Railroad's course "Orientation for Contractor's Safety," and maintain registration prior to working on the Railroad's property. This course is required to be completed annually by Contractor and Subcontractor personnel working on site.

UPRR, BNSF, CPKCR will not accept on-track safety training certificates from other Railroads. Refer to each Railroad's specific contractor right of entry for training information.


Know and follow the Contractor's Right of Entry Agreement EXHIBIT D, MINIMUM SAFETY REQUIREMENTS regarding clothing, personal protective equipment, and general safety requirements.

### **VIII. SUBCONTRACTORS**

Contractor shall not subcontract work without written consent of TxDOT. Subcontractors are subject to the same insurance requirements as the Prime Contractor

### IX. EMERGENCY NOTIFICATION

In Case of Railroad Emergency Call: BNSF
Railroad Emergency Line at: 800-832-5452 Location: DOT 0020708X
RR Milepost: 76.557 Subdivision: GALVESTON

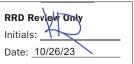

Texas Department of Transportation

Rail Division

FILE: rr-scope-of-work.pdf		dn: Tx	DOT	СК:	: DW:			ск:
© TxDOT	June 2014	CONT	CONT SECT JOB	JOB		HIGHWAY		
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6/2023		DIST	COUNTY			:	SHEET NO.	
		HOU		HARRIS	;			104

□ This project is adjacent or parallel work, not within RR ROW: DOT No.: 906645P

Crossing Type: At-Grade

RR Company Operating Track at Crossing: <u>Union Pacific Railroad Company (UP)</u>

RR Company Owning Track at Crossing: UPRR

RR MP: 11.895

RR Subdivision: Popp Ind Ld

City: Arcola

County: Fort Bend

CSJ at this Crossing: 0912-00-710

Latitude: 29°30'27.70"N

Longitude: 95°27'41.30"W

Scope of Work, including any TCP, to be performed by State Contractor:

1) Pavement Markings

2) TCP(3-4)-13 3) Railroad and Contractor flaggers will coordinate with lane closures in vicinity of railroad. 4) All lanes across railroad tracks are to be open to traffic at the end of the day.

Scope of Work to be performed by Railroad Company:

N/A

#### II. FLAGGING & INSPECTION

No. of Days of Railroad Flagging Expected: 1

On this project, night or weekend flagging is:

Expected

Not Expected

Flagging services will be provided by:

□ Railroad Company: 1) Txdot will pay flagging invoices. Flagging Agreement with railroad will be needed or, 2) Permitted crossing. Railroad company to provide flagging.

☑ Outside Party: Contractor will pay flagging invoices to be reimbursed by TxDOT

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Contact Information for Flagging:

☑ UPRR UP.info@railpros.com Call Center 877-315-0513, Select #1 for flagging UP.request@nrssinc.net Call Center 877-984-6777

- BNSF BNSFinfo@railprosfs.com Call Center 877-315-0513, Select #1 for flagging
- CPKCR KCS.info@railpros.com Call Center 877-315-0513, Select #1 for flagging Bottom Line On-Track Safety Services bottomline076@aol.com, 903-767-7630

OTHERS:

#### Contractor must incorporate railroad construction inspection into anticipated construction schedule.

☑ Not Required

□ Required. Contact Information for Construction Inspection:

#### III. CONSTRUCTION WORK TO BE PERFORMED BY THE RAILROAD

Required.
Required.

☑ Not Required

Railroad Point of Contact:

Coordinate with TxDOT for any work to be performed by the Railroad Company. TxDOT must issue a work order for any work done by the Railroad Company prior to the work being performed.

#### IV. RAILROAD INSURANCE REQUIREMENTS

The Contractor shall confirm the insurance requirements with the Railroad as the insurance limits are subject to change without notice.

Insurance policies and corresponding certificates of insurance must be issued by the contractor on behalf of the Railroad. Separate insurance policies and certificates are required when more than one Railroad Company is operating on the same right of way, or when several Railroad Companies are involved and operate on their own separate right of ways.

No direct compensation will be made to the Contractor for providing the insurance coverages shown below or any deductibles. These costs are incidental to the various bid items.

I	Escalated Limits
Type of Insurance	Amount of Coverage (Minimum)
Workers Compensation	\$500,000 / \$500,000 / \$500,000
Commercial General Liability	\$2,000,000 / \$4,000,000
Business Automobile	\$2,000,000

#### **Railroad Protective Liability Limits**

- Not Required
- \$2,000,000 / \$6,000,000 ☑ Non - Bridge/Typical Maintenance Projects. Includes repairs to overpass/underpass and culvert structures \$5,000,000 / \$10,000,000 □ Bridge Structure Projects. Includes new
- construction or replacement of overpass/ underpass structures

Other:

□ Not Required

BNSF:

To view previously approved CROE templates agreed upon between the State and Railroad, see: https://www.txdot.gov/business/resources/railroad-highway-crossing/sample-right-of-entryagreements.html

Approved CROE templates are not to be modified by the Contractor.

Contractor shall not operate within Railroad Right of Way without an executed Construction & Maintenance Agreement between the State and the Railroad and an executed CROE between the Contractor and the Railroad if required on project.

### VII. RAILROAD SAFETY ORIENTATION

Know and follow the Contractor's Right of Entry Agreement EXHIBIT D, MINIMUM SAFETY REQUIREMENTS regarding clothing, personal protective equipment, and general safety requirements.

## In Case of R

Call: UPRR Railroad Em Location: DO

> **RR** Milepost Subdivision:

natsc use.

its

be of Insurance	Amount of Coverage (Mini				
orkers Compensation	\$500,000 / \$500,000 / \$5				
mmercial General Liability	\$2,000,000 / \$4,000,00				
siness Automobile	\$2,000,000				

### V. CONTRACTOR'S RIGHT OF ENTRY (CROE)

- ☑ Required: UPRR Maintenance Consent Letter. TxDOT to assist
- □ Required: TxDOT to assist in obtaining the UPRR CROE
- □ Required: Contractor to obtain

- https://bnsf.railpermitting.com
- https://jllrpg.360works.com/fmi/webd/rpo_web_kcs.fmp12
- Other Railroads:

### VI. RAILROAD COORDINATION MEETING

A Railroad Coordination Meeting is required. See item 5, Article 8.1, of the Standard Specifications for Construction and Maintenance of Highways, Streets and Bridges Manual for more details.

A. Complete the Railroad's course "Orientation for Contractor's Safety," and maintain registration prior to working on the Railroad's property. This course is required to be completed annually by Contractor and Subcontractor personnel working on site.


UPRR, BNSF, CPKCR will not accept on-track safety training certificates from other Railroads. Refer to each Railroad's specific contractor right of entry for training information.

### **VIII. SUBCONTRACTORS**

Contractor shall not subcontract work without written consent of TxDOT. Subcontractors are subject to the same insurance requirements as the Prime Contractor

### IX. EMERGENCY NOTIFICATION

Railroad Emergency
ergency Line at: 800-848-8715
OT DOT 906645P
Popp Ind Ld

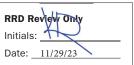

Texas Department of Transportation

Rail Division

FILE: rr-scope-of-work.pdf		dn: Tx	DOT	СК:	CK: DW:			ск:
© TxDOT	June 2014	CONT	SECT	JOB			HIG	HWAY
0/0000	REVISIONS	0912	00	710		VARIOUS		IOUS
6/2023		DIST	COUNTY			:	SHEET NO.	
		HOU		HARRIS	;			105

□ This project is adjacent or parallel work, not within RR ROW: DOT No.: 921033F

Crossing Type: At-Grade

RR Company Operating Track at Crossing: <u>Union Pacific Railroad Company (UP)</u>

RR Company Owning Track at Crossing: UPRR

RR MP: 11.930

RR Subdivision: Popp Ind Ld

City: Arcola

County: Fort Bend

CSJ at this Crossing: 0912-00-710

Latitude: 29°30'26.20"N

Longitude: 95°27'41.90"W

Scope of Work, including any TCP, to be performed by State Contractor:

1) Pavement Markings

2) TCP(3-4)-13

3) Railroad and Contractor flaggers will coordinate with lane closures in vicinity of railroad. 4) All lanes across railroad tracks are to be open to traffic at the end of the day.

Scope of Work to be performed by Railroad Company:

N/A

#### II. FLAGGING & INSPECTION

No. of Days of Railroad Flagging Expected: 1

On this project, night or weekend flagging is:

Expected

Not Expected

Flagging services will be provided by:

□ Railroad Company: 1) Txdot will pay flagging invoices. Flagging Agreement with railroad will be needed or, 2) Permitted crossing. Railroad company to provide flagging.

☑ Outside Party: Contractor will pay flagging invoices to be reimbursed by TxDOT

Contractor must incorporate flaggers into anticipated construction schedule. The Railroad requires a 30-day notice if their flaggers are to be utilized. If Contractor falls behind schedule due to their own negligence and is not ready for scheduled flaggers, any flagging charges will be paid by Contractor.

Contact Information for Flagging:

☑ UPRR UP.info@railpros.com Call Center 877-315-0513, Select #1 for flagging UP.request@nrssinc.net Call Center 877-984-6777

- BNSF BNSFinfo@railprosfs.com Call Center 877-315-0513, Select #1 for flagging
- CPKCR KCS.info@railpros.com Call Center 877-315-0513, Select #1 for flagging Bottom Line On-Track Safety Services bottomline076@aol.com, 903-767-7630

OTHERS:

#### Contractor must incorporate railroad construction inspection into anticipated construction schedule.

☑ Not Required

□ Required. Contact Information for Construction Inspection:

#### III. CONSTRUCTION WORK TO BE PERFORMED BY THE RAILROAD

Required.	
Required.	

☑ Not Required

Railroad Point of Contact:

Coordinate with TxDOT for any work to be performed by the Railroad Company. TxDOT must issue a work order for any work done by the Railroad Company prior to the work being performed.

#### IV. RAILROAD INSURANCE REQUIREMENTS

The Contractor shall confirm the insurance requirements with the Railroad as the insurance limits are subject to change without notice.

Insurance policies and corresponding certificates of insurance must be issued by the contractor on behalf of the Railroad. Separate insurance policies and certificates are required when more than one Railroad Company is operating on the same right of way, or when several Railroad Companies are involved and operate on their own separate right of ways.

No direct compensation will be made to the Contractor for providing the insurance coverages shown below or any deductibles. These costs are incidental to the various bid items.

	Escalated Limits
Type of Insurance	Amount of Coverage (Minimum)
Workers Compensation	\$500,000 / \$500,000 / \$500,000
Commercial General Liability	\$2,000,000 / \$4,000,000
Business Automobile	\$2,000,000

#### **Railroad Protective Liability Limits**

- Not Required
- \$2,000,000 / \$6,000,000 ☑ Non - Bridge/Typical Maintenance Projects. Includes repairs to overpass/underpass and culvert structures \$5,000,000 / \$10,000,000
- □ Bridge Structure Projects. Includes new construction or replacement of overpass/ underpass structures

Other:

Initials:

BNSF:

To view previously approved CROE templates agreed upon between the State and Railroad, see: https://www.txdot.gov/business/resources/railroad-highway-crossing/sample-right-of-entryagreements.html

Approved CROE templates are not to be modified by the Contractor.

Contractor shall not operate within Railroad Right of Way without an executed Construction & Maintenance Agreement between the State and the Railroad and an executed CROE between the Contractor and the Railroad if required on project.

### VII. RAILROAD SAFETY ORIENTATION

UPRR, BNSF, CPKCR will not accept on-track safety training certificates from other Railroads. Refer to each Railroad's specific contractor right of entry for training information.

Know and follow the Contractor's Right of Entry Agreement EXHIBIT D, MINIMUM SAFETY REQUIREMENTS regarding clothing, personal protective equipment, and general safety requirements.

# **VIII. SUBCONTRACTORS**

In Case of R Call: UPRR Railroad Em

**RR** Milepost

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### TRACTOR'S RIGHT OF ENTRY (CROE)

Not Required

- ☑ Required: UPRR Maintenance Consent Letter. TxDOT to assist
- □ Required: TxDOT to assist in obtaining the UPRR CROE
- □ Required: Contractor to obtain

- https://bnsf.railpermitting.com
- https://jllrpg.360works.com/fmi/webd/rpo_web_kcs.fmp12
- Other Railroads:

### VI. RAILROAD COORDINATION MEETING


A Railroad Coordination Meeting is required. See item 5, Article 8.1, of the Standard Specifications for Construction and Maintenance of Highways, Streets and Bridges Manual for more details.

A. Complete the Railroad's course "Orientation for Contractor's Safety," and maintain registration prior to working on the Railroad's property. This course is required to be completed annually by Contractor and Subcontractor personnel working on site.

Contractor shall not subcontract work without written consent of TxDOT. Subcontractors are subject to the same insurance requirements as the Prime Contractor

### IX. EMERGENCY NOTIFICATION

In Case of Railroad Emergency Call: UPRR
Railroad Emergency Line at: 800-848-8715 Location: DOT DOT 921033F
RR Milepost: 11.930 Subdivision: Popp Ind Ld

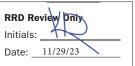

Texas Department of Transportation

Rail Division

FILE: rr-scop	e-of-work.pdf	dn: Tx	DOT	СК:	DW:			ск:
© TxDOT	June 2014	CONT	SECT	JOB			HIG	HWAY
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6/2023		DIST		COUNTY			:	SHEET NO.
		HOU		HARRIS	;			106

□ This project is adjacent or parallel work, not within RR ROW: DOT No.: 921035U

Crossing Type: Overpass

RR Company Operating Track at Crossing: <u>Union Pacific Railroad Company (UP)</u>

RR Company Owning Track at Crossing: UPRR

RR MP: 11.911

RR Subdivision: Popp Ind Ld

City: Arcola

County: Fort Bend

CSJ at this Crossing: 0912-00-710

Latitude: 29°30'27.20"N

Longitude: 95°27'41.50"W

Scope of Work, including any TCP, to be performed by State Contractor:

1) Pavement Markings

2) TCP(3-2)-13 3) Railroad and Contractor flaggers will coordinate with lane closures in vicinity of railroad. 4) All lanes across railroad tracks are to be open to traffic at the end of the day.

Scope of Work to be performed by Railroad Company:

N/A

#### II. FLAGGING & INSPECTION

No. of Days of Railroad Flagging Expected: 1

On this project, night or weekend flagging is:

Expected

Not Expected

Flagging services will be provided by:

□ Railroad Company: 1) Txdot will pay flagging invoices. Flagging Agreement with railroad will be needed or, 2) Permitted crossing. Railroad company to provide flagging.

☑ Outside Party: Contractor will pay flagging invoices to be reimbursed by TxDOT

Contractor must incorporate flaggers into anticipated construction schedule. The Railroad requires a 30-day notice if their flaggers are to be utilized. If Contractor falls behind schedule due to their own negligence and is not ready for scheduled flaggers, any flagging charges will be paid by Contractor.

Contact Information for Flagging:

☑ UPRR UP.info@railpros.com Call Center 877-315-0513, Select #1 for flagging UP.request@nrssinc.net Call Center 877-984-6777

- BNSF BNSFinfo@railprosfs.com Call Center 877-315-0513, Select #1 for flagging
- CPKCR KCS.info@railpros.com Call Center 877-315-0513, Select #1 for flagging Bottom Line On-Track Safety Services bottomline076@aol.com, 903-767-7630

OTHERS:

#### Contractor must incorporate railroad construction inspection into anticipated construction schedule.

☑ Not Required

□ Required. Contact Information for Construction Inspection:

#### III. CONSTRUCTION WORK TO BE PERFORMED BY THE RAILROAD

Required.	
Required.	

☑ Not Required

Railroad Point of Contact:

Coordinate with TxDOT for any work to be performed by the Railroad Company. TxDOT must issue a work order for any work done by the Railroad Company prior to the work being performed.

#### IV. RAILROAD INSURANCE REQUIREMENTS

The Contractor shall confirm the insurance requirements with the Railroad as the insurance limits are subject to change without notice.

Insurance policies and corresponding certificates of insurance must be issued by the contractor on behalf of the Railroad. Separate insurance policies and certificates are required when more than one Railroad Company is operating on the same right of way, or when several Railroad Companies are involved and operate on their own separate right of ways.

No direct compensation will be made to the Contractor for providing the insurance coverages shown below or any deductibles. These costs are incidental to the various bid items.

	Escalated Limits
Type of Insurance	Amount of Coverage (Minimum)
Workers Compensation	\$500,000 / \$500,000 / \$500,000
Commercial General Liability	\$2,000,000 / \$4,000,000
Business Automobile	\$2,000,000

- Not Required
- \$2,000,000 / \$6,000,000 ☑ Non - Bridge/Typical Maintenance Projects. Includes repairs to overpass/underpass and culvert structures \$5,000,000 / \$10,000,000
- construction or replacement of overpass/ underpass structures

Initials:

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□ Not Required

BNSF:

To view previously approved CROE templates agreed upon between the State and Railroad, see: https://www.txdot.gov/business/resources/railroad-highway-crossing/sample-right-of-entryagreements.html

Approved CROE templates are not to be modified by the Contractor.

Contractor shall not operate within Railroad Right of Way without an executed Construction & Maintenance Agreement between the State and the Railroad and an executed CROE between the Contractor and the Railroad if required on project.

### VII. RAILROAD SAFETY ORIENTATION

UPRR, BNSF, CPKCR will not accept on-track safety training certificates from other Railroads. Refer to each Railroad's specific contractor right of entry for training information.

Know and follow the Contractor's Right of Entry Agreement EXHIBIT D, MINIMUM SAFETY REQUIREMENTS regarding clothing, personal protective equipment, and general safety requirements.

**VIII. SUBCONTRACTORS** 

In Case of R

Call: UPRR Railroad Em

Location: DO **RR** Milepost

Subdivision:

**Railroad Protective Liability Limits** 

□ Bridge Structure Projects. Includes new

Other:

### V. CONTRACTOR'S RIGHT OF ENTRY (CROE)

- ☑ Required: UPRR Maintenance Consent Letter. TxDOT to assist
- □ Required: TxDOT to assist in obtaining the UPRR CROE
- □ Required: Contractor to obtain

- https://bnsf.railpermitting.com
- https://jllrpg.360works.com/fmi/webd/rpo_web_kcs.fmp12
- Other Railroads:

### VI. RAILROAD COORDINATION MEETING


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A. Complete the Railroad's course "Orientation for Contractor's Safety," and maintain registration prior to working on the Railroad's property. This course is required to be completed annually by Contractor and Subcontractor personnel working on site.

Contractor shall not subcontract work without written consent of TxDOT. Subcontractors are subject to the same insurance requirements as the Prime Contractor

### IX. EMERGENCY NOTIFICATION

Railroad Emergency
ergency Line at: 800-848-8715
DOT 921035U
: 11.911
Popp Ind Ld

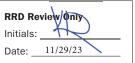

Texas Department of Transportation

Rail Division

FILE: rr-scop	e-of-work.pdf	dn: Tx	DOT	СК:	DW:			CK:
© TxDOT	June 2014	CONT	SECT	JOB			HIGI	HWAY
6/2023	REVISIONS	0912	00	710		٧	'AR	IOUS
6/2023		DIST		COUNTY			5	SHEET NO.
		HOU		HARRIS				107

□ This project is adjacent or parallel work, not within RR ROW: DOT No.: 922512N

Crossing Type: At-Grade

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RR Company Operating Track at Crossing: <u>Union Pacific Railroad Company (UP)</u>

RR Company Owning Track at Crossing: UPRR

RR MP: 25.490

RR Subdivision: Glidden

City: Sugar Land

County: Fort Bend

CSJ at this Crossing: 0912-00-710

Latitude: 29°36'50.80"N Longitude: 95°38'56.70"W

Scope of Work, including any TCP, to be performed by State Contractor:

1) Pavement Markings

2) TCP(3-4)-13 3) Railroad and Contractor flaggers will coordinate with lane closures in vicinity of railroad. 4) All lanes across railroad tracks are to be open to traffic at the end of the day.

Scope of Work to be performed by Railroad Company:

N/A

#### II. FLAGGING & INSPECTION

No. of Days of Railroad Flagging Expected: 1

On this project, night or weekend flagging is:

Expected

Not Expected

Flagging services will be provided by:

□ Railroad Company: 1) Txdot will pay flagging invoices. Flagging Agreement with railroad will be needed or, 2) Permitted crossing. Railroad company to provide flagging.

☑ Outside Party: Contractor will pay flagging invoices to be reimbursed by TxDOT

Contractor must incorporate flaggers into anticipated construction schedule. The Railroad requires a 30-day notice if their flaggers are to be utilized. If Contractor falls behind schedule due to their own negligence and is not ready for scheduled flaggers, any flagging charges will be paid by Contractor.

Contact Information for Flagging:

☑ UPRR UP.info@railpros.com Call Center 877-315-0513, Select #1 for flagging UP.request@nrssinc.net Call Center 877-984-6777

- BNSF BNSFinfo@railprosfs.com Call Center 877-315-0513, Select #1 for flagging
- CPKCR KCS.info@railpros.com Call Center 877-315-0513, Select #1 for flagging Bottom Line On-Track Safety Services bottomline076@aol.com, 903-767-7630

OTHERS:

#### Contractor must incorporate railroad construction inspection into anticipated construction schedule.

☑ Not Required

□ Required. Contact Information for Construction Inspection:

#### III. CONSTRUCTION WORK TO BE PERFORMED BY THE RAILROAD

Required.	
neguneu.	

☑ Not Required

Railroad Point of Contact:

Coordinate with TxDOT for any work to be performed by the Railroad Company. TxDOT must issue a work order for any work done by the Railroad Company prior to the work being performed.

#### IV. RAILROAD INSURANCE REQUIREMENTS

The Contractor shall confirm the insurance requirements with the Railroad as the insurance limits are subject to change without notice.

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	Escalated Limits
Type of Insurance	Amount of Coverage (Minimum)
Workers Compensation	\$500,000 / \$500,000 / \$500,000
Commercial General Liability	\$2,000,000 / \$4,000,000
Business Automobile	\$2,000,000

#### **Railroad Protective Liability Limits**

- Not Required
- \$2,000,000 / \$6,000,000 ☑ Non - Bridge/Typical Maintenance Projects. Includes repairs to overpass/underpass and culvert structures \$5,000,000 / \$10,000,000 □ Bridge Structure Projects. Includes new
- construction or replacement of overpass/ underpass structures

Other:

□ Not Required

BNSF:

To view previously approved CROE templates agreed upon between the State and Railroad, see: https://www.txdot.gov/business/resources/railroad-highway-crossing/sample-right-of-entryagreements.html

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Know and follow the Contractor's Right of Entry Agreement EXHIBIT D, MINIMUM SAFETY REQUIREMENTS regarding clothing, personal protective equipment, and general safety requirements.

## In Case of R

Call: UPRR Railroad Em Location: DO

> **RR** Milepost Subdivision:

> > Initials:

### V. CONTRACTOR'S RIGHT OF ENTRY (CROE)

- ☑ Required: UPRR Maintenance Consent Letter. TxDOT to assist
- □ Required: TxDOT to assist in obtaining the UPRR CROE
- □ Required: Contractor to obtain

- https://bnsf.railpermitting.com
- https://jllrpg.360works.com/fmi/webd/rpo_web_kcs.fmp12
- Other Railroads:

### VI. RAILROAD COORDINATION MEETING

A Railroad Coordination Meeting is required. See item 5, Article 8.1, of the Standard Specifications for Construction and Maintenance of Highways, Streets and Bridges Manual for more details.

### VII. RAILROAD SAFETY ORIENTATION

A. Complete the Railroad's course "Orientation for Contractor's Safety," and maintain registration prior to working on the Railroad's property. This course is required to be completed annually by Contractor and Subcontractor personnel working on site.


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### **VIII. SUBCONTRACTORS**

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### IX. EMERGENCY NOTIFICATION

ailroad Emergency
ergency Line at: 800-848-8715
DT DOT 922512N
25.490
Glidden



Texas Department of Transportation

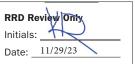Rail Division

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© TxDOT	June 2014	CONT	SECT	JOB			HIGHWAY	
0/0000	REVISIONS	0912	00	710		V	ARIOUS	6
6/2023		DIST		COUNTY			SHEET	NO.
		HOU		HARRIS			10	8

□ This project is adjacent or parallel work, not within RR ROW: DOT No.: 441027B

Crossing Type: At-Grade

RR Company Operating Track at Crossing: <u>Union Pacific Railroad Company (UP)</u>

RR Company Owning Track at Crossing: UPRR

RR MP: 25.150

RR Subdivision: Glidden

City: Sugar Land

County: Fort Bend

CSJ at this Crossing: 0912-00-710

Latitude: 29°36'59.70"N Longitude: 95°38'38.80"W

Scope of Work, including any TCP, to be performed by State Contractor:

1) Pavement Markings

2) TCP(3-4)-13 3) Railroad and Contractor flaggers will coordinate with lane closures in vicinity of railroad. 4) All lanes across railroad tracks are to be open to traffic at the end of the day.

Scope of Work to be performed by Railroad Company:

N/A

#### II. FLAGGING & INSPECTION

No. of Days of Railroad Flagging Expected: 1

On this project, night or weekend flagging is:

Expected

Not Expected

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□ Railroad Company: 1) Txdot will pay flagging invoices. Flagging Agreement with railroad will be needed or, 2) Permitted crossing. Railroad company to provide flagging.

☑ Outside Party: Contractor will pay flagging invoices to be reimbursed by TxDOT

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Contact Information for Flagging:

☑ UPRR UP.info@railpros.com Call Center 877-315-0513, Select #1 for flagging UP.request@nrssinc.net Call Center 877-984-6777

- BNSF BNSFinfo@railprosfs.com Call Center 877-315-0513, Select #1 for flagging
- CPKCR KCS.info@railpros.com Call Center 877-315-0513, Select #1 for flagging Bottom Line On-Track Safety Services bottomline076@aol.com, 903-767-7630

OTHERS:

#### Contractor must incorporate railroad construction inspection into anticipated construction schedule.

☑ Not Required

□ Required. Contact Information for Construction Inspection:

#### III. CONSTRUCTION WORK TO BE PERFORMED BY THE RAILROAD

Required.
Regulieu.

☑ Not Required

Railroad Point of Contact:

Coordinate with TxDOT for any work to be performed by the Railroad Company. TxDOT must issue a work order for any work done by the Railroad Company prior to the work being performed.

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Type of Insurance	Amount of Coverage (Minimum)
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Commercial General Liability	\$2,000,000 / \$4,000,000
Business Automobile	\$2,000,000

#### **Railroad Protective Liability Limits**

- Not Required
- \$2,000,000 / \$6,000,000 ☑ Non - Bridge/Typical Maintenance Projects. Includes repairs to overpass/underpass and culvert structures \$5,000,000 / \$10,000,000
- □ Bridge Structure Projects. Includes new construction or replacement of overpass/ underpass structures

Other:

Location: DO

Subdivision:

Initials:

TXDOT 9 ard to by the **DISCLAIMER:** The use of this standard i TXDOT assumes no respoi

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□ Not Required

BNSF:

To view previously approved CROE templates agreed upon between the State and Railroad, see: https://www.txdot.gov/business/resources/railroad-highway-crossing/sample-right-of-entryagreements.html

Approved CROE templates are not to be modified by the Contractor.

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UPRR, BNSF, CPKCR will not accept on-track safety training certificates from other Railroads. Refer to each Railroad's specific contractor right of entry for training information.

Know and follow the Contractor's Right of Entry Agreement EXHIBIT D, MINIMUM SAFETY REQUIREMENTS regarding clothing, personal protective equipment, and general safety requirements.

**VIII. SUBCONTRACTORS** 

In Case of R Call: UPRR Railroad Em

**RR** Milepost

### V. CONTRACTOR'S RIGHT OF ENTRY (CROE)

- ☑ Required: UPRR Maintenance Consent Letter. TxDOT to assist
- □ Required: TxDOT to assist in obtaining the UPRR CROE
- □ Required: Contractor to obtain

- https://bnsf.railpermitting.com
- https://jllrpg.360works.com/fmi/webd/rpo_web_kcs.fmp12
- Other Railroads:

### VI. RAILROAD COORDINATION MEETING


A Railroad Coordination Meeting is required. See item 5, Article 8.1, of the Standard Specifications for Construction and Maintenance of Highways, Streets and Bridges Manual for more details.

A. Complete the Railroad's course "Orientation for Contractor's Safety," and maintain registration prior to working on the Railroad's property. This course is required to be completed annually by Contractor and Subcontractor personnel working on site.

Contractor shall not subcontract work without written consent of TxDOT. Subcontractors are subject to the same insurance requirements as the Prime Contractor

### IX. EMERGENCY NOTIFICATION

ailroad Emergency	
ergency Line at: 800-848-8715 DOT 441027B	
25.150	
Glidden	

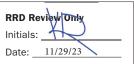

Texas Department of Transportation

Rail Division

FILE: rr-scop	e-of-work.pdf	dn: Tx	DOT	СК:	DW:			ск:
© TxDOT	June 2014	CONT	SECT	JOB			HIG	HWAY
0/0000	REVISIONS	0912	00	710		VARIOUS		IOUS
6/2023		DIST		COUNTY		:	SHEET NO.	
		HOU		HARRIS	;			109

□ This project is adjacent or parallel work, not within RR ROW: DOT No.: 743706A

Crossing Type: At-Grade

RR Company Operating Track at Crossing: <u>Union Pacific Railroad Company (UP)</u>

RR Company Owning Track at Crossing: UPRR

RR MP: 24.730

RR Subdivision: Glidden

City: Sugar Land

County: Fort Bend

CSJ at this Crossing: 0912-00-710

Latitude: 29°37'09.90"N Longitude: 95°38'16.60"W

Scope of Work, including any TCP, to be performed by State Contractor:

1) Pavement Markings

2) TCP(3-3)-14 & TCP(3-4)-13 3) Railroad and Contractor flaggers will coordinate with lane closures in vicinity of railroad. 4) All lanes across railroad tracks are to be open to traffic at the end of the day.

Scope of Work to be performed by Railroad Company:

N/A

#### II. FLAGGING & INSPECTION

No. of Days of Railroad Flagging Expected: 1

On this project, night or weekend flagging is:

Expected

Not Expected

Flagging services will be provided by:

□ Railroad Company: 1) Txdot will pay flagging invoices. Flagging Agreement with railroad will be needed or, 2) Permitted crossing. Railroad company to provide flagging.

☑ Outside Party: Contractor will pay flagging invoices to be reimbursed by TxDOT

Contractor must incorporate flaggers into anticipated construction schedule. The Railroad requires a 30-day notice if their flaggers are to be utilized. If Contractor falls behind schedule due to their own negligence and is not ready for scheduled flaggers, any flagging charges will be paid by Contractor.

Contact Information for Flagging:

☑ UPRR UP.info@railpros.com Call Center 877-315-0513, Select #1 for flagging UP.request@nrssinc.net Call Center 877-984-6777

BNSF BNSFinfo@railprosfs.com Call Center 877-315-0513, Select #1 for flagging

CPKCR KCS.info@railpros.com Call Center 877-315-0513, Select #1 for flagging Bottom Line On-Track Safety Services bottomline076@aol.com, 903-767-7630

OTHERS:

#### Contractor must incorporate railroad construction inspection into anticipated construction schedule.

☑ Not Required

□ Required. Contact Information for Construction Inspection:

#### III. CONSTRUCTION WORK TO BE PERFORMED BY THE RAILROAD

Required.	
Required.	

☑ Not Required

Railroad Point of Contact:

Coordinate with TxDOT for any work to be performed by the Railroad Company. TxDOT must issue a work order for any work done by the Railroad Company prior to the work being performed.

#### IV. RAILROAD INSURANCE REQUIREMENTS

The Contractor shall confirm the insurance requirements with the Railroad as the insurance limits are subject to change without notice.

Insurance policies and corresponding certificates of insurance must be issued by the contractor on behalf of the Railroad. Separate insurance policies and certificates are required when more than one Railroad Company is operating on the same right of way, or when several Railroad Companies are involved and operate on their own separate right of ways.

No direct compensation will be made to the Contractor for providing the insurance coverages shown below or any deductibles. These costs are incidental to the various bid items.

	Escalated Limits
Type of Insurance	Amount of Coverage (Minimum)
Workers Compensation	\$500,000 / \$500,000 / \$500,000
Commercial General Liability	\$2,000,000 / \$4,000,000
Business Automobile	\$2,000,000

#### **Railroad Protective Liability Limits**

- Not Required
- \$2,000,000 / \$6,000,000 ☑ Non - Bridge/Typical Maintenance Projects. Includes repairs to overpass/underpass and culvert structures \$5,000,000 / \$10,000,000
- □ Bridge Structure Projects. Includes new construction or replacement of overpass/ underpass structures

Other:

TXDOT 9 ard to by the **DISCLAIMER:** The use of this st TxDOT assumes r

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its

□ Not Required

BNSF:

To view previously approved CROE templates agreed upon between the State and Railroad, see: https://www.txdot.gov/business/resources/railroad-highway-crossing/sample-right-of-entryagreements.html

Approved CROE templates are not to be modified by the Contractor.

Contractor shall not operate within Railroad Right of Way without an executed Construction & Maintenance Agreement between the State and the Railroad and an executed CROE between the Contractor and the Railroad if required on project.

### VII. RAILROAD SAFETY ORIENTATION

UPRR, BNSF, CPKCR will not accept on-track safety training certificates from other Railroads. Refer to each Railroad's specific contractor right of entry for training information.

Know and follow the Contractor's Right of Entry Agreement EXHIBIT D, MINIMUM SAFETY REQUIREMENTS regarding clothing, personal protective equipment, and general safety requirements.

**VIII. SUBCONTRACTORS** 

In Case of R Call: UPRR Railroad Em

Location: DO **RR** Milepost

Subdivision

Type of Insurance	Amount of Coverage (Minimum)
Workers Compensation	\$500,000 / \$500,000 / \$500,000
Commercial General Liability	\$2,000,000 / \$4,000,000
Business Automobile	\$2,000,000

### V. CONTRACTOR'S RIGHT OF ENTRY (CROE)

- ☑ Required: UPRR Maintenance Consent Letter. TxDOT to assist
- □ Required: TxDOT to assist in obtaining the UPRR CROE
- □ Required: Contractor to obtain

- https://bnsf.railpermitting.com
- https://jllrpg.360works.com/fmi/webd/rpo_web_kcs.fmp12
- Other Railroads:

### VI. RAILROAD COORDINATION MEETING


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Contractor shall not subcontract work without written consent of TxDOT. Subcontractors are subject to the same insurance requirements as the Prime Contractor

### IX. EMERGENCY NOTIFICATION

Railroad Emergency
ergency Line at: 800-848-8715
DT_DOT 743706A
: 24.730
Glidden



Texas Department of Transportation

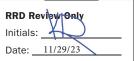Rail Division

FILE: rr-scop	e-of-work.pdf	dn: Tx	DOT	СК:	DW:			ск:		
© TxDOT	June 2014	CONT	SECT	JOB		JOB		HIGHWAY		
0/0000	REVISIONS	0912	00	710		VARIOUS		VARIO		IOUS
6/2023		DIST		COUNTY		SHEET		SHEET NO.		
		HOU		HARRIS	;			110		

□ This project is adjacent or parallel work, not within RR ROW: DOT No.: 743704L

Crossing Type: At-Grade

RR Company Operating Track at Crossing: <u>Union Pacific Railroad Company (UP)</u>

RR Company Owning Track at Crossing: UPRR

RR MP: 24.560

RR Subdivision: Glidden

City: Sugar Land

County: Fort Bend

CSJ at this Crossing: 0912-00-710

Latitude: 29°37'13.00"N Longitude: 95°38'06.90"W

Scope of Work, including any TCP, to be performed by State Contractor:

1) Pavement Markings

2) TCP(3-3)-14 & TCP(3-4)-13

3) Railroad and Contractor flaggers will coordinate with lane closures in vicinity of railroad. 4) All lanes across railroad tracks are to be open to traffic at the end of the day.

Scope of Work to be performed by Railroad Company:

N/A

#### II. FLAGGING & INSPECTION

No. of Days of Railroad Flagging Expected: 1

On this project, night or weekend flagging is:

Expected

Not Expected

Flagging services will be provided by:

□ Railroad Company: 1) Txdot will pay flagging invoices. Flagging Agreement with railroad will be needed or, 2) Permitted crossing. Railroad company to provide flagging.

☑ Outside Party: Contractor will pay flagging invoices to be reimbursed by TxDOT

Contractor must incorporate flaggers into anticipated construction schedule. The Railroad requires a 30-day notice if their flaggers are to be utilized. If Contractor falls behind schedule due to their own negligence and is not ready for scheduled flaggers, any flagging charges will be paid by Contractor.

Contact Information for Flagging:

☑ UPRR UP.info@railpros.com Call Center 877-315-0513, Select #1 for flagging UP.request@nrssinc.net Call Center 877-984-6777

- BNSF BNSFinfo@railprosfs.com Call Center 877-315-0513, Select #1 for flagging
- CPKCR KCS.info@railpros.com Call Center 877-315-0513, Select #1 for flagging Bottom Line On-Track Safety Services bottomline076@aol.com, 903-767-7630

OTHERS:

#### Contractor must incorporate railroad construction inspection into anticipated construction schedule.

☑ Not Required

□ Required. Contact Information for Construction Inspection:

#### III. CONSTRUCTION WORK TO BE PERFORMED BY THE RAILROAD

Required.
Required.

☑ Not Required

Railroad Point of Contact:

Coordinate with TxDOT for any work to be performed by the Railroad Company. TxDOT must issue a work order for any work done by the Railroad Company prior to the work being performed.

#### IV. RAILROAD INSURANCE REQUIREMENTS

The Contractor shall confirm the insurance requirements with the Railroad as the insurance limits are subject to change without notice.

Insurance policies and corresponding certificates of insurance must be issued by the contractor on behalf of the Railroad. Separate insurance policies and certificates are required when more than one Railroad Company is operating on the same right of way, or when several Railroad Companies are involved and operate on their own separate right of ways.

No direct compensation will be made to the Contractor for providing the insurance coverages shown below or any deductibles. These costs are incidental to the various bid items.

	Escalated Limits
Type of Insurance	Amount of Coverage (Minimum)
Workers Compensation	\$500,000 / \$500,000 / \$500,000
Commercial General Liability	\$2,000,000 / \$4,000,000
Business Automobile	\$2,000,000

#### **Railroad Protective Liability Limits**

- Not Required
- \$2,000,000 / \$6,000,000 ☑ Non - Bridge/Typical Maintenance Projects. Includes repairs to overpass/underpass and culvert structures \$5,000,000 / \$10,000,000
- □ Bridge Structure Projects. Includes new construction or replacement of overpass/ underpass structures

Other:

Initials:

□ Not Required

BNSF:

To view previously approved CROE templates agreed upon between the State and Railroad, see: https://www.txdot.gov/business/resources/railroad-highway-crossing/sample-right-of-entryagreements.html

Approved CROE templates are not to be modified by the Contractor.

Contractor shall not operate within Railroad Right of Way without an executed Construction & Maintenance Agreement between the State and the Railroad and an executed CROE between the Contractor and the Railroad if required on project.

UPRR, BNSF, CPKCR will not accept on-track safety training certificates from other Railroads. Refer to each Railroad's specific contractor right of entry for training information.

Know and follow the Contractor's Right of Entry Agreement EXHIBIT D, MINIMUM SAFETY REQUIREMENTS regarding clothing, personal protective equipment, and general safety requirements.

### **VIII. SUBCONTRACTORS**

In Case of R Call: UPRR Railroad Em

Location: DO **RR** Milepost

Subdivision:

### V. CONTRACTOR'S RIGHT OF ENTRY (CROE)

- ☑ Required: UPRR Maintenance Consent Letter. TxDOT to assist
- □ Required: TxDOT to assist in obtaining the UPRR CROE
- □ Required: Contractor to obtain

- https://bnsf.railpermitting.com
- https://jllrpg.360works.com/fmi/webd/rpo_web_kcs.fmp12
- Other Railroads:

### VI. RAILROAD COORDINATION MEETING

A Railroad Coordination Meeting is required. See item 5, Article 8.1, of the Standard Specifications for Construction and Maintenance of Highways, Streets and Bridges Manual for more details.


### VII. RAILROAD SAFETY ORIENTATION

A. Complete the Railroad's course "Orientation for Contractor's Safety," and maintain registration prior to working on the Railroad's property. This course is required to be completed annually by Contractor and Subcontractor personnel working on site.

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### IX. EMERGENCY NOTIFICATION

ailroad Emergency
ergency Line at:800-848-8715
DT DOT 743704L
24.560
Glidden

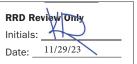

Texas Department of Transportation

Rail Division

FILE: rr-scop	e-of-work.pdf	dn: Tx	DOT	СК:	DW:			CK:	
© TxDOT	June 2014	CONT	SECT	JOB		JOB H		HIGHWAY	
	REVISIONS	0912	00	710		VARIOUS		IOUS	
6/2023		DIST	COUNTY			:	HEET NO.		
		HOU		HARRIS	;			111	

□ This project is adjacent or parallel work, not within RR ROW: DOT No.: 743703E

Crossing Type: At-Grade

RR Company Operating Track at Crossing: <u>Union Pacific Railroad Company (UP)</u>

RR Company Owning Track at Crossing: UPRR

RR MP: 24.430

RR Subdivision: Glidden

City: Sugar Land

County: Fort Bend

CSJ at this Crossing: 0912-00-710

Latitude: 29°37'14.50"N Longitude: 95°37'59.60"W

Scope of Work, including any TCP, to be performed by State Contractor:

1) Pavement Markings

2) TCP(3-3)-14 & TCP(3-4)-13 3) Railroad and Contractor flaggers will coordinate with lane closures in vicinity of railroad.

4) All lanes across railroad tracks are to be open to traffic at the end of the day.

Scope of Work to be performed by Railroad Company:

N/A

#### II. FLAGGING & INSPECTION

No. of Days of Railroad Flagging Expected: 1

On this project, night or weekend flagging is:

Expected

Not Expected

Flagging services will be provided by:

□ Railroad Company: 1) Txdot will pay flagging invoices. Flagging Agreement with railroad will be needed or, 2) Permitted crossing. Railroad company to provide flagging.

☑ Outside Party: Contractor will pay flagging invoices to be reimbursed by TxDOT

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Contact Information for Flagging:

☑ UPRR UP.info@railpros.com Call Center 877-315-0513, Select #1 for flagging UP.request@nrssinc.net Call Center 877-984-6777

- BNSF BNSFinfo@railprosfs.com Call Center 877-315-0513, Select #1 for flagging
- CPKCR KCS.info@railpros.com Call Center 877-315-0513, Select #1 for flagging Bottom Line On-Track Safety Services bottomline076@aol.com, 903-767-7630

OTHERS:

#### Contractor must incorporate railroad construction inspection into anticipated construction schedule.

☑ Not Required

□ Required. Contact Information for Construction Inspection:

#### III. CONSTRUCTION WORK TO BE PERFORMED BY THE RAILROAD

Reauired.
neguneu.

☑ Not Required

Railroad Point of Contact:

Coordinate with TxDOT for any work to be performed by the Railroad Company. TxDOT must issue a work order for any work done by the Railroad Company prior to the work being performed.

#### IV. RAILROAD INSURANCE REQUIREMENTS

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No direct compensation will be made to the Contractor for providing the insurance coverages shown below or any deductibles. These costs are incidental to the various bid items.

Escalated Limits						
Type of Insurance	Amount of Coverage (Minimum)					
Workers Compensation	\$500,000 / \$500,000 / \$500,000					
Commercial General Liability	\$2,000,000 / \$4,000,000					
Business Automobile	\$2,000,000					

#### **Railroad Protective Liability Limits**

- Not Required
- \$2,000,000 / \$6,000,000 ☑ Non - Bridge/Typical Maintenance Projects. Includes repairs to overpass/underpass and culvert structures \$5,000,000 / \$10,000,000 □ Bridge Structure Projects. Includes new
- construction or replacement of overpass/ underpass structures

Other:

Railroad Em Location: DO

Initials:

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□ Not Required

BNSF:

To view previously approved CROE templates agreed upon between the State and Railroad, see: https://www.txdot.gov/business/resources/railroad-highway-crossing/sample-right-of-entryagreements.html

Approved CROE templates are not to be modified by the Contractor.

Contractor shall not operate within Railroad Right of Way without an executed Construction & Maintenance Agreement between the State and the Railroad and an executed CROE between the Contractor and the Railroad if required on project.

### VII. RAILROAD SAFETY ORIENTATION

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Know and follow the Contractor's Right of Entry Agreement EXHIBIT D, MINIMUM SAFETY REQUIREMENTS regarding clothing, personal protective equipment, and general safety requirements.

**VIII. SUBCONTRACTORS** 

In Case of R Call: UPRR

**RR** Milepost

Subdivision:

### V. CONTRACTOR'S RIGHT OF ENTRY (CROE)

- ☑ Required: UPRR Maintenance Consent Letter. TxDOT to assist
- □ Required: TxDOT to assist in obtaining the UPRR CROE
- □ Required: Contractor to obtain
  - https://bnsf.railpermitting.com
  - https://jllrpg.360works.com/fmi/webd/rpo_web_kcs.fmp12
  - Other Railroads:

### VI. RAILROAD COORDINATION MEETING


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tailroad Emergency	
ergency Line at:800-848-8715	
DOT 743703E	
24.430	
Glidden	



Texas Department of Transportation

Rail Division

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© TxDOT	June 2014	CONT	SECT	JOB			HIG	HWAY
0/0000	REVISIONS	0912	00	710		VARIOUS		IOUS
6/2023		DIST	COUNTY			:	SHEET NO.	
		HOU		HARRIS	;			112

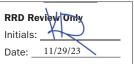□ This project is adjacent or parallel work, not within RR ROW: DOT No.: 743699S

Crossing Type: At-Grade

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**DISCLAIMER:** The use of this standard i TXDOT assumes no respoi

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RR Company Operating Track at Crossing: <u>Union Pacific Railroad Company (UP)</u>

RR Company Owning Track at Crossing: UPRR

RR MP: 23.576

RR Subdivision: Glidden

City: Sugar Land

County: Fort Bend

CSJ at this Crossing: 0912-00-710

Latitude: 29°37'24.80"N

Longitude: 95°37'07.90"W

Scope of Work, including any TCP, to be performed by State Contractor:

1) Pavement Markings

2) TCP(3-4)-13

3) Railroad and Contractor flaggers will coordinate with lane closures in vicinity of railroad. 4) All lanes across railroad tracks are to be open to traffic at the end of the day.

Scope of Work to be performed by Railroad Company:

N/A

#### II. FLAGGING & INSPECTION

No. of Days of Railroad Flagging Expected: 1

On this project, night or weekend flagging is:

Expected

Not Expected

Flagging services will be provided by:

□ Railroad Company: 1) Txdot will pay flagging invoices. Flagging Agreement with railroad will be needed or, 2) Permitted crossing. Railroad company to provide flagging.

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- BNSF BNSFinfo@railprosfs.com Call Center 877-315-0513, Select #1 for flagging
- CPKCR KCS.info@railpros.com Call Center 877-315-0513, Select #1 for flagging Bottom Line On-Track Safety Services bottomline076@aol.com, 903-767-7630

OTHERS:

#### Contractor must incorporate railroad construction inspection into anticipated construction schedule.

☑ Not Required

□ Required. Contact Information for Construction Inspection:

#### III. CONSTRUCTION WORK TO BE PERFORMED BY THE RAILROAD

Required.
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☑ Not Required

Railroad Point of Contact:

Coordinate with TxDOT for any work to be performed by the Railroad Company. TxDOT must issue a work order for any work done by the Railroad Company prior to the work being performed.

#### IV. RAILROAD INSURANCE REQUIREMENTS

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- Not Required
- \$2,000,000 / \$6,000,000 ☑ Non - Bridge/Typical Maintenance Projects. Includes repairs to overpass/underpass and culvert structures \$5,000,000 / \$10,000,000
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Other:

Location: DO

To view previously approved CROE templates agreed upon between the State and Railroad, see: https://www.txdot.gov/business/resources/railroad-highway-crossing/sample-right-of-entryagreements.html

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**VIII. SUBCONTRACTORS** 

# In Case of R

# Call: UPRR Railroad Em

**RR** Milepost Subdivision:

Initials:

# 

### V. CONTRACTOR'S RIGHT OF ENTRY (CROE)

□ Not Required

- ☑ Required: UPRR Maintenance Consent Letter. TxDOT to assist
- □ Required: TxDOT to assist in obtaining the UPRR CROE
- □ Required: Contractor to obtain

- https://bnsf.railpermitting.com
- https://jllrpg.360works.com/fmi/webd/rpo_web_kcs.fmp12
- Other Railroads:

Approved CROE templates are not to be modified by the Contractor.

### VI. RAILROAD COORDINATION MEETING


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### IX. EMERGENCY NOTIFICATION

Railroad Emergency
ergency Line at: 800-848-8715
OT DOT 743699S
t: <u>23.576</u>
Glidden



Texas Department of Transportation

Rail Division

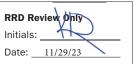FILE: rr-scop	e-of-work.pdf	dn: Tx	DOT	СК:	DW:			CK:
© TxDOT	June 2014	CONT	SECT	JOB		1	HIGH	WAY
0/0000	REVISIONS	0912	00	710		VARIOUS		OUS
6/2023		DIST		COUNTY		s	HEET NO.	
		HOU		HARRIS				113

□ This project is adjacent or parallel work, not within RR ROW: DOT No.: 745055W

Crossing Type: At-Grade

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**DISCLAIMER:** The use of this standard i TXDOT assumes no respoi

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RR Company Operating Track at Crossing: <u>Union Pacific Railroad Company (UP)</u>

RR Company Owning Track at Crossing: UPRR

RR MP: 23.262

RR Subdivision: Glidden

City: Sugar Land

County: Fort Bend

CSJ at this Crossing: 0912-00-710

Latitude: 29°37'28.40"N Longitude: 95°36'49.90"W

Scope of Work, including any TCP, to be performed by State Contractor:

1) Pavement Markings

2) TCP(3-3)-14 & TCP(3-4)-13 3) Railroad and Contractor flaggers will coordinate with lane closures in vicinity of railroad. 4) All lanes across railroad tracks are to be open to traffic at the end of the day.

Scope of Work to be performed by Railroad Company:

N/A

#### II. FLAGGING & INSPECTION

No. of Days of Railroad Flagging Expected: 1

On this project, night or weekend flagging is:

Expected

Not Expected

Flagging services will be provided by:

□ Railroad Company: 1) Txdot will pay flagging invoices. Flagging Agreement with railroad will be needed or, 2) Permitted crossing. Railroad company to provide flagging.

☑ Outside Party: Contractor will pay flagging invoices to be reimbursed by TxDOT

Contractor must incorporate flaggers into anticipated construction schedule. The Railroad requires a 30-day notice if their flaggers are to be utilized. If Contractor falls behind schedule due to their own negligence and is not ready for scheduled flaggers, any flagging charges will be paid by Contractor.

Contact Information for Flagging:

☑ UPRR UP.info@railpros.com Call Center 877-315-0513, Select #1 for flagging UP.request@nrssinc.net Call Center 877-984-6777

BNSF BNSFinfo@railprosfs.com Call Center 877-315-0513, Select #1 for flagging

CPKCR KCS.info@railpros.com Call Center 877-315-0513, Select #1 for flagging Bottom Line On-Track Safety Services bottomline076@aol.com, 903-767-7630

OTHERS:

#### Contractor must incorporate railroad construction inspection into anticipated construction schedule.

☑ Not Required

□ Required. Contact Information for Construction Inspection:

#### III. CONSTRUCTION WORK TO BE PERFORMED BY THE RAILROAD

Required.	
neguneu.	

☑ Not Required

Railroad Point of Contact:

Coordinate with TxDOT for any work to be performed by the Railroad Company. TxDOT must issue a work order for any work done by the Railroad Company prior to the work being performed.

#### IV. RAILROAD INSURANCE REQUIREMENTS

The Contractor shall confirm the insurance requirements with the Railroad as the insurance limits are subject to change without notice.

Insurance policies and corresponding certificates of insurance must be issued by the contractor on behalf of the Railroad. Separate insurance policies and certificates are required when more than one Railroad Company is operating on the same right of way, or when several Railroad Companies are involved and operate on their own separate right of ways.

No direct compensation will be made to the Contractor for providing the insurance coverages shown below or any deductibles. These costs are incidental to the various bid items.

	Escalated Limits
Type of Insurance	Amount of Coverage (Minimum)
Workers Compensation	\$500,000 / \$500,000 / \$500,000
Commercial General Liability	\$2,000,000 / \$4,000,000
Business Automobile	\$2,000,000

#### **Railroad Protective Liability Limits**

- Not Required
- \$2,000,000 / \$6,000,000 ☑ Non - Bridge/Typical Maintenance Projects. Includes repairs to overpass/underpass and culvert structures \$5,000,000 / \$10,000,000
- □ Bridge Structure Projects. Includes new construction or replacement of overpass/ underpass structures

Other:

Initials:

□ Not Required

BNSF:

To view previously approved CROE templates agreed upon between the State and Railroad, see: https://www.txdot.gov/business/resources/railroad-highway-crossing/sample-right-of-entryagreements.html

Approved CROE templates are not to be modified by the Contractor.

Contractor shall not operate within Railroad Right of Way without an executed Construction & Maintenance Agreement between the State and the Railroad and an executed CROE between the Contractor and the Railroad if required on project.

### VII. RAILROAD SAFETY ORIENTATION

UPRR, BNSF, CPKCR will not accept on-track safety training certificates from other Railroads. Refer to each Railroad's specific contractor right of entry for training information.

Know and follow the Contractor's Right of Entry Agreement EXHIBIT D, MINIMUM SAFETY REQUIREMENTS regarding clothing, personal protective equipment, and general safety requirements.

**VIII. SUBCONTRACTORS** 

In Case of R

Call: UPRR Railroad Em

Location: DO **RR** Milepost

Subdivision:

### V. CONTRACTOR'S RIGHT OF ENTRY (CROE)

- ☑ Required: UPRR Maintenance Consent Letter. TxDOT to assist
- □ Required: TxDOT to assist in obtaining the UPRR CROE
- □ Required: Contractor to obtain

- https://bnsf.railpermitting.com
- https://jllrpg.360works.com/fmi/webd/rpo_web_kcs.fmp12
- Other Railroads:

### VI. RAILROAD COORDINATION MEETING


A Railroad Coordination Meeting is required. See item 5, Article 8.1, of the Standard Specifications for Construction and Maintenance of Highways, Streets and Bridges Manual for more details.

A. Complete the Railroad's course "Orientation for Contractor's Safety," and maintain registration prior to working on the Railroad's property. This course is required to be completed annually by Contractor and Subcontractor personnel working on site.

Contractor shall not subcontract work without written consent of TxDOT. Subcontractors are subject to the same insurance requirements as the Prime Contractor

### IX. EMERGENCY NOTIFICATION

Railroad Emergency
ergency Line at: 800-848-8715
OT _DOT 745055W
: 23.262
Glidden

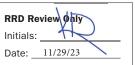

Texas Department of Transportation

Rail Division

FILE: rr-scop	e-of-work.pdf	dn: Tx	DOT	СК:	DW:			CK:
© TxDOT	June 2014	CONT	SECT	JOB			HIGI	HWAY
0/0000	REVISIONS	0912	00	710		VARIOUS		IOUS
6/2023		DIST	COUNTY			5	SHEET NO.	
		HOU		HARRIS				114

□ This project is adjacent or parallel work, not within RR ROW: DOT No.: 748393E

Crossing Type: At-Grade

RR Company Operating Track at Crossing: <u>Union Pacific Railroad Company (UP)</u>

RR Company Owning Track at Crossing: UPRR

RR MP: 23.027

RR Subdivision: Glidden

City: Sugar Land

County: Fort Bend

CSJ at this Crossing: 0912-00-710 Latitude: 29°37'31.10"N

Longitude: 95°36'36.30"W

Scope of Work, including any TCP, to be performed by State Contractor:

1) Pavement Markings

2) TCP(3-4)-13 3) Railroad and Contractor flaggers will coordinate with lane closures in vicinity of railroad. 4) All lanes across railroad tracks are to be open to traffic at the end of the day.

Scope of Work to be performed by Railroad Company:

N/A

#### II. FLAGGING & INSPECTION

No. of Days of Railroad Flagging Expected: 1

On this project, night or weekend flagging is:

Expected

Not Expected

Flagging services will be provided by:

□ Railroad Company: 1) Txdot will pay flagging invoices. Flagging Agreement with railroad will be needed or, 2) Permitted crossing. Railroad company to provide flagging.

☑ Outside Party: Contractor will pay flagging invoices to be reimbursed by TxDOT

Contractor must incorporate flaggers into anticipated construction schedule. The Railroad requires a 30-day notice if their flaggers are to be utilized. If Contractor falls behind schedule due to their own negligence and is not ready for scheduled flaggers, any flagging charges will be paid by Contractor.

Contact Information for Flagging:

☑ UPRR UP.info@railpros.com Call Center 877-315-0513, Select #1 for flagging UP.request@nrssinc.net Call Center 877-984-6777

- BNSF BNSFinfo@railprosfs.com Call Center 877-315-0513, Select #1 for flagging
- CPKCR KCS.info@railpros.com Call Center 877-315-0513, Select #1 for flagging Bottom Line On-Track Safety Services bottomline076@aol.com, 903-767-7630

OTHERS:

#### Contractor must incorporate railroad construction inspection into anticipated construction schedule.

☑ Not Required

□ Required. Contact Information for Construction Inspection:

#### III. CONSTRUCTION WORK TO BE PERFORMED BY THE RAILROAD

Reauired.
neguneu.

☑ Not Required

Railroad Point of Contact:

Coordinate with TxDOT for any work to be performed by the Railroad Company. TxDOT must issue a work order for any work done by the Railroad Company prior to the work being performed.

#### IV. RAILROAD INSURANCE REQUIREMENTS

The Contractor shall confirm the insurance requirements with the Railroad as the insurance limits are subject to change without notice.

Insurance policies and corresponding certificates of insurance must be issued by the contractor on behalf of the Railroad. Separate insurance policies and certificates are required when more than one Railroad Company is operating on the same right of way, or when several Railroad Companies are involved and operate on their own separate right of ways.

No direct compensation will be made to the Contractor for providing the insurance coverages shown below or any deductibles. These costs are incidental to the various bid items.

Escalated Limits					
Type of Insurance	Amount of Coverage (Minimum)				
Workers Compensation	\$500,000 / \$500,000 / \$500,000				
Commercial General Liability	\$2,000,000 / \$4,000,000				
Business Automobile	\$2,000,000				

#### **Railroad Protective Liability Limits**

- Not Required
- \$2,000,000 / \$6,000,000 ☑ Non - Bridge/Typical Maintenance Projects. Includes repairs to overpass/underpass and culvert structures \$5,000,000 / \$10,000,000 □ Bridge Structure Projects. Includes new
- construction or replacement of overpass/ underpass structures

Other:

Initials:

□ Not Required

BNSF:

To view previously approved CROE templates agreed upon between the State and Railroad, see: https://www.txdot.gov/business/resources/railroad-highway-crossing/sample-right-of-entryagreements.html

Approved CROE templates are not to be modified by the Contractor.

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UPRR, BNSF, CPKCR will not accept on-track safety training certificates from other Railroads. Refer to each Railroad's specific contractor right of entry for training information.

Know and follow the Contractor's Right of Entry Agreement EXHIBIT D, MINIMUM SAFETY REQUIREMENTS regarding clothing, personal protective equipment, and general safety requirements.

**VIII. SUBCONTRACTORS** 

In Case of R Call: UPRR Railroad Em Location: DO

**RR** Milepost Subdivision:

### V. CONTRACTOR'S RIGHT OF ENTRY (CROE)

- ☑ Required: UPRR Maintenance Consent Letter. TxDOT to assist
- □ Required: TxDOT to assist in obtaining the UPRR CROE
- □ Required: Contractor to obtain

- https://bnsf.railpermitting.com
- https://jllrpg.360works.com/fmi/webd/rpo_web_kcs.fmp12
- Other Railroads:

### VI. RAILROAD COORDINATION MEETING

A Railroad Coordination Meeting is required. See item 5, Article 8.1, of the Standard Specifications for Construction and Maintenance of Highways, Streets and Bridges Manual for more details.


### VII. RAILROAD SAFETY ORIENTATION

A. Complete the Railroad's course "Orientation for Contractor's Safety," and maintain registration prior to working on the Railroad's property. This course is required to be completed annually by Contractor and Subcontractor personnel working on site.

Contractor shall not subcontract work without written consent of TxDOT. Subcontractors are subject to the same insurance requirements as the Prime Contractor

### IX. EMERGENCY NOTIFICATION

ailroad Emergency
ergency Line at: 800-848-8715
DT DOT 748393E
23.027
Glidden

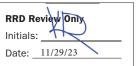

Texas Department of Transportation

Rail Division

FILE: rr-scop	e-of-work.pdf	dn: Tx	DOT	СК:	DW:			ск:
© TxDOT	June 2014	CONT	SECT	JOB			HIG	HWAY
0/0000	REVISIONS	0912	00	710		VARIOUS		IOUS
6/2023		DIST		COUNTY			:	SHEET NO.
		HOU		HARRIS	;			115

□ This project is adjacent or parallel work, not within RR ROW: DOT No.: 743698K

Crossing Type: At-Grade

RR Company Operating Track at Crossing: <u>Union Pacific Railroad Company (UP)</u>

RR Company Owning Track at Crossing: UPRR

RR MP: 22.710

RR Subdivision: Glidden

City: Sugar Land

County: Fort Bend

CSJ at this Crossing: 0912-00-710

Latitude: 29°37'34.00"N Longitude: 95°36'21.20"W

Scope of Work, including any TCP, to be performed by State Contractor:

1) Pavement Markings 2) TCP(3-4)-13

3) Railroad and Contractor flaggers will coordinate with lane closures in vicinity of railroad. 4) All lanes across railroad tracks are to be open to traffic at the end of the day.

Scope of Work to be performed by Railroad Company:

N/A

#### II. FLAGGING & INSPECTION

No. of Days of Railroad Flagging Expected: 1

On this project, night or weekend flagging is:

Expected

Not Expected

Flagging services will be provided by:

□ Railroad Company: 1) Txdot will pay flagging invoices. Flagging Agreement with railroad will be needed or, 2) Permitted crossing. Railroad company to provide flagging.

☑ Outside Party: Contractor will pay flagging invoices to be reimbursed by TxDOT

Contractor must incorporate flaggers into anticipated construction schedule. The Railroad requires a 30-day notice if their flaggers are to be utilized. If Contractor falls behind schedule due to their own negligence and is not ready for scheduled flaggers, any flagging charges will be paid by Contractor.

Contact Information for Flagging:

☑ UPRR UP.info@railpros.com Call Center 877-315-0513, Select #1 for flagging UP.request@nrssinc.net Call Center 877-984-6777

- BNSF BNSFinfo@railprosfs.com Call Center 877-315-0513, Select #1 for flagging
- CPKCR KCS.info@railpros.com Call Center 877-315-0513, Select #1 for flagging Bottom Line On-Track Safety Services bottomline076@aol.com, 903-767-7630

OTHERS:

#### Contractor must incorporate railroad construction inspection into anticipated construction schedule.

☑ Not Required

□ Required. Contact Information for Construction Inspection:

#### III. CONSTRUCTION WORK TO BE PERFORMED BY THE RAILROAD

Reauired.
neguneu.

☑ Not Required

Railroad Point of Contact:

Coordinate with TxDOT for any work to be performed by the Railroad Company. TxDOT must issue a work order for any work done by the Railroad Company prior to the work being performed.

#### IV. RAILROAD INSURANCE REQUIREMENTS

The Contractor shall confirm the insurance requirements with the Railroad as the insurance limits are subject to change without notice.

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No direct compensation will be made to the Contractor for providing the insurance coverages shown below or any deductibles. These costs are incidental to the various bid items.

Escalated Limits					
Type of Insurance	Amount of Coverage (Minimum)				
Workers Compensation	\$500,000 / \$500,000 / \$500,000				
Commercial General Liability	\$2,000,000 / \$4,000,000				
Business Automobile	\$2,000,000				

#### **Railroad Protective Liability Limits**

- Not Required
- \$2,000,000 / \$6,000,000 ☑ Non - Bridge/Typical Maintenance Projects. Includes repairs to overpass/underpass and culvert structures \$5,000,000 / \$10,000,000 □ Bridge Structure Projects. Includes new
- construction or replacement of overpass/ underpass structures

Other:

□ Not Required

BNSF:

To view previously approved CROE templates agreed upon between the State and Railroad, see: https://www.txdot.gov/business/resources/railroad-highway-crossing/sample-right-of-entryagreements.html

Approved CROE templates are not to be modified by the Contractor.

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### VII. RAILROAD SAFETY ORIENTATION

UPRR, BNSF, CPKCR will not accept on-track safety training certificates from other Railroads. Refer to each Railroad's specific contractor right of entry for training information.

Know and follow the Contractor's Right of Entry Agreement EXHIBIT D, MINIMUM SAFETY REQUIREMENTS regarding clothing, personal protective equipment, and general safety requirements.

**VIII. SUBCONTRACTORS** 

In Case of R Call: UPRR Railroad Em Location: DO

**RR** Milepost Subdivision

### V. CONTRACTOR'S RIGHT OF ENTRY (CROE)

- ☑ Required: UPRR Maintenance Consent Letter. TxDOT to assist
- □ Required: TxDOT to assist in obtaining the UPRR CROE
- □ Required: Contractor to obtain

- https://bnsf.railpermitting.com
- https://jllrpg.360works.com/fmi/webd/rpo_web_kcs.fmp12
- Other Railroads:

### VI. RAILROAD COORDINATION MEETING


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Contractor shall not subcontract work without written consent of TxDOT. Subcontractors are subject to the same insurance requirements as the Prime Contractor

### IX. EMERGENCY NOTIFICATION

ailroad Emergency
ergency Line at: _800-848-8715
DOT 743698K
22.710
Glidden



Texas Department of Transportation

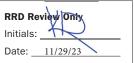Rail Division

FILE: rr-scop	e-of-work.pdf	dn: Tx	DOT	СК:	DW:			CK:
© TxDOT	June 2014	CONT	SECT	JOB			HIGI	HWAY
0/0000	REVISIONS	0912	00	710		VARIOUS		IOUS
6/2023		DIST		COUNTY			5	SHEET NO.
		HOU		HARRIS				116

□ This project is adjacent or parallel work, not within RR ROW: DOT No.: 745044J

Crossing Type: At-Grade

RR Company Operating Track at Crossing: <u>Union Pacific Railroad Company (UP)</u>

RR Company Owning Track at Crossing: UPRR

RR MP: 22.520

RR Subdivision: Glidden

City: Sugar Land

County: Fort Bend

CSJ at this Crossing: 0912-00-710

Latitude: 29°37'36.10"N Longitude: 95°36'10.60"W

Scope of Work, including any TCP, to be performed by State Contractor:

1) Pavement Markings

2) TCP(3-4)-13

3) Railroad and Contractor flaggers will coordinate with lane closures in vicinity of railroad. 4) All lanes across railroad tracks are to be open to traffic at the end of the day.

Scope of Work to be performed by Railroad Company:

N/A

#### II. FLAGGING & INSPECTION

No. of Days of Railroad Flagging Expected: 1

On this project, night or weekend flagging is:

Expected

Not Expected

Flagging services will be provided by:

□ Railroad Company: 1) Txdot will pay flagging invoices. Flagging Agreement with railroad will be needed or, 2) Permitted crossing. Railroad company to provide flagging.

☑ Outside Party: Contractor will pay flagging invoices to be reimbursed by TxDOT

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BNSF BNSFinfo@railprosfs.com Call Center 877-315-0513, Select #1 for flagging

CPKCR KCS.info@railpros.com Call Center 877-315-0513, Select #1 for flagging Bottom Line On-Track Safety Services bottomline076@aol.com, 903-767-7630

OTHERS:

#### Contractor must incorporate railroad construction inspection into anticipated construction schedule.

☑ Not Required

□ Required. Contact Information for Construction Inspection:

#### III. CONSTRUCTION WORK TO BE PERFORMED BY THE RAILROAD

Required.	
Required.	

☑ Not Required

Railroad Point of Contact:

Coordinate with TxDOT for any work to be performed by the Railroad Company. TxDOT must issue a work order for any work done by the Railroad Company prior to the work being performed.

#### IV. RAILROAD INSURANCE REQUIREMENTS

The Contractor shall confirm the insurance requirements with the Railroad as the insurance limits are subject to change without notice.

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Escalated Limits					
Type of Insurance	Amount of Coverage (Minimum)				
Workers Compensation	\$500,000 / \$500,000 / \$500,000				
Commercial General Liability	\$2,000,000 / \$4,000,000				
Business Automobile	\$2,000,000				

#### **Railroad Protective Liability Limits**

- Not Required
- \$2,000,000 / \$6,000,000 ☑ Non - Bridge/Typical Maintenance Projects. Includes repairs to overpass/underpass and culvert structures \$5,000,000 / \$10,000,000
- □ Bridge Structure Projects. Includes new construction or replacement of overpass/ underpass structures

Other:

Railroad Em

# □ Not Required

BNSF:

To view previously approved CROE templates agreed upon between the State and Railroad, see: https://www.txdot.gov/business/resources/railroad-highway-crossing/sample-right-of-entryagreements.html

Approved CROE templates are not to be modified by the Contractor.

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### VII. RAILROAD SAFETY ORIENTATION

UPRR, BNSF, CPKCR will not accept on-track safety training certificates from other Railroads. Refer to each Railroad's specific contractor right of entry for training information.

Know and follow the Contractor's Right of Entry Agreement EXHIBIT D, MINIMUM SAFETY REQUIREMENTS regarding clothing, personal protective equipment, and general safety requirements.

**VIII. SUBCONTRACTORS** 

In Case of R Call: UPRR

Location: DO

**RR** Milepost Subdivision:

### V. CONTRACTOR'S RIGHT OF ENTRY (CROE)

- ☑ Required: UPRR Maintenance Consent Letter. TxDOT to assist
- □ Required: TxDOT to assist in obtaining the UPRR CROE
- □ Required: Contractor to obtain

- https://bnsf.railpermitting.com
- https://jllrpg.360works.com/fmi/webd/rpo_web_kcs.fmp12
- Other Railroads:

### VI. RAILROAD COORDINATION MEETING


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ailroad Emerger	ю
ergency Line at:	800-848-8715
DT DOT 745044J	
22.520	
Glidden	



Texas Department of Transportation

Rail Division

FILE: rr-scop	e-of-work.pdf	dn: Tx	DOT	СК:	DW:			СК:
© TxDOT	June 2014	CONT	SECT	JOB			HIG	HWAY
6/2022	REVISIONS	0912	00	710		VARIOUS		IOUS
6/2023		DIST		COUNTY SHE		SHEET NO.		
		HOU		HARRIS	;			117

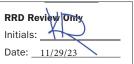□ This project is adjacent or parallel work, not within RR ROW: DOT No.: 748273N

Crossing Type: Overpass

RR Company Operating Track at Crossing: <u>Union Pacific Railroad Company (UP)</u>

RR Company Owning Track at Crossing: UPRR

RR MP: 21.963

RR Subdivision: Glidden

City: Sugar Land

County: Fort Bend

CSJ at this Crossing: 0912-00-710

Latitude: 29°37'43.30"N Longitude: 95°35'35.90"W

Scope of Work, including any TCP, to be performed by State Contractor:

1) Pavement Markings

2) TCP(3-4)-13 3) Railroad and Contractor flaggers will coordinate with lane closures in vicinity of railroad. 4) All lanes across railroad tracks are to be open to traffic at the end of the day.

Scope of Work to be performed by Railroad Company:

N/A

#### II. FLAGGING & INSPECTION

No. of Days of Railroad Flagging Expected: 1

On this project, night or weekend flagging is:

Expected

Not Expected

Flagging services will be provided by:

□ Railroad Company: 1) Txdot will pay flagging invoices. Flagging Agreement with railroad will be needed or, 2) Permitted crossing. Railroad company to provide flagging.

☑ Outside Party: Contractor will pay flagging invoices to be reimbursed by TxDOT

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BNSF BNSFinfo@railprosfs.com Call Center 877-315-0513, Select #1 for flagging

CPKCR KCS.info@railpros.com Call Center 877-315-0513, Select #1 for flagging Bottom Line On-Track Safety Services bottomline076@aol.com, 903-767-7630

OTHERS:

#### Contractor must incorporate railroad construction inspection into anticipated construction schedule.

☑ Not Required

□ Required. Contact Information for Construction Inspection:

#### III. CONSTRUCTION WORK TO BE PERFORMED BY THE RAILROAD

Required.
Required.

☑ Not Required

Railroad Point of Contact:

Coordinate with TxDOT for any work to be performed by the Railroad Company. TxDOT must issue a work order for any work done by the Railroad Company prior to the work being performed.

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Escalated Limits				
Type of Insurance	Amount of Coverage (Minimum)			
Workers Compensation         \$500,000 / \$500,000 / \$500,				
Commercial General Liability	\$2,000,000 / \$4,000,000			
Business Automobile	\$2,000,000			

#### **Railroad Protective Liability Limits**

- Not Required
- \$2,000,000 / \$6,000,000 ☑ Non - Bridge/Typical Maintenance Projects. Includes repairs to overpass/underpass and culvert structures \$5,000,000 / \$10,000,000
- □ Bridge Structure Projects. Includes new construction or replacement of overpass/ underpass structures

Other:

Subdivision:

Initials:

# whatso ts use. its TXDOT 9 ard to by the **DISCLAIMER:** The use of this standard i TXDOT assumes no respoi

□ Not Required

BNSF:

To view previously approved CROE templates agreed upon between the State and Railroad, see: https://www.txdot.gov/business/resources/railroad-highway-crossing/sample-right-of-entryagreements.html

Approved CROE templates are not to be modified by the Contractor.

Contractor shall not operate within Railroad Right of Way without an executed Construction & Maintenance Agreement between the State and the Railroad and an executed CROE between the Contractor and the Railroad if required on project.

UPRR, BNSF, CPKCR will not accept on-track safety training certificates from other Railroads. Refer to each Railroad's specific contractor right of entry for training information.

Know and follow the Contractor's Right of Entry Agreement EXHIBIT D, MINIMUM SAFETY REQUIREMENTS regarding clothing, personal protective equipment, and general safety requirements.

**VIII. SUBCONTRACTORS** 

In Case of R Call: UPRR Railroad Em

> Location: DO **RR** Milepost

### V. CONTRACTOR'S RIGHT OF ENTRY (CROE)

- ☑ Required: UPRR Maintenance Consent Letter. TxDOT to assist
- □ Required: TxDOT to assist in obtaining the UPRR CROE
- □ Required: Contractor to obtain

- https://bnsf.railpermitting.com
- https://jllrpg.360works.com/fmi/webd/rpo_web_kcs.fmp12
- Other Railroads:

### VI. RAILROAD COORDINATION MEETING

A Railroad Coordination Meeting is required. See item 5, Article 8.1, of the Standard Specifications for Construction and Maintenance of Highways, Streets and Bridges Manual for more details.

### VII. RAILROAD SAFETY ORIENTATION

A. Complete the Railroad's course "Orientation for Contractor's Safety," and maintain registration prior to working on the Railroad's property. This course is required to be completed annually by Contractor and Subcontractor personnel working on site.

Contractor shall not subcontract work without written consent of TxDOT. Subcontractors are subject to the same insurance requirements as the Prime Contractor

### IX. EMERGENCY NOTIFICATION

Railroad Emergency
ergency Line at: 800-848-8715
DT DOT 748273N
21.963
Glidden



Texas Department of Transportation

Rail Division

FILE: rr-scope-of-work.pdf		dn: Tx	DN: TXDOT		CK: DW:		ск:	
© TxDOT	June 2014	CONT	SECT	JOB			HIGI	HWAY
	REVISIONS	0912	00	710		VARIOUS		IOUS
6/2023		DIST	COUNTY		5	SHEET NO.		
		HOU		HARRIS				118

□ This project is adjacent or parallel work, not within RR ROW: DOT No.: 748274V

Crossing Type: Overpass

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**DISCLAIMER:** The use of this stand TXDOT assumes no re

its

RR Company Operating Track at Crossing: <u>Union Pacific Railroad Company (UP)</u>

RR Company Owning Track at Crossing: UPRR

RR MP: 21.875

RR Subdivision: Glidden

City: Sugar Land

County: Fort Bend

CSJ at this Crossing: 0912-00-710

Latitude: 29°37'44.10"N Longitude: 95°35'30.60"W

Scope of Work, including any TCP, to be performed by State Contractor:

1) Pavement Markings

2) TCP(3-4)-13 3) Railroad and Contractor flaggers will coordinate with lane closures in vicinity of railroad. 4) All lanes across railroad tracks are to be open to traffic at the end of the day.

Scope of Work to be performed by Railroad Company:

N/A

#### II. FLAGGING & INSPECTION

No. of Days of Railroad Flagging Expected: 1

On this project, night or weekend flagging is:

Expected

Not Expected

Flagging services will be provided by:

□ Railroad Company: 1) Txdot will pay flagging invoices. Flagging Agreement with railroad will be needed or, 2) Permitted crossing. Railroad company to provide flagging.

☑ Outside Party: Contractor will pay flagging invoices to be reimbursed by TxDOT

Contractor must incorporate flaggers into anticipated construction schedule. The Railroad requires a 30-day notice if their flaggers are to be utilized. If Contractor falls behind schedule due to their own negligence and is not ready for scheduled flaggers, any flagging charges will be paid by Contractor.

Contact Information for Flagging:

☑ UPRR UP.info@railpros.com Call Center 877-315-0513, Select #1 for flagging UP.request@nrssinc.net Call Center 877-984-6777

- BNSF BNSFinfo@railprosfs.com Call Center 877-315-0513, Select #1 for flagging
- CPKCR KCS.info@railpros.com Call Center 877-315-0513, Select #1 for flagging Bottom Line On-Track Safety Services bottomline076@aol.com, 903-767-7630

OTHERS:

#### Contractor must incorporate railroad construction inspection into anticipated construction schedule.

☑ Not Required

□ Required. Contact Information for Construction Inspection:

#### III. CONSTRUCTION WORK TO BE PERFORMED BY THE RAILROAD

Required.
Required.

☑ Not Required

Railroad Point of Contact:

Coordinate with TxDOT for any work to be performed by the Railroad Company. TxDOT must issue a work order for any work done by the Railroad Company prior to the work being performed.

on behalf of the Railroad. Separate insurance policies and certificates are required when more

Escalated Limits				
Type of Insurance	Amount of Coverage (Minimum)			
Workers Compensation	\$500,000 / \$500,000 / \$500,000			
Commercial General Liability	\$2,000,000 / \$4,000,000			
Business Automobile	\$2,000,000			

#### **Railroad Protective Liability Limits**

- Not Required
- \$2,000,000 / \$6,000,000 ☑ Non - Bridge/Typical Maintenance Projects. Includes repairs to overpass/underpass and culvert structures \$5,000,000 / \$10,000,000
- □ Bridge Structure Projects. Includes new construction or replacement of overpass/ underpass structures

Other:

□ Not Required

BNSF:

To view previously approved CROE templates agreed upon between the State and Railroad, see: https://www.txdot.gov/business/resources/railroad-highway-crossing/sample-right-of-entryagreements.html

Approved CROE templates are not to be modified by the Contractor.

Contractor shall not operate within Railroad Right of Way without an executed Construction & Maintenance Agreement between the State and the Railroad and an executed CROE between the Contractor and the Railroad if required on project.

Know and follow the Contractor's Right of Entry Agreement EXHIBIT D, MINIMUM SAFETY REQUIREMENTS regarding clothing, personal protective equipment, and general safety requirements.

### **VIII. SUBCONTRACTORS**

# In Case of R

Call: UPRR Railroad Em Location: DO

**RR** Milepost Subdivision

Initials:

nc	qui	icu.	

#### IV. RAILROAD INSURANCE REQUIREMENTS

The Contractor shall confirm the insurance requirements with the Railroad as the insurance limits are subject to change without notice.

Insurance policies and corresponding certificates of insurance must be issued by the contractor than one Railroad Company is operating on the same right of way, or when several Railroad Companies are involved and operate on their own separate right of ways.

No direct compensation will be made to the Contractor for providing the insurance coverages shown below or any deductibles. These costs are incidental to the various bid items.

### V. CONTRACTOR'S RIGHT OF ENTRY (CROE)

- ☑ Required: UPRR Maintenance Consent Letter. TxDOT to assist
- □ Required: TxDOT to assist in obtaining the UPRR CROE
- □ Required: Contractor to obtain

- https://bnsf.railpermitting.com
- https://jllrpg.360works.com/fmi/webd/rpo_web_kcs.fmp12
- Other Railroads:

### VI. RAILROAD COORDINATION MEETING

A Railroad Coordination Meeting is required. See item 5, Article 8.1, of the Standard Specifications for Construction and Maintenance of Highways, Streets and Bridges Manual for more details.

### VII. RAILROAD SAFETY ORIENTATION


A. Complete the Railroad's course "Orientation for Contractor's Safety," and maintain registration prior to working on the Railroad's property. This course is required to be completed annually by Contractor and Subcontractor personnel working on site.

UPRR, BNSF, CPKCR will not accept on-track safety training certificates from other Railroads. Refer to each Railroad's specific contractor right of entry for training information.

Contractor shall not subcontract work without written consent of TxDOT. Subcontractors are subject to the same insurance requirements as the Prime Contractor

### IX. EMERGENCY NOTIFICATION

Railroad Emergency
ergency Line at:800-848-8715
DOT 748274V
21.875
Glidden

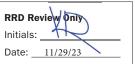

Texas Department of Transportation

Rail Division

FILE: rr-scop	e-of-work.pdf	dn: Tx	DOT	СК:	DW:			CK:
© TxDOT	June 2014	CONT	SECT	JOB		1	HIGH	WAY
	REVISIONS	0912	00	710		VARIOUS		OUS
6/2023		DIST	COUNTY		s	HEET NO.		
		HOU		HARRIS	;			119

□ This project is adjacent or parallel work, not within RR ROW: DOT No.: 743695P

Crossing Type: At-Grade

RR Company Operating Track at Crossing: <u>Union Pacific Railroad Company (UP)</u>

RR Company Owning Track at Crossing: UPRR

RR MP: 21.321

RR Subdivision: Glidden

City: Stafford

County: Fort Bend

CSJ at this Crossing: 0912-00-710

Latitude: 29°37'40.20"N Longitude: 95°34'57.20"W

Scope of Work, including any TCP, to be performed by State Contractor:

1) Pavement Markings

2) TCP(3-4)-13

3) Railroad and Contractor flaggers will coordinate with lane closures in vicinity of railroad. 4) All lanes across railroad tracks are to be open to traffic at the end of the day.

Scope of Work to be performed by Railroad Company:

N/A

#### II. FLAGGING & INSPECTION

No. of Days of Railroad Flagging Expected: 1

On this project, night or weekend flagging is:

Expected

Not Expected

Flagging services will be provided by:

□ Railroad Company: 1) Txdot will pay flagging invoices. Flagging Agreement with railroad will be needed or, 2) Permitted crossing. Railroad company to provide flagging.

☑ Outside Party: Contractor will pay flagging invoices to be reimbursed by TxDOT

Contractor must incorporate flaggers into anticipated construction schedule. The Railroad requires a 30-day notice if their flaggers are to be utilized. If Contractor falls behind schedule due to their own negligence and is not ready for scheduled flaggers, any flagging charges will be paid by Contractor.

Contact Information for Flagging:

☑ UPRR UP.info@railpros.com Call Center 877-315-0513, Select #1 for flagging UP.request@nrssinc.net Call Center 877-984-6777

- BNSF BNSFinfo@railprosfs.com Call Center 877-315-0513, Select #1 for flagging
- CPKCR KCS.info@railpros.com Call Center 877-315-0513, Select #1 for flagging Bottom Line On-Track Safety Services bottomline076@aol.com, 903-767-7630

OTHERS:

#### Contractor must incorporate railroad construction inspection into anticipated construction schedule.

☑ Not Required

□ Required. Contact Information for Construction Inspection:

#### III. CONSTRUCTION WORK TO BE PERFORMED BY THE RAILROAD

Required.	
Required.	

☑ Not Required

Railroad Point of Contact:

Coordinate with TxDOT for any work to be performed by the Railroad Company. TxDOT must issue a work order for any work done by the Railroad Company prior to the work being performed.

#### IV. RAILROAD INSURANCE REQUIREMENTS

The Contractor shall confirm the insurance requirements with the Railroad as the insurance limits are subject to change without notice.

Insurance policies and corresponding certificates of insurance must be issued by the contractor on behalf of the Railroad. Separate insurance policies and certificates are required when more than one Railroad Company is operating on the same right of way, or when several Railroad Companies are involved and operate on their own separate right of ways.

No direct compensation will be made to the Contractor for providing the insurance coverages shown below or any deductibles. These costs are incidental to the various bid items.

Escalated Limits				
Type of Insurance	Amount of Coverage (Minimum)			
Workers Compensation	\$500,000 / \$500,000 / \$500,000			
Commercial General Liability	\$2,000,000 / \$4,000,000			
Business Automobile	\$2,000,000			

#### **Railroad Protective Liability Limits**

- Not Required
- \$2,000,000 / \$6,000,000 ☑ Non - Bridge/Typical Maintenance Projects. Includes repairs to overpass/underpass and culvert structures
- □ Bridge Structure Projects. Includes new construction or replacement of overpass/ underpass structures

Other:

Initials:

□ Not Required

BNSF:

To view previously approved CROE templates agreed upon between the State and Railroad, see: https://www.txdot.gov/business/resources/railroad-highway-crossing/sample-right-of-entryagreements.html

Approved CROE templates are not to be modified by the Contractor.

Contractor shall not operate within Railroad Right of Way without an executed Construction & Maintenance Agreement between the State and the Railroad and an executed CROE between the Contractor and the Railroad if required on project.

### VII. RAILROAD SAFETY ORIENTATION

UPRR, BNSF, CPKCR will not accept on-track safety training certificates from other Railroads. Refer to each Railroad's specific contractor right of entry for training information.

Know and follow the Contractor's Right of Entry Agreement EXHIBIT D, MINIMUM SAFETY REQUIREMENTS regarding clothing, personal protective equipment, and general safety requirements.

**VIII. SUBCONTRACTORS** 

# In Case of R

Call: UPRR Railroad Em Location: DO

**RR** Milepost Subdivision

\$5,000,000 / \$10,000,000

### V. CONTRACTOR'S RIGHT OF ENTRY (CROE)

- ☑ Required: UPRR Maintenance Consent Letter. TxDOT to assist
- □ Required: TxDOT to assist in obtaining the UPRR CROE
- □ Required: Contractor to obtain

- https://bnsf.railpermitting.com
- https://jllrpg.360works.com/fmi/webd/rpo_web_kcs.fmp12
- Other Railroads:

### VI. RAILROAD COORDINATION MEETING


A Railroad Coordination Meeting is required. See item 5, Article 8.1, of the Standard Specifications for Construction and Maintenance of Highways, Streets and Bridges Manual for more details.

A. Complete the Railroad's course "Orientation for Contractor's Safety," and maintain registration prior to working on the Railroad's property. This course is required to be completed annually by Contractor and Subcontractor personnel working on site.

Contractor shall not subcontract work without written consent of TxDOT. Subcontractors are subject to the same insurance requirements as the Prime Contractor

### IX. EMERGENCY NOTIFICATION

ailroad Emergency
ergency Line at: 800-848-8715
DT DOT 743695P
21.321
Glidden

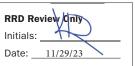

Texas Department of Transportation

Rail Division

FILE: rr-scope-of-work.pdf		dn: Tx	DN: TXDOT		CK: DW:		: СК:	
© TxDOT	June 2014	CONT	SECT	JOB			HIG	HWAY
	REVISIONS	0912	00	710		VARIOUS		IOUS
6/2023		DIST	COUNTY		:	SHEET NO.		
		HOU		HARRIS	;			120

□ This project is adjacent or parallel work, not within RR ROW: DOT No.: 412514U

Crossing Type: At-Grade

RR Company Operating Track at Crossing: <u>Union Pacific Railroad Company (UP)</u>

RR Company Owning Track at Crossing: UPRR

RR MP: 20.485

RR Subdivision: Glidden

City: Stafford

County: Fort Bend

CSJ at this Crossing: 0912-00-710

Latitude: 29°37'19.90"N Longitude: 95°34'13.10"W

Scope of Work, including any TCP, to be performed by State Contractor:

1) Pavement Markings

2) TCP(3-4)-13 3) Railroad and Contractor flaggers will coordinate with lane closures in vicinity of railroad. 4) All lanes across railroad tracks are to be open to traffic at the end of the day.

Scope of Work to be performed by Railroad Company:

N/A

#### II. FLAGGING & INSPECTION

No. of Days of Railroad Flagging Expected: 1

On this project, night or weekend flagging is:

Expected

Not Expected

Flagging services will be provided by:

□ Railroad Company: 1) Txdot will pay flagging invoices. Flagging Agreement with railroad will be needed or, 2) Permitted crossing. Railroad company to provide flagging.

☑ Outside Party: Contractor will pay flagging invoices to be reimbursed by TxDOT

Contractor must incorporate flaggers into anticipated construction schedule. The Railroad requires a 30-day notice if their flaggers are to be utilized. If Contractor falls behind schedule due to their own negligence and is not ready for scheduled flaggers, any flagging charges will be paid by Contractor.

Contact Information for Flagging:

☑ UPRR UP.info@railpros.com Call Center 877-315-0513, Select #1 for flagging UP.request@nrssinc.net Call Center 877-984-6777

- BNSF BNSFinfo@railprosfs.com Call Center 877-315-0513, Select #1 for flagging
- CPKCR KCS.info@railpros.com Call Center 877-315-0513, Select #1 for flagging Bottom Line On-Track Safety Services bottomline076@aol.com, 903-767-7630

OTHERS:

#### Contractor must incorporate railroad construction inspection into anticipated construction schedule.

☑ Not Required

□ Required. Contact Information for Construction Inspection:

#### III. CONSTRUCTION WORK TO BE PERFORMED BY THE RAILROAD

Required.
Required.

☑ Not Required

Railroad Point of Contact:

Coordinate with TxDOT for any work to be performed by the Railroad Company. TxDOT must issue a work order for any work done by the Railroad Company prior to the work being performed.

#### IV. RAILROAD INSURANCE REQUIREMENTS

The Contractor shall confirm the insurance requirements with the Railroad as the insurance limits are subject to change without notice.

Insurance policies and corresponding certificates of insurance must be issued by the contractor on behalf of the Railroad. Separate insurance policies and certificates are required when more than one Railroad Company is operating on the same right of way, or when several Railroad Companies are involved and operate on their own separate right of ways.

No direct compensation will be made to the Contractor for providing the insurance coverages shown below or any deductibles. These costs are incidental to the various bid items.

Escalated Limits			
Type of Insurance	Amount of Coverage (Minimum)		
Workers Compensation	\$500,000 / \$500,000 / \$500,000		
Commercial General Liability	\$2,000,000 / \$4,000,000		
Business Automobile	\$2,000,000		

#### **Railroad Protective Liability Limits**

- Not Required
- \$2,000,000 / \$6,000,000 ☑ Non - Bridge/Typical Maintenance Projects. Includes repairs to overpass/underpass and culvert structures \$5,000,000 / \$10,000,000 □ Bridge Structure Projects. Includes new
- construction or replacement of overpass/ underpass structures

Other:

□ Not Required

BNSF:

To view previously approved CROE templates agreed upon between the State and Railroad, see: https://www.txdot.gov/business/resources/railroad-highway-crossing/sample-right-of-entryagreements.html

Approved CROE templates are not to be modified by the Contractor.

Contractor shall not operate within Railroad Right of Way without an executed Construction & Maintenance Agreement between the State and the Railroad and an executed CROE between the Contractor and the Railroad if required on project.

Know and follow the Contractor's Right of Entry Agreement EXHIBIT D, MINIMUM SAFETY REQUIREMENTS regarding clothing, personal protective equipment, and general safety requirements.

### **VIII. SUBCONTRACTORS**

# In Case of R

Call: UPRR Railroad Em Location: DO

**RR** Milepost Subdivision:

Initials:

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### V. CONTRACTOR'S RIGHT OF ENTRY (CROE)

- ☑ Required: UPRR Maintenance Consent Letter. TxDOT to assist
- □ Required: TxDOT to assist in obtaining the UPRR CROE
- □ Required: Contractor to obtain

- https://bnsf.railpermitting.com
- https://jllrpg.360works.com/fmi/webd/rpo_web_kcs.fmp12
- Other Railroads:

### VI. RAILROAD COORDINATION MEETING

A Railroad Coordination Meeting is required. See item 5, Article 8.1, of the Standard Specifications for Construction and Maintenance of Highways, Streets and Bridges Manual for more details.

### VII. RAILROAD SAFETY ORIENTATION

A. Complete the Railroad's course "Orientation for Contractor's Safety," and maintain registration prior to working on the Railroad's property. This course is required to be completed annually by Contractor and Subcontractor personnel working on site.

UPRR, BNSF, CPKCR will not accept on-track safety training certificates from other Railroads. Refer to each Railroad's specific contractor right of entry for training information.

Contractor shall not subcontract work without written consent of TxDOT. Subcontractors are subject to the same insurance requirements as the Prime Contractor

### IX. EMERGENCY NOTIFICATION

Railroad Emergency
ergency Line at: 800-848-8715 0T DOT 412514U
20.485
Glidden



Texas Department of Transportation

Rail Division

FILE: rr-scope-of-work.pdf		dn: Tx	DOT	ск:	DW:		CK:	
© TxDOT	June 2014	CONT	SECT	JOB		HIGHWAY		AY
0/0000	REVISIONS	0912	00	710		VARIOUS SHEET NO		JS
6/2023		DIST		COUNTY				ET NO.
		HOU		HARRIS			1	21

□ This project is adjacent or parallel work, not within RR ROW: DOT No.: 924009P

Crossing Type: At-Grade

RR Company Operating Track at Crossing: <u>Union Pacific Railroad Company (UP)</u>

RR Company Owning Track at Crossing: UPRR

RR MP: 20.136

RR Subdivision: Glidden

City: Stafford

County: Fort Bend

CSJ at this Crossing: 0912-00-710

Latitude: 29°37'11.90"N Longitude: 95°33'54.00"W

Scope of Work, including any TCP, to be performed by State Contractor:

1) Pavement Markings 2) TCP(3-4)-13

3) Railroad and Contractor flaggers will coordinate with lane closures in vicinity of railroad. 4) All lanes across railroad tracks are to be open to traffic at the end of the day.

Scope of Work to be performed by Railroad Company:

N/A

#### II. FLAGGING & INSPECTION

No. of Days of Railroad Flagging Expected: 1

On this project, night or weekend flagging is:

Expected

Not Expected

Flagging services will be provided by:

□ Railroad Company: 1) Txdot will pay flagging invoices. Flagging Agreement with railroad will be needed or, 2) Permitted crossing. Railroad company to provide flagging.

☑ Outside Party: Contractor will pay flagging invoices to be reimbursed by TxDOT

Contractor must incorporate flaggers into anticipated construction schedule. The Railroad requires a 30-day notice if their flaggers are to be utilized. If Contractor falls behind schedule due to their own negligence and is not ready for scheduled flaggers, any flagging charges will be paid by Contractor.

Contact Information for Flagging:

☑ UPRR UP.info@railpros.com Call Center 877-315-0513, Select #1 for flagging UP.request@nrssinc.net Call Center 877-984-6777

- BNSF BNSFinfo@railprosfs.com Call Center 877-315-0513, Select #1 for flagging
- CPKCR KCS.info@railpros.com Call Center 877-315-0513, Select #1 for flagging Bottom Line On-Track Safety Services bottomline076@aol.com, 903-767-7630

OTHERS:

#### Contractor must incorporate railroad construction inspection into anticipated construction schedule.

☑ Not Required

□ Required. Contact Information for Construction Inspection:

#### III. CONSTRUCTION WORK TO BE PERFORMED BY THE RAILROAD

Reauired.
neguneu.

☑ Not Required

Railroad Point of Contact:

Coordinate with TxDOT for any work to be performed by the Railroad Company. TxDOT must issue a work order for any work done by the Railroad Company prior to the work being performed.

#### IV. RAILROAD INSURANCE REQUIREMENTS

The Contractor shall confirm the insurance requirements with the Railroad as the insurance limits are subject to change without notice.

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No direct compensation will be made to the Contractor for providing the insurance coverages shown below or any deductibles. These costs are incidental to the various bid items.

Escalated Limits			
Type of Insurance	Amount of Coverage (Minimum)		
Workers Compensation	\$500,000 / \$500,000 / \$500,000		
Commercial General Liability	\$2,000,000 / \$4,000,000		
Business Automobile	\$2,000,000		

#### **Railroad Protective Liability Limits**

- Not Required
- \$2,000,000 / \$6,000,000 ☑ Non - Bridge/Typical Maintenance Projects. Includes repairs to overpass/underpass and culvert structures \$5,000,000 / \$10,000,000
- □ Bridge Structure Projects. Includes new construction or replacement of overpass/ underpass structures

Other:

Railroad Em **RR** Milepost

Initials:

hatsc use. its TXDOT 9 ard to by the **DISCLAIMER:** The use of this st TxDOT assumes r

□ Not Required

BNSF:

To view previously approved CROE templates agreed upon between the State and Railroad, see: https://www.txdot.gov/business/resources/railroad-highway-crossing/sample-right-of-entryagreements.html

Approved CROE templates are not to be modified by the Contractor.

Contractor shall not operate within Railroad Right of Way without an executed Construction & Maintenance Agreement between the State and the Railroad and an executed CROE between the Contractor and the Railroad if required on project.

### VII. RAILROAD SAFETY ORIENTATION

UPRR, BNSF, CPKCR will not accept on-track safety training certificates from other Railroads. Refer to each Railroad's specific contractor right of entry for training information.

Know and follow the Contractor's Right of Entry Agreement EXHIBIT D, MINIMUM SAFETY REQUIREMENTS regarding clothing, personal protective equipment, and general safety requirements.

**VIII. SUBCONTRACTORS** 

In Case of R Call: UPRR

Location: DO

Subdivision:

### V. CONTRACTOR'S RIGHT OF ENTRY (CROE)

- ☑ Required: UPRR Maintenance Consent Letter. TxDOT to assist
- □ Required: TxDOT to assist in obtaining the UPRR CROE
- □ Required: Contractor to obtain

- https://bnsf.railpermitting.com
- https://jllrpg.360works.com/fmi/webd/rpo_web_kcs.fmp12
- Other Railroads:

### VI. RAILROAD COORDINATION MEETING


A Railroad Coordination Meeting is required. See item 5, Article 8.1, of the Standard Specifications for Construction and Maintenance of Highways, Streets and Bridges Manual for more details.

A. Complete the Railroad's course "Orientation for Contractor's Safety," and maintain registration prior to working on the Railroad's property. This course is required to be completed annually by Contractor and Subcontractor personnel working on site.

Contractor shall not subcontract work without written consent of TxDOT. Subcontractors are subject to the same insurance requirements as the Prime Contractor

### IX. EMERGENCY NOTIFICATION

ailroad Emergency	
ergency Line at: <u>800-848-8715</u>	
DOT 924009P	
20.136	
Glidden	

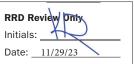

Texas Department of Transportation

Rail Division

FILE: rr-scope-of-work.pdf		dn: Tx	DOT	СК:	DW:	СК:	
© TxDOT	June 2014	CONT	SECT	JOB		HIGHWAY	
	REVISIONS	0912	00	710		VARIOUS	
6/2023		DIST		COUNTY		SHEET N	
		HOU		HARRIS	;		122

□ This project is adjacent or parallel work, not within RR ROW: DOT No.: 924008H

Crossing Type: At-Grade

RR Company Operating Track at Crossing: <u>Union Pacific Railroad Company (UP)</u>

RR Company Owning Track at Crossing: UPRR

RR MP: 20.088

RR Subdivision: Glidden

City: Stafford

County: Fort Bend

CSJ at this Crossing: 0912-00-710

Latitude: 29°37'10.70"N Longitude: 95°33'51.50"W

Scope of Work, including any TCP, to be performed by State Contractor:

1) Pavement Markings

2) TCP(3-4)-13

3) Railroad and Contractor flaggers will coordinate with lane closures in vicinity of railroad. 4) All lanes across railroad tracks are to be open to traffic at the end of the day.

Scope of Work to be performed by Railroad Company:

N/A

#### II. FLAGGING & INSPECTION

No. of Days of Railroad Flagging Expected: 1

On this project, night or weekend flagging is:

Expected

Not Expected

Flagging services will be provided by:

□ Railroad Company: 1) Txdot will pay flagging invoices. Flagging Agreement with railroad will be needed or, 2) Permitted crossing. Railroad company to provide flagging.

☑ Outside Party: Contractor will pay flagging invoices to be reimbursed by TxDOT

Contractor must incorporate flaggers into anticipated construction schedule. The Railroad requires a 30-day notice if their flaggers are to be utilized. If Contractor falls behind schedule due to their own negligence and is not ready for scheduled flaggers, any flagging charges will be paid by Contractor.

Contact Information for Flagging:

☑ UPRR UP.info@railpros.com Call Center 877-315-0513, Select #1 for flagging UP.request@nrssinc.net Call Center 877-984-6777

- BNSF BNSFinfo@railprosfs.com Call Center 877-315-0513, Select #1 for flagging
- CPKCR KCS.info@railpros.com Call Center 877-315-0513, Select #1 for flagging Bottom Line On-Track Safety Services bottomline076@aol.com, 903-767-7630

OTHERS:

#### Contractor must incorporate railroad construction inspection into anticipated construction schedule.

☑ Not Required

□ Required. Contact Information for Construction Inspection:

#### III. CONSTRUCTION WORK TO BE PERFORMED BY THE RAILROAD

Required.	
Required.	

☑ Not Required

Railroad Point of Contact:

Coordinate with TxDOT for any work to be performed by the Railroad Company. TxDOT must issue a work order for any work done by the Railroad Company prior to the work being performed.

#### IV. RAILROAD INSURANCE REQUIREMENTS

The Contractor shall confirm the insurance requirements with the Railroad as the insurance limits are subject to change without notice.

Insurance policies and corresponding certificates of insurance must be issued by the contractor on behalf of the Railroad. Separate insurance policies and certificates are required when more than one Railroad Company is operating on the same right of way, or when several Railroad Companies are involved and operate on their own separate right of ways.

No direct compensation will be made to the Contractor for providing the insurance coverages shown below or any deductibles. These costs are incidental to the various bid items.

Escalated Limits				
Type of Insurance	Amount of Coverage (Minimum)			
Workers Compensation	\$500,000 / \$500,000 / \$500,000			
Commercial General Liability	\$2,000,000 / \$4,000,000			
Business Automobile	\$2,000,000			

#### **Railroad Protective Liability Limits**

- Not Required
- \$2,000,000 / \$6,000,000 ☑ Non - Bridge/Typical Maintenance Projects. Includes repairs to overpass/underpass and culvert structures \$5,000,000 / \$10,000,000
- □ Bridge Structure Projects. Includes new construction or replacement of overpass/ underpass structures

Other:

Initials:

□ Not Required

BNSF:

To view previously approved CROE templates agreed upon between the State and Railroad, see: https://www.txdot.gov/business/resources/railroad-highway-crossing/sample-right-of-entryagreements.html

Approved CROE templates are not to be modified by the Contractor.

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### **VIII. SUBCONTRACTORS**

In Case of R Call: UPRR Railroad Em Location: DO

**RR** Milepost Subdivision:

### V. CONTRACTOR'S RIGHT OF ENTRY (CROE)

- ☑ Required: UPRR Maintenance Consent Letter. TxDOT to assist
- □ Required: TxDOT to assist in obtaining the UPRR CROE
- □ Required: Contractor to obtain

- https://bnsf.railpermitting.com
- https://jllrpg.360works.com/fmi/webd/rpo_web_kcs.fmp12
- Other Railroads:

### VI. RAILROAD COORDINATION MEETING


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### IX. EMERGENCY NOTIFICATION

ailroad Emergency
ergency Line at: 800-848-8715
DT DOT 924008H
20.088
Glidden



Texas Department of Transportation

Rail Division

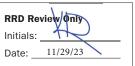FILE: rr-scope-of-work.pdf		dn: Tx	DOT	СК:	DW:		CK:	
© TxDOT	June 2014	CONT	SECT	JOB		HIGHWAY		HWAY
	REVISIONS	0912	00	710		VARIOUS		IOUS
6/2023		DIST		COUNTY		SHEET		HEET NO.
		HOU		HARRIS				123

□ This project is adjacent or parallel work, not within RR ROW: DOT No.: 924007B

Crossing Type: At-Grade

RR Company Operating Track at Crossing: <u>Union Pacific Railroad Company (UP)</u>

RR Company Owning Track at Crossing: UPRR

RR MP: 19.594

RR Subdivision: Glidden

City: Stafford

County: Fort Bend

CSJ at this Crossing: 0912-00-710

Latitude: 29°36'59.40"N Longitude: 95°33'25.40"W

Scope of Work, including any TCP, to be performed by State Contractor:

1) Pavement Markings

2) TCP(3-4)-13 3) Railroad and Contractor flaggers will coordinate with lane closures in vicinity of railroad. 4) All lanes across railroad tracks are to be open to traffic at the end of the day.

Scope of Work to be performed by Railroad Company:

N/A

#### II. FLAGGING & INSPECTION

No. of Days of Railroad Flagging Expected: 1

On this project, night or weekend flagging is:

Expected

Not Expected

Flagging services will be provided by:

□ Railroad Company: 1) Txdot will pay flagging invoices. Flagging Agreement with railroad will be needed or, 2) Permitted crossing. Railroad company to provide flagging.

☑ Outside Party: Contractor will pay flagging invoices to be reimbursed by TxDOT

Contractor must incorporate flaggers into anticipated construction schedule. The Railroad requires a 30-day notice if their flaggers are to be utilized. If Contractor falls behind schedule due to their own negligence and is not ready for scheduled flaggers, any flagging charges will be paid by Contractor.

Contact Information for Flagging:

☑ UPRR UP.info@railpros.com Call Center 877-315-0513, Select #1 for flagging UP.request@nrssinc.net Call Center 877-984-6777

- BNSF BNSFinfo@railprosfs.com Call Center 877-315-0513, Select #1 for flagging
- CPKCR KCS.info@railpros.com Call Center 877-315-0513, Select #1 for flagging Bottom Line On-Track Safety Services bottomline076@aol.com, 903-767-7630

OTHERS:

#### Contractor must incorporate railroad construction inspection into anticipated construction schedule.

☑ Not Required

□ Required. Contact Information for Construction Inspection:

#### III. CONSTRUCTION WORK TO BE PERFORMED BY THE RAILROAD

Reauired.
neguneu.

☑ Not Required

Railroad Point of Contact:

Coordinate with TxDOT for any work to be performed by the Railroad Company. TxDOT must issue a work order for any work done by the Railroad Company prior to the work being performed.

#### IV. RAILROAD INSURANCE REQUIREMENTS

The Contractor shall confirm the insurance requirements with the Railroad as the insurance limits are subject to change without notice.

Insurance policies and corresponding certificates of insurance must be issued by the contractor on behalf of the Railroad. Separate insurance policies and certificates are required when more than one Railroad Company is operating on the same right of way, or when several Railroad Companies are involved and operate on their own separate right of ways.

No direct compensation will be made to the Contractor for providing the insurance coverages shown below or any deductibles. These costs are incidental to the various bid items.

	Escalated Limits
Type of Insurance	Amount of Coverage (Minimum)
Workers Compensation	\$500,000 / \$500,000 / \$500,000
Commercial General Liability	\$2,000,000 / \$4,000,000
Business Automobile	\$2,000,000

#### **Railroad Protective Liability Limits**

- Not Required
- \$2,000,000 / \$6,000,000 ☑ Non - Bridge/Typical Maintenance Projects. Includes repairs to overpass/underpass and culvert structures \$5,000,000 / \$10,000,000
- □ Bridge Structure Projects. Includes new construction or replacement of overpass/ underpass structures

Other:

Initials:

### V. CONTRACTOR'S RIGHT OF ENTRY (CROE)

□ Not Required

- ☑ Required: UPRR Maintenance Consent Letter. TxDOT to assist
- □ Required: TxDOT to assist in obtaining the UPRR CROE
- □ Required: Contractor to obtain

#### BNSF:

- https://bnsf.railpermitting.com
- https://jllrpg.360works.com/fmi/webd/rpo_web_kcs.fmp12
- Other Railroads:

To view previously approved CROE templates agreed upon between the State and Railroad, see: https://www.txdot.gov/business/resources/railroad-highway-crossing/sample-right-of-entryagreements.html

Approved CROE templates are not to be modified by the Contractor.

Contractor shall not operate within Railroad Right of Way without an executed Construction & Maintenance Agreement between the State and the Railroad and an executed CROE between the Contractor and the Railroad if required on project.

### VI. RAILROAD COORDINATION MEETING

A Railroad Coordination Meeting is required. See item 5, Article 8.1, of the Standard Specifications for Construction and Maintenance of Highways, Streets and Bridges Manual for more details.

### VII. RAILROAD SAFETY ORIENTATION

A. Complete the Railroad's course "Orientation for Contractor's Safety," and maintain registration prior to working on the Railroad's property. This course is required to be completed annually by Contractor and Subcontractor personnel working on site.

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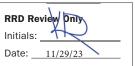
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### **VIII. SUBCONTRACTORS**

Contractor shall not subcontract work without written consent of TxDOT. Subcontractors are subject to the same insurance requirements as the Prime Contractor

### IX. EMERGENCY NOTIFICATION

In Case of Railroad Emergency Call: UPRR
Railroad Emergency Line at: 800-848-8715 Location: DOT 00T 924007B
RR Milepost: 19.594
Subdivision: Glidden



Texas Department of Transportation

Rail Division

FILE: rr-scop	LE: rr-scope-of-work.pdf		E: rr-scope-of-work.pdf		DOT	СК:	DW:		ск:	
© TxDOT	June 2014	CONT	SECT	JOB		HIGHW		HWAY		
0/0000	REVISIONS	0912	00	710		VARIOUS		IOUS		
6/2023		DIST		COUNTY		SHEET		SHEET NO.		
		HOU		HARRIS	;			124		

□ This project is adjacent or parallel work, not within RR ROW: DOT No.: 924006U

Crossing Type: At-Grade

RR Company Operating Track at Crossing: <u>Union Pacific Railroad Company (UP)</u>

RR Company Owning Track at Crossing: UPRR

RR MP: 19.570

RR Subdivision: Glidden

City: Stafford

County: Fort Bend

CSJ at this Crossing: 0912-00-710

Latitude: 29°36'59.00"N Longitude: 95°33'24.20"W

Scope of Work, including any TCP, to be performed by State Contractor:

1) Pavement Markings

2) TCP(3-4)-13

3) Railroad and Contractor flaggers will coordinate with lane closures in vicinity of railroad. 4) All lanes across railroad tracks are to be open to traffic at the end of the day.

Scope of Work to be performed by Railroad Company:

N/A

#### II. FLAGGING & INSPECTION

No. of Days of Railroad Flagging Expected: 1

On this project, night or weekend flagging is:

Expected

Not Expected

Flagging services will be provided by:

□ Railroad Company: 1) Txdot will pay flagging invoices. Flagging Agreement with railroad will be needed or, 2) Permitted crossing. Railroad company to provide flagging.

☑ Outside Party: Contractor will pay flagging invoices to be reimbursed by TxDOT

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Contact Information for Flagging:

☑ UPRR UP.info@railpros.com Call Center 877-315-0513, Select #1 for flagging UP.request@nrssinc.net Call Center 877-984-6777

- BNSF BNSFinfo@railprosfs.com Call Center 877-315-0513, Select #1 for flagging
- CPKCR KCS.info@railpros.com Call Center 877-315-0513, Select #1 for flagging Bottom Line On-Track Safety Services bottomline076@aol.com, 903-767-7630

OTHERS:

#### Contractor must incorporate railroad construction inspection into anticipated construction schedule.

☑ Not Required

□ Required. Contact Information for Construction Inspection:

#### III. CONSTRUCTION WORK TO BE PERFORMED BY THE RAILROAD

Required.
Regulieu.

☑ Not Required

Railroad Point of Contact:

Coordinate with TxDOT for any work to be performed by the Railroad Company. TxDOT must issue a work order for any work done by the Railroad Company prior to the work being performed.

#### IV. RAILROAD INSURANCE REQUIREMENTS

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	Escalated Limits
Type of Insurance	Amount of Coverage (Minimum)
Workers Compensation	\$500,000 / \$500,000 / \$500,000
Commercial General Liability	\$2,000,000 / \$4,000,000
Business Automobile	\$2,000,000

#### **Railroad Protective Liability Limits**

- Not Required
- \$2,000,000 / \$6,000,000 ☑ Non - Bridge/Typical Maintenance Projects. Includes repairs to overpass/underpass and culvert structures \$5,000,000 / \$10,000,000
- construction or replacement of overpass/ underpass structures

Railroad Em Location: DO **RR** Milepost

Initials:

whatso ts use. its TXDOT 9 ard to by the **DISCLAIMER:** The use of this standard i TXDOT assumes no respoi

□ Not Required

BNSF:

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Know and follow the Contractor's Right of Entry Agreement EXHIBIT D, MINIMUM SAFETY REQUIREMENTS regarding clothing, personal protective equipment, and general safety requirements.

**VIII. SUBCONTRACTORS** 

Contractor shall not subcontract work without written consent of TxDOT. Subcontractors are subject to the same insurance requirements as the Prime Contractor

In Case of R Call: UPRR

Subdivision:

□ Bridge Structure Projects. Includes new

Other:

### V. CONTRACTOR'S RIGHT OF ENTRY (CROE)

- ☑ Required: UPRR Maintenance Consent Letter. TxDOT to assist
- □ Required: TxDOT to assist in obtaining the UPRR CROE
- □ Required: Contractor to obtain

- https://bnsf.railpermitting.com
- https://jllrpg.360works.com/fmi/webd/rpo_web_kcs.fmp12
- Other Railroads:


### VI. RAILROAD COORDINATION MEETING

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### IX. EMERGENCY NOTIFICATION

ailroad Emergency
ergency Line at: 800-848-8715
DOT 924006U
19.570
Glidden



Texas Department of Transportation

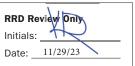Rail Division

FILE: rr-scope-of-work.pdf		dn: Tx	DOT	СК:	DW:		ск:	
© TxDOT	June 2014	CONT	SECT	JOB	ню		HIGHWAY	
6/2022	REVISIONS	0912	00	710		VARIOUS		IOUS
6/2023		DIST		COUNTY		SHEE		HEET NO.
		HOU		HARRIS				125

□ This project is adjacent or parallel work, not within RR ROW: DOT No.: 743689L

Crossing Type: At-Grade

RR Company Operating Track at Crossing: <u>Union Pacific Railroad Company (UP)</u>

RR Company Owning Track at Crossing: UPRR

RR MP: 18.430

RR Subdivision: Glidden

City: Missouri City

County: Fort Bend

CSJ at this Crossing: 0912-00-710

Latitude: 29°37'08.60"N Longitude: 95°32'19.00"W

Scope of Work, including any TCP, to be performed by State Contractor:

1) Pavement Markings

2) TCP(3-4)-13

3) Railroad and Contractor flaggers will coordinate with lane closures in vicinity of railroad. 4) All lanes across railroad tracks are to be open to traffic at the end of the day.

Scope of Work to be performed by Railroad Company:

N/A

#### II. FLAGGING & INSPECTION

No. of Days of Railroad Flagging Expected: 1

On this project, night or weekend flagging is:

Expected

Not Expected

Flagging services will be provided by:

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- BNSF BNSFinfo@railprosfs.com Call Center 877-315-0513, Select #1 for flagging
- CPKCR KCS.info@railpros.com Call Center 877-315-0513, Select #1 for flagging Bottom Line On-Track Safety Services bottomline076@aol.com, 903-767-7630

OTHERS:

#### Contractor must incorporate railroad construction inspection into anticipated construction schedule.

☑ Not Required

□ Required. Contact Information for Construction Inspection:

#### III. CONSTRUCTION WORK TO BE PERFORMED BY THE RAILROAD

Required.	

☑ Not Required

Railroad Point of Contact:

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Business Automobile	\$2,000,000

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- □ Bridge Structure Projects. Includes new construction or replacement of overpass/ underpass structures

Other:

Call: UPRR Railroad Em Location: DO **RR** Milepost

Initials:

□ Not Required

BNSF:

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**VIII. SUBCONTRACTORS** 

In Case of R

Subdivision:

### V. CONTRACTOR'S RIGHT OF ENTRY (CROE)

- ☑ Required: UPRR Maintenance Consent Letter. TxDOT to assist
- □ Required: TxDOT to assist in obtaining the UPRR CROE
- □ Required: Contractor to obtain

- https://bnsf.railpermitting.com
- https://jllrpg.360works.com/fmi/webd/rpo_web_kcs.fmp12
- Other Railroads:

### VI. RAILROAD COORDINATION MEETING


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### IX. EMERGENCY NOTIFICATION

tailroad Emergency
ergency Line at: 800-848-8715
DOT 743689L
18.430
Glidden



Texas Department of Transportation

Rail Division

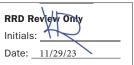FILE: rr-scop	e-of-work.pdf	dn: Tx	DOT	СК:	DW:		CK:	
© TxDOT	June 2014	CONT	SECT	JOB		HIGH		HWAY
0/0000	REVISIONS	0912	00	710		VARIOUS		IOUS
6/2023		DIST		COUNTY		SHEET		HEET NO.
		HOU		HARRIS				126

□ This project is adjacent or parallel work, not within RR ROW: DOT No.: 743688E

Crossing Type: At-Grade

RR Company Operating Track at Crossing: <u>Union Pacific Railroad Company (UP)</u>

RR Company Owning Track at Crossing: UPRR

RR MP: 17.620

RR Subdivision: Glidden

City: Missouri City

County: Fort Bend CSJ at this Crossing: 0912-00-710

Latitude: 29°37'25.70"N

Longitude: 95°31'34.50"W

Scope of Work, including any TCP, to be performed by State Contractor:

1) Pavement Markings

2) TCP(3-3)-14 & TCP(3-4)-13 3) Railroad and Contractor flaggers will coordinate with lane closures in vicinity of railroad. 4) All lanes across railroad tracks are to be open to traffic at the end of the day.

Scope of Work to be performed by Railroad Company:

N/A

#### II. FLAGGING & INSPECTION

No. of Days of Railroad Flagging Expected: 1

On this project, night or weekend flagging is:

Expected

Not Expected

Flagging services will be provided by:

□ Railroad Company: 1) Txdot will pay flagging invoices. Flagging Agreement with railroad will be needed or, 2) Permitted crossing. Railroad company to provide flagging.

☑ Outside Party: Contractor will pay flagging invoices to be reimbursed by TxDOT

Contractor must incorporate flaggers into anticipated construction schedule. The Railroad requires a 30-day notice if their flaggers are to be utilized. If Contractor falls behind schedule due to their own negligence and is not ready for scheduled flaggers, any flagging charges will be paid by Contractor.

Contact Information for Flagging:

☑ UPRR UP.info@railpros.com Call Center 877-315-0513, Select #1 for flagging UP.request@nrssinc.net Call Center 877-984-6777

- BNSF BNSFinfo@railprosfs.com Call Center 877-315-0513, Select #1 for flagging
- CPKCR KCS.info@railpros.com Call Center 877-315-0513, Select #1 for flagging Bottom Line On-Track Safety Services bottomline076@aol.com, 903-767-7630

OTHERS:

#### Contractor must incorporate railroad construction inspection into anticipated construction schedule.

☑ Not Required

□ Required. Contact Information for Construction Inspection:

#### III. CONSTRUCTION WORK TO BE PERFORMED BY THE RAILROAD

Required.
Regulieu.

☑ Not Required

Railroad Point of Contact:

Coordinate with TxDOT for any work to be performed by the Railroad Company. TxDOT must issue a work order for any work done by the Railroad Company prior to the work being performed.

#### IV. RAILROAD INSURANCE REQUIREMENTS

The Contractor shall confirm the insurance requirements with the Railroad as the insurance limits are subject to change without notice.

Insurance policies and corresponding certificates of insurance must be issued by the contractor on behalf of the Railroad. Separate insurance policies and certificates are required when more than one Railroad Company is operating on the same right of way, or when several Railroad Companies are involved and operate on their own separate right of ways.

No direct compensation will be made to the Contractor for providing the insurance coverages shown below or any deductibles. These costs are incidental to the various bid items.

Escalated Limits						
Type of Insurance	Amount of Coverage (Minimum)					
Workers Compensation	\$500,000 / \$500,000 / \$500,000					
Commercial General Liability	\$2,000,000 / \$4,000,000					
Business Automobile	\$2,000,000					

#### **Railroad Protective Liability Limits**

- Not Required
- \$2,000,000 / \$6,000,000 ☑ Non - Bridge/Typical Maintenance Projects. Includes repairs to overpass/underpass and culvert structures \$5,000,000 / \$10,000,000
- □ Bridge Structure Projects. Includes new construction or replacement of overpass/ underpass structures

Other:

Initials:

# □ Not Required

BNSF:

To view previously approved CROE templates agreed upon between the State and Railroad, see: https://www.txdot.gov/business/resources/railroad-highway-crossing/sample-right-of-entryagreements.html

Approved CROE templates are not to be modified by the Contractor.

Contractor shall not operate within Railroad Right of Way without an executed Construction & Maintenance Agreement between the State and the Railroad and an executed CROE between the Contractor and the Railroad if required on project.

### VII. RAILROAD SAFETY ORIENTATION

UPRR, BNSF, CPKCR will not accept on-track safety training certificates from other Railroads. Refer to each Railroad's specific contractor right of entry for training information.

Know and follow the Contractor's Right of Entry Agreement EXHIBIT D, MINIMUM SAFETY REQUIREMENTS regarding clothing, personal protective equipment, and general safety requirements.

**VIII. SUBCONTRACTORS** 

In Case of R Call: UPRR Railroad Em Location: DO

**RR** Milepost Subdivision:

### V. CONTRACTOR'S RIGHT OF ENTRY (CROE)

- ☑ Required: UPRR Maintenance Consent Letter. TxDOT to assist
- □ Required: TxDOT to assist in obtaining the UPRR CROE
- □ Required: Contractor to obtain

- https://bnsf.railpermitting.com
- https://jllrpg.360works.com/fmi/webd/rpo_web_kcs.fmp12
- Other Railroads:

### VI. RAILROAD COORDINATION MEETING


A Railroad Coordination Meeting is required. See item 5, Article 8.1, of the Standard Specifications for Construction and Maintenance of Highways, Streets and Bridges Manual for more details.

A. Complete the Railroad's course "Orientation for Contractor's Safety," and maintain registration prior to working on the Railroad's property. This course is required to be completed annually by Contractor and Subcontractor personnel working on site.

Contractor shall not subcontract work without written consent of TxDOT. Subcontractors are subject to the same insurance requirements as the Prime Contractor

### IX. EMERGENCY NOTIFICATION

ailroad Emergency
ergency Line at: 800-848-8715
DOT 743688E
17.620
Glidden

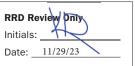

Texas Department of Transportation

Rail Division

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#### PART 1 - GENERAL

#### DESCRIPTION 1.01

This project includes construction work within the right of way and/or properties of the Railroad and adjacent to its tracks, wire lines and other facilities. These sheets describe the minimum special requirements for coordination with the Railroad when working upon, over or under Railroad Right of Way or when impacting current or future Railroad operations. Coordinate with the Railroad while performing the work outlined herein, and afford the same cooperation with the Railroad as with TxDOT. Complete all submittals and work in accordance with TxDOT Standard Specifications, Railroad Guidelines and AREMA recommendations as modified by these minimum special requirements or as directed in writing by the Railroad Designated Representative.

For purposes of this project, the Railroad Designated Representative is the person or persons designated by the Railroad Manager of Industry and Public Projects to handle specific tasks related to the project.

#### 1.02 REQUEST FOR INFORMATION / CLARIFICATION

Submit Requests for Information ("RFI") involving work within any Railroad Right of Way to the TxDOT Engineer. The TxDOT Engineer will submit the RFI to the Railroad Designated Representative for review and approval for RFI's corresponding to work within Railroad Right of Way. Allow six (6) weeks total time for review and approval, which includes four (4) weeks for review and approval by the Railroad.

#### 1.03 PLANS / SPECIFICATIONS

TxDOT has received written Railroad approval of the plans and specifications for this project. Any revisions or changes in the plans after award of the Contract must have the approval of TxDOT and the Railroad.

#### PART 2 - UTILITIES AND FIBER OPTIC

Construct all utility installations in accordance with current AREMA recommendations, Railroad, TxDOT and owning utility specifications and requirements. Railroad general guidelines can be found on the Railroad website or by contacting the Railroad Designated Representative.

#### PART 3 - CONSTRUCTION

#### 3.01 GENERAL

- A. Perform all work in compliance with all applicable Railroad, Federal Railroad Administration (FRA), and TxDOT rules and regulations. Arrange and conduct work in a manner that does not endanger or interfere with the safe operation of the tracks and property of the Railroad and the traffic moving on such tracks, or the wires, signals and other property of the Railroad, its tenants or licensees, at or in the vicinity of the Work. The safe operation of railroad train movements takes precedence over any work to be performed by the Contractor. The Contractor is responsible for train delay cost and lost revenue claims due to any delays or interruption of train operations resulting from Contractor's construction or other activities.
- B. Construction activities within 15 feet of the operational tracks will only be allowed if absolutely necessary and the Railroad's Designated Representative grants approval. Construction activities within 15 feet of the operational track(s) preferably allow the tracks to stay operational. In such cases, coordination and approval by the Railroad Track Manager is required with regard to schedule, flagging, and slow orders. See Sections 3.07 and 3.08 for additional information.
- C. Provide track protection for all work equipment (including rubber tired equipment) operating within 25 feet from nearest rail. When not in use, keep Contractor machinery and materials at least 50 feet from the Railroad's nearest track.
- D. Vehicular crossings of railroad track are allowed only at existing crossings, or haul road crossings developed with Railroad approval.
- E. The Contractor is also advised that new railroad facilities these facilities are delineated in the plans. Be aware of the limits of responsibilities and coordinate efforts with the Railroad and TxDOT.
- F. Railroad requirements do not allow work within 50 feet of track centers when a train passes the work site and all personnel must clear the area within 50 feet of the track may be pursued as outlined in 3.02 and 3.03.
- G. All permanent clearances shall be verified before project closing.

#### 3.02 RAILROAD OPERATIONS

- A. Trains and/or equipment are expected on any track, at any in either direction. Become familiar with the train time, schedules in this location and structure bid assuming intermittent track windows in this period, as defined in Paragraph B that follows.
- B. All railroad tracks within and adjacent to the contract site are active, and rail traffic over these facilities shall be maintained throughout the Project. Activities may include both through moves and switching moves to local customers. raircad traffic and operations will occur continuously throughout the day and night on these tracks and shall be maintained at all times as defined herein. Coordinate and schedule the work so that construction activities do not interfere with railroad operations.
- C. Coordinate work windows with TxDOT and the Railroad's Designated Representative. Types of work windows include Conditional Work Windows and Absolute Work Windows, as defined below:
  - Conditional Work Window: A Conditional Work Window is a period of time that railroad operations have priority over construction activities. When construction activities may occur on and/or adjacent to the railroad tracks within 25 feet of the nearest track, a railroad flag person will be required. At the direction of the railroad flag person, upon approach of a train, and when trains are present on the tracks, the tracks must be cleared (i.e., no construction equipment, materials or personnel within 25 feet, or as directed by the Railroad Designated Representative, from the tracks). Conditional Work Windows are available for the Project.
  - 2. Absolute Work Window: An Absolute Work Window is a period of Absolute Work Window: An Absolute Work Window is a period of time that construction activities are given priority over railroad operations. During this time frame, the designated railroad track(s) will be inactive for train movements and may be fouled by the Contractor. At the end of an Absolute Work Window, the railroad tracks and/or signals must be completely operational for train operations and all Railroad, Public Utilities Commission (PUC) and FRA requirements, codes and regulations for operational tracks must be satisfied. In the situation where the operational tracks and/or signals bave been affected the Railroad operating tracks and/or signals have been affected, the Railroad will perform inspections of the work prior to placing that track back into service. Railroad flag persons will be required for construction activities requiring an Absolute Work Window. Absolute Work Windows will not generally be granted. Any request will require a detailed explanation for Railroad review.

#### 3.03 RIGHT OF ENTRY. ADVANCE NOTICE AND WORK STOPPAGES

- A. Do not perform any work within Railroad Right of Way without a valid executed Right of Entry Agreement if required on this project.
- B. Give advance notice to the Railroad as required in the "Contractor's Right of Entry Agreement" before commencing work in connection with construction upon or over Railroad Right of Way and observe the Railroad's rules and regulations with respect thereto.
- C. Perform all work upon Railroad Right of Way in a manner to avoid interference with or endanger the operations of the Railroad. Whenever work may affect the operations or safety of trains, submit the work method to the Railroad Designated Representative for approval. Approval does not relieve the Contractor from liability. Do not commence any work which requires flagging service or inspection service until the flagging protection required by the Railroad is available at the job site. See Section 3.15 for railroad flagging requirements.
- D. Make requests in writing for both Absolute and Conditional Work Windows, at least 30 days in advance of any work. Include in the written request: Exactly what the work entails.

  - The days and hours that work will be performed. The exact location of work, and proximity to the tracks. The type of window requested and the amount of time requested. 3.
- The designated contact person.

Provide a written confirmation notice to the Railroad at least 48 hours before commencing work in connection with approved work windows when work is within 25 feet of nearest rail. Perform all work in accordance with previously approved work plans.

E. Make provisions to protect operations and property of the Railroad should . Make provisions to protect operations and property of the Railroad should a condition arising from, or in connection with the work, require immediate and unusual action. If in the judgment of the Railroad Designated Representative such provisions are insufficient, the Railroad Designated Representative may require or provide such provisions as deemed necessary. In any event, such provisions shall be at the Contractor's expense and without cost to the Railroad or TxDOT. The Railroad or TxDOT shall have the right to order the Contractor to temporarily cease operations in the event of an emergency or, if in the opinion of the Railroad Designated Representative, the Contractor's operations could endanger railroad operations. In the event of such an order, immediately notify TxDOT of the order.

#### INSURANCE 3.04

"UPRR,BNSF,KCS/TEXMEX will not accept on-track safety training certificates from other railroads. Refer to Railroad specific contractor right of entry for training information."

#### 3.06 COOPERATION

#### MINIMUM CONSTRUCTION CLEARANCES FOR FALSEWORK AND OTHER 3.07 TEMPORARY STRUCTURES

of construction:

#### 3,08

Do not begin work upon or over Railroad Right of Way until furnishing the Railroad with the insurance policies, binders, certificates and endorsements required by the "Contractor's Right of Entry Agreement", and until the Railroad Designated Representative has advised TxDOT that such insurance is in accordance with the Agreement.

#### 3.05 RAILROAD SAFETY ORIENTATION

A. Complete the railroad course "Orientation for Contractor's Safety", and maintain current registration prior to working on railroad property. This course is required to be completed annually by Contractor and Subcontractor personnel working on site.

Know and follow the "Contractor's Right of Entry Agreement" EXHIBIT D, MINIMUM SAFETY REQUIREMENTS regarding clothing, personal protective equipment, and general safety requirements.

The Railroad will cooperate with Contractor so that work may be conducted in an efficient manner, and will cooperate with Contractor in enabling use of Railroad Right of Way in performing the work.

Abide by the following minimum temporary clearances during the course

A. 15' - 0" (BNSF) (UPRR) and 14'-0" (KCS) horizontal from

centerline of track B. 22' (KCS) and 21' - 6" (UPRR & BNSF) vertically above top of rail.

For construction clearance less than listed above, obtain local Railroad Operating Unit review and approval.

#### APPROVAL OF REDUCED CLEARANCES

A. Maintain minimum track clearances during construction as specified in Section 3.07.

B. Submit any proposed infringement on the specified minimum clearances to the Railroad Designated Representative through TXDOT at least 30 days in advance of the work. Do not proceed with such infringement without written approval by the Railroad Designated Representative.

C. Do not commence work involving an approved infringement without receiving written assurance from the Railroad Designated Representative that arrangements have been made for any necessary flagging service.

SHEET 1 OF 2								
Texas Department	of Tra	nsp	ortation	,		Rail vision		
RAILROAD REQUIREMENTS FOR NON-BRIDGE CONSTRUCTION PROJECTS								
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#### 3.09 MAINTENANCE OF RAILROAD FACILITIES

- A. Maintain all ditches and drainage structures free of silt or other aceas and any other damage within Railroad Right of Way and repair any other damage to the property of the Railroad, or its tenants.
- B. Perform all such maintenance and repair of damages due to the Contractors's operations at Contractor's expense.
- C. Submit a proposed method of erosion control for review by the Railroad prior to beginning any grading on the project site. Comply with all applicable local, state and federal regulations when developing and implementing such erosion control.

#### 3. 10 SITE INSPECTIONS BY RAILROAD'S DESIGNATED REPRESENTATIVE

- A. In addition to the office reviews of construction submittals, Representative at significant points during construction, including the following if applicable:
- Pre-construction meetings.
   Pile driving/drilling of caissons or drilled shafts.
   Reinforcement and concrete placement for railroad bridge
- substructure and/or superstructure.
- Erection of precast concrete or steel bridge superstructure. 4.
- Placement of waterproofing (prior to placing ballast on bridge deck). 6. Completion of the bridge structure.
- B. Site inspection is not limited to the milestone events listed above. Site visits to check progress of the work may be performed at any time throughout the construction as deemed necessary by the Railroad.
- C. Provide a detailed construction schedule, including the proposed temporary horizontal and vertical clearances and construction sequence for all work to TxDOT for submittal to the Railroad Designated Representative for review prior to commencement of work. Include the anticipated dates when the above listed events will occur. Update this schedule for the above listed events as necessary and each month at a minimum to allow the Railroad to schedule site inspections.

#### 3.11 RAILROAD REPRESENTATIVES

Railroad representatives, conductors, flag person or watch person will be provided by the Railroad at expense of TxDOT to protect Railroad facilities, property and movements of its trains or engines. In general, the Railroad will furnish such personnel or other protective services as follows:

- A. When any part of any equipment is standing or being operated within 25 feet, measured horizontally, from nearest rail of any track on which trains may operate, or when any object is off the ground and any dimension thereof could extend inside the 25 foot limit, or when any erection or construction activities are in progress within such limits, regardless of elevation above or below track.
- B. For any excavation below elevation of track subgrade if, in the opinion the Railroad Designated Representative, track or other railroad facilities may be subject to settlement or movement.
- C. During any clearing, grubbing, excavation or grading in proximity to railroad facilities, which, in the opinion of the Railroad Designated Representative, may endanger railroad facilities or operations.
- D. During any Contractor's operations when, in the opinion of the Railroad Designated Representative, railroad facilities, including, but not limited to, tracks, buildings, signals, wire lines, or pipe lines, may be endangered.
- E. Arrange with the Railroad Designated Representative to provide the adequate number of flag persons to accomplish the work.

#### 3.12 COMMUNICATIONS AND SIGNAL LINES

If required, the Railroad will rearrange its communications and signal lines, its grade crossing warning devices, train signals and tracks, and facilities that are in use and maintained by the Railroad's forces in connection with its operation at expense of TxDOT. This work by the Railroad will be done by its own forces and it is not a part of the Work words the contract Work under this Contract.

#### 3,13 TRAFFIC CONTROL

Coordinate any operations that control traffic across or around railroad facilities with the Railroad Designated Representative.

#### 3.14 CONSTRUCTION EXCAVATIONS AND BORING ACTIVITIES UNDER TRACK

- A. Take special precaution and care in connection with excavating and shoring. Excavations for construction of footings, piers, columns, walls or other facilities that require shoring shall comply with requirements of TxDOT, OSHA, AREMA and Railroad "Guidelines for Temporary Shoring".
- B. The project plans indicate whether there are fiber optic lines or other such telecommunications systems that require consideration. Regardless, contact the necessary call center to determine if such cable systems are present:

UPRR 1-800-336-9193 7:00 AM to 9:00 PM CST Monday-Friday except holidays, staffed 24 hrs/day for emergencies 48 hrs notice required

BNSF 1-800-533-2891 24 hour number 5 working days notice required

KCS 1-800-344-8377 Texas One Call, a 24 hour number 48 hrs notice required, excluding weekends and holidays

If a telecommunications system is buried anywhere on or near railroad property, coordinate with TxDOT, the Railroad and the Telecommunication Company(ies) to arrange for relocation or protective measures prior to beginning work on or near railroad property. Refer to the project General Notes for additional information.

C. Projects involving a boring or jack and bore operation under track such as drainage pipes or culverts and utilities require an installation plan reviewed and approved by the Railroad and TxDOT prior to proceeding with such construction. A railroad inspector and contractor assisted monitoring of ground and track movement is required to maintain sofe passage of rail traffic. Stop installation and do not allow passage of trains if movements in excess of 1/4 inch vertical or horizontal is detected in the tracks. Immediately repair the damage to the satisfaction of TxDOT and the Railroad before proceeding.

#### 3.15 RAILROAD FLAGGING

Per the Right of Entry Agreement for flagging, notify the Railroad Representative at least 10 working days in advance of Contractor's work and at least 30 working days in advance of any Contractor's work in which any person or equipment will be within 25 feet of nearest rail or as specified in the Contractor Right of Entry (CROE).

#### 3.16 CLEANING OF RIGHT-OF-WAY

When work is complete, remove all tools, implements, and other materials brought into Railroad Right of Way and leave the right of Way in a clean and presentable condition to the satisfaction of TxDOT and the Railroad.

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Texas Department	nt of Tra	nsp	ortation			Rail vision	
RAILROAD REQUIREMENTS FOR NON-BRIDGE CONSTRUCTION PROJECTS							
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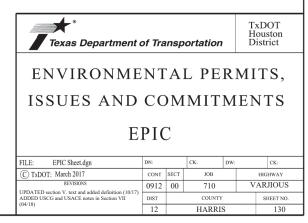
I. STORMWATER POLLUTION PREVENTION	III. CULTURAL RESOURCES	VI. HAZARDOUS
Texas Pollutant Discharge Elimination System (TPDES) TXR 150000: Stormwater Discharge Permit or Construction General Permit is required for projects with 1 or more acres disturbed soil. Projects with any disturbed soil must protect for erosion and sedimentation in accordance with Item 506. Refer to the TxDOT SWP3 Summary Sheets, SWP3 Binder Template, and Form 2118. No Additional Comments	Refer to TxDOT Standard Specifications in the event historical issues or archeological artifacts are found during construction. Upon discovery of archeological artifacts (bones, burnt rock, flint, pottery, etc.) cease work in the area and contact the Engineer immediately. No Additional Comments	Refer to TxDOT Star observed, such as der leaching or seepage of area and contact the No Ado
II. WORK IN OR NEAR STREAMS, WATERBODIES AND WETLANDS	IV. VEGETATION RESOURCES Preserve native vegetation to the extent practical. Refer to TxDOT Standard Specifications in order to comply with requirements for invasive species, beneficial	-
United States Army Corps of Engineers (USACE) Permit is required for filling, dredging,	landscaping and tree/brush removal.	
excavating or other work in water bodies, rivers, creeks, streams, wetlands or wet areas. The Contractor must adhere to all of the terms and general conditions associated with the	No Additional Comments	
following permit(s). If additional work not represented in the plans is required, contact the		VII. OTHER ENVI
Engineer immediately.		Comments:
No United States Army Corps (USACE) Permit Required		
Work is authorized by the United States Army Corps of Engineers (USACE) under a Nationwide Permit (NWP) without a Pre-Construction Notification (PCN). Project specific permit was not issued by USACE, therefore is not in the plan set. The USACE general conditions are in the "General Notes."		
Work is authorized by the United States Army Corps of Engineers (USACE) under a Nationwide Permit (NWP) with a Pre-Construction Notification (PCN). The project specific permit issued by the United States Army Corps of Engineers (USACE) is	V. FEDERAL LISTED, PROPOSED THREATENED, ENDANGERED SPECIES, CRITICAL HABITAT, STATE LISTED SPECIES, CANDIDATE SPECIES AND MIGRATORY BIRDS	
<ul> <li>included in the plan set. The USACE general conditions are in the "General Notes."</li> <li>Work is authorized by the United States Army Corps of Engineers (USACE) under a Individual Permit (IP). The project specific permit issued by the United States Army Corps of Engineers (USACE) is included in the plan set.</li> </ul>	If any of the listed species below are observed, cease work in the area, do not disturb species or habitat and contact the Engineer immediately. The work may not remove active nests (from bridges, structures, or vegetation adjacent	
Work would be authorized by the United States Army Corps of Engineers (USACE) permit. The project specific permit issued by the USACE will be provided to the contractor.	to the roadway, etc.) during nesting season (February 15 to October 1). If removal of structures or vegetation is necessary during the nesting season, the Contractor shall conduct a bird survey no more than 3 days in advance of the clearing/demolish start date. All bird surveys shall be conducted by a Field Biologist and adhere to the	
United States Coast Guard (USCG) Permit is required for projects that involve the construction or modification (including changes to lighting) of a bridge or causeway across a water body determined to be navigable by the United States Coast Guard (USCG) under Section 9 of the Rivers and Harbors Act. If additional work not represented in the plans is required, contact the Engineer immediately.	guidance document "Avoiding Migratory Birds and Handling Potential Violations" found in the TxDOT Environmental Compliance Toolkits at the time of the survey. (See below for Field Biologist and Ornithologist qualifications) No Additional Comments	
No United States Coast Guard (USCG) Coordination Required		
United States Coast Guard (USCG) Permit		
United States Coast Guard (USCG) Exemption		
No Additional Comments		
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	Field Biologist, Omithologist – a field biologist is defined as an individual qualified to perform field investigations, presence/absence surveys and habitat surveys for protected avian species or species of concern. A mandatory bachelor's degree in biology or a related science is required. At a minimum, the Field Biologist, Ornithologist, shall have completed and reported a minimum of three presence/absence and habitat surveys for protected avian species in the past five years. A minimum of three projects must have been conducted in Texas. Surveys shall have been performed for documentation of species in accordance with a protocol approved by USFWS or TPWD, or following generally accepted methodologies.	

## MATERIALS OR CONTAMINATION ISSUES

andard Specifications in the event potentially contaminated materials are ead or distressed vegetation, trash disposal areas, drums, canisters, barrels, of substances, unusual smells or odors, or stained soil, cease work in the Engineer immediately.

ditional Comments

IRONMENTAL ISSUES



Version 2.2